Brookfield

Properties

Ryan Wassum
Port Senior Planner

Dear Mr. Wassum,

Thank you for your completeness review comments for the Pier 70 Parcel A development on August 18, 2019. The design team has made necessary changes or provided additional information where necessary. The sheets referenced below correspond to where these changes have been made.

1. General Comments

a. D4D Compliance Table Zoning Narrative

Sheet G-001.2, Section 5.1 - Bicycle Parking - Retail tenants have not been determined, therefore, Brookfield has estimated a maximum of 10,307 SF of retail. This will likely be lower but not less than the required retail amount per the D4D.

Sheet G-003.1, Section B shows required retail in red with the potential added retail areas dashed in red.

b. Exterior Material Samples:

Exterior material board has been provided.

Sheets A-201 – A-206 describes the color of the MTL Cladding 1 material as gray/black simulated blackened steel.

Sheet G-003.4-G003.5, Section D – See narrative description on how proposed materials meet criteria for material treatment credits.

c. Printed versions of Sheet G-003.1 – New prints provided.

2. Site Plan / Floor Plans

- a. Bicycle Parking:
 - i. Sheet A-060 Site plan Class 2 bicycle parking spaces identified
 - ii. Sheet A-060 Site plan Bicycle repair station location identified
 - iii. Sheet G-001.9 Zoning Narrative Detail on Class 1 bicycle parking systems
- b. Curb Cuts: **Sheet C-02** See note on C-02 details for driveways are included in the Pier 70 SUD Phase 1 Improvement Plans, Permit 19IE 00245.

- c. Parking: **Sheet A-100 –** Parking count breakdowns by what is required and proposed has been provided.
- 3. Transition Strips (D4D Ch. 5.6)
 - a. Sheet A-303 Driveway slope and transition strips have been dimensioned.
- 4. Long Façade in Key Locations (D4D Ch.6.18)
 - **a. Sheet G-003.4 G-003.5, Sections B-C** Massing and modulation calculations and diagrams have been updated so that no architectural strategy is considered for both massing and modulation credits.
 - b. Sheet G-003.4, Sections C Amount has been updated
 - c. Sheet G003.4-G003.5, Section D Material areas for calculation have been dimensioned.

Regards,

Cutter MacLeod




PROJECT DESCRIPTION The Parcel A project is a Class A, speculative office building with ground floor retail elements and below grade parking consistent with the Pier 70 SUD, Design for Development (D4D) document dated May 22, 2018.

This project scope includes design of the core and shell of the speculative office building and will include the design of parking, loading, mechanical/plumbing/electrical infrastructure, core spaces, lobby and common spaces on the interior. Most of the building interior will be unfinished

Landscape – The plantings shown in this package are conceptual and subject to change. The planting design is in development and will be presented as part of the continued development exercise. The plantings shown on the ground floor and on west side, third floor common use terrace will be designed and installed as part of the core and shell work. The scope also includes design intent for other exterior terraces that will be part of tenant space, and not be common use on the fifth and sixth floors. On these terraces, the owner will build the planter boxes and irrigation infrastructure as part of the core and shell work. A planting list created by the core and shell team will be included in the tenant agreement. The tenants will be responsible for the plantings based on the planting list to be developed and provided in the tenant standards handbook. The street trees and other plantings in the ROW are designed and permitted separately under the Horizontal Work.

Lighting
The lighting shown in this package is conceptual and subject to change. The lighting design is in development and will be presented as part of the continued development exercise. The streetlights in the ROW are designed and permitted separately under the Horizontal Work.

VICINITY MAP

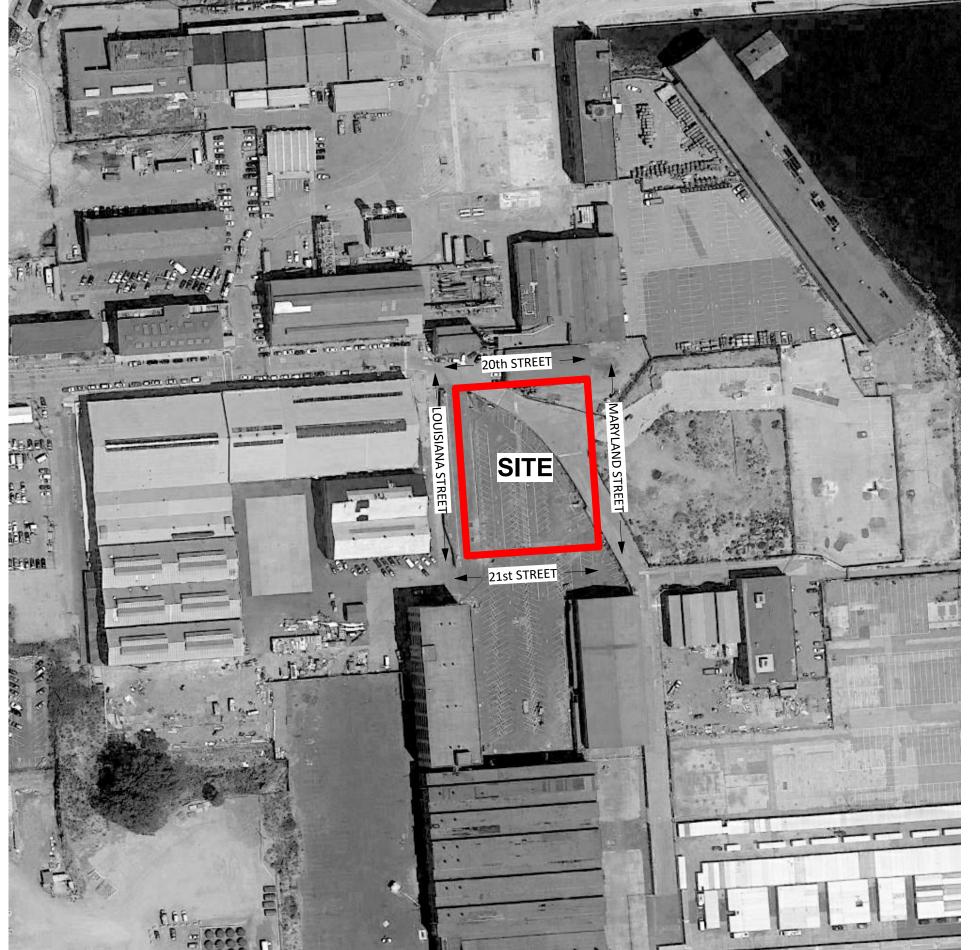

Mayor ED 17-02 Priority permit

HACKER

733 SW Oak, Portland, OR 97205

639 FRONT ST, SAN FRANCISCO, CA 94111

QA

CONSTRUCTION

REVISION NO.

KEY PLAN - (NTS)

TRUE PLAN NORTH

PIER 70

Brookfield

BROOKFIELD PROPERTIES PIER 70 PARCEL A

100% DESIGN DEVELOPMENT

A-060 A-100 A-101 LEVEL 1 A-102 LEVEL 2 A-103 LEVEL 3 A-104 LEVEL 4 A-105 LEVEL 5

SHEET INDEX

SITE PLAN

GENERAL INFORMATION

GENERAL INFORMATION

ZONING NARRATIVE

ZONING NARRATIVE

D4D COMPLIANCE

D4D COMPLIANCE

D4D COMPLIANCE

D4D COMPLIANCE

D4D COMPLIANCE

D4D COMPLIANCE

UTILITY PLAN

SITE PLAN AND GRADING

EROSION CONTROL PLAN

NOTES, LEGEND, AND ABBREVIATIONS

ARCHITECTURAL SYMBOLS AND ABBREVIATIONS

ZONING INFORMATION AND BUILDING TABULATIONS

GENERAL

G-000.1 G-000.2

G-000.3

G-000.4

G-001.1

G-001.2

G-001.3

G-001.5

G-001.6

G-001.7

G-001.8

G-001.9

G-003.1

G-003.2

G-003.3

G-003.4

G-003.5

G-003.6

C-02

C-03

C-04

G-002

A-106 A-107 **ROOF PLAN** A-201 **EXTERIOR ELEVATIONS** A-202 **EXTERIOR ELEVATIONS** A-301 BUILDING SECTIONS A-302 **BUILDING SECTIONS** A-303 **BUILDING SECTIONS**

A-310.1 **ENLARGED PLANS** A-310.2 **ENLARGED SECTIONS** A-310.3 **ENLARGED SECTIONS** A-601 PERSPECTIVE VIEWS PERSPECTIVE VIEWS

OWNER

BROOKFIELD DEVELOPMENT PROPERTIES 875 Howard Street, Suite 330 San Francisco, CA 94103

CMGC CONTRACTOR

SWINERTON 260 Townsend Street, San Francisco, CA 94107

PROJECT TEAM

ARCHITECT

HACKER 1516 SE 3rd Avenue, 5th Floor Portland, OR 97214 (503) 915-3454

QUEZADA ARCHITECTURE 639 Front Street, 1st Floor San Francisco, CA 94111(503) (415) 331-5133

INTERIOR DESIGN

452 Tehama Street San Francisco, CA 94103 (415) 932-2015

1120 Connecticut Avenue NW, Suite 1110

(202) 729-8216

ACOUSTIC DESIGN VIBRASURE 2440 16th Street, #317

San Francisco, CA 94103

Washington DC 20036 USA

(415) 946-8487 **IT/SECURITY**

7325 Puncheon Landing Road Pocomoke City, MD 21851 (703) 282-7808

STRUCTURAL

Portland, OR 97204

(503) 227-3251

(415) 432-8101

BOCA GROUP

(212) 983-7010

MEYERS+

111 SW Fifth Avenue, Suite 2600

98 Battery Street, Suite 502

VERTICAL TRANSPORTATION

8100 S. Flower Street, Suite 906

San Francisco, CA 94111

Los Angeles, CA 90017

560 14th St Suite # 300

255 Shoreline Drive, Suite 200

LANGO HANSEN LANDSCAPE ARCHITECTS

Oakland, CA 94612

Redwood, CA 94612

1100 NW Glisan #3B

Portland, OR 97209

(503) 295-2437

(650) 482-6300

LANDSCAPE

(510) 473-0300

PROJECT SCOPE

leasable space.

Properties

PROJECT NUMBER 1830


SEPTEMBER 16, 2019

SCALE 12" = 1'-0"

DRAWING TITLE **COVER SHEET**

SHEET NUMBER

G-000-1

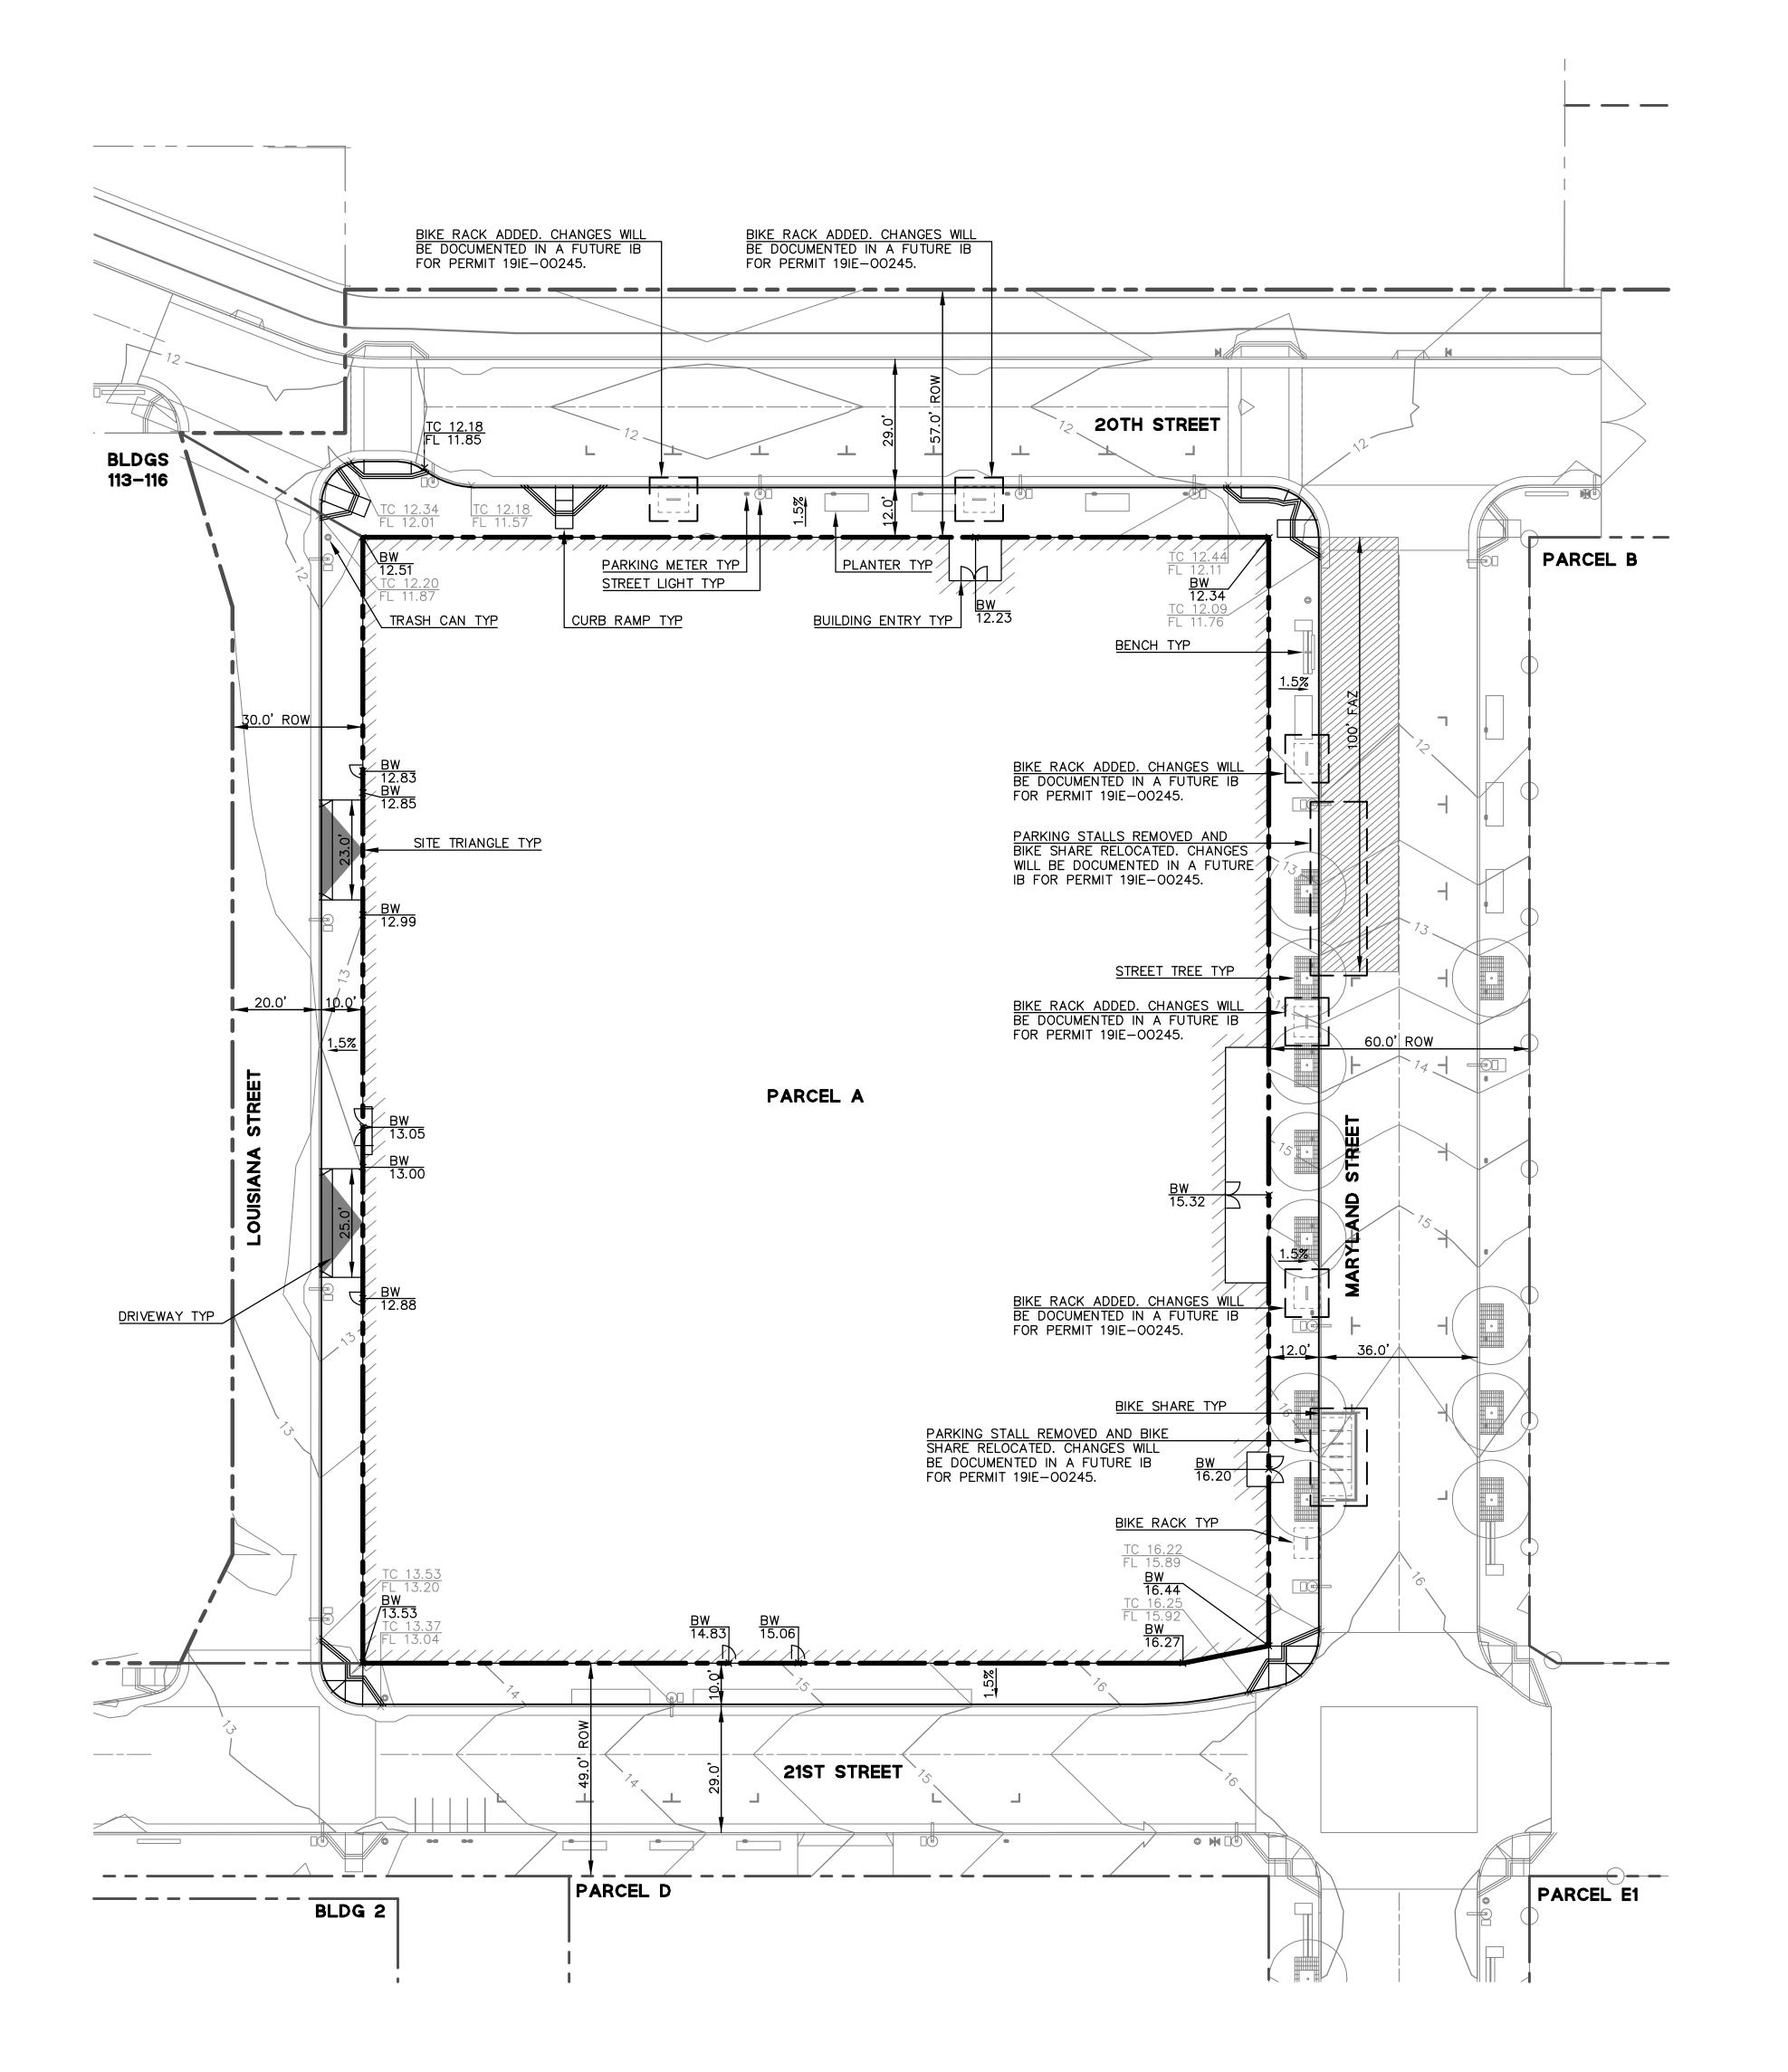

HACKER

733 SW Oak, Portland, OR 97205



639 FRONT ST, SAN FRANCISCO, CA 94111



Mayor ED 17-02 Priority permit

SITE PERMIT THIS APPLICATION SUBMITTED FOR SITE PERMIT ONLY. NO WORK MAY BE STARTED UNTIL CONSTRUCTION PLANS HAVE BEEN APPROVED.





DATE

REVISION NO.

KEY PLAN - (NTS)

TRUE PLAN NORTH

PIER 70

Brookfield Properties

BROOKFIELD PROPERTIES PIER 70 PARCEL A

ISSUANCE SITE PERMIT


PROJECT NUMBER 1830


SEPTEMBER 04, 2019


DRAWING TITLE SITE PLAN

SHEET NUMBER

G-000.2

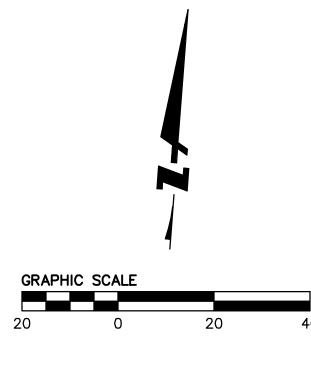

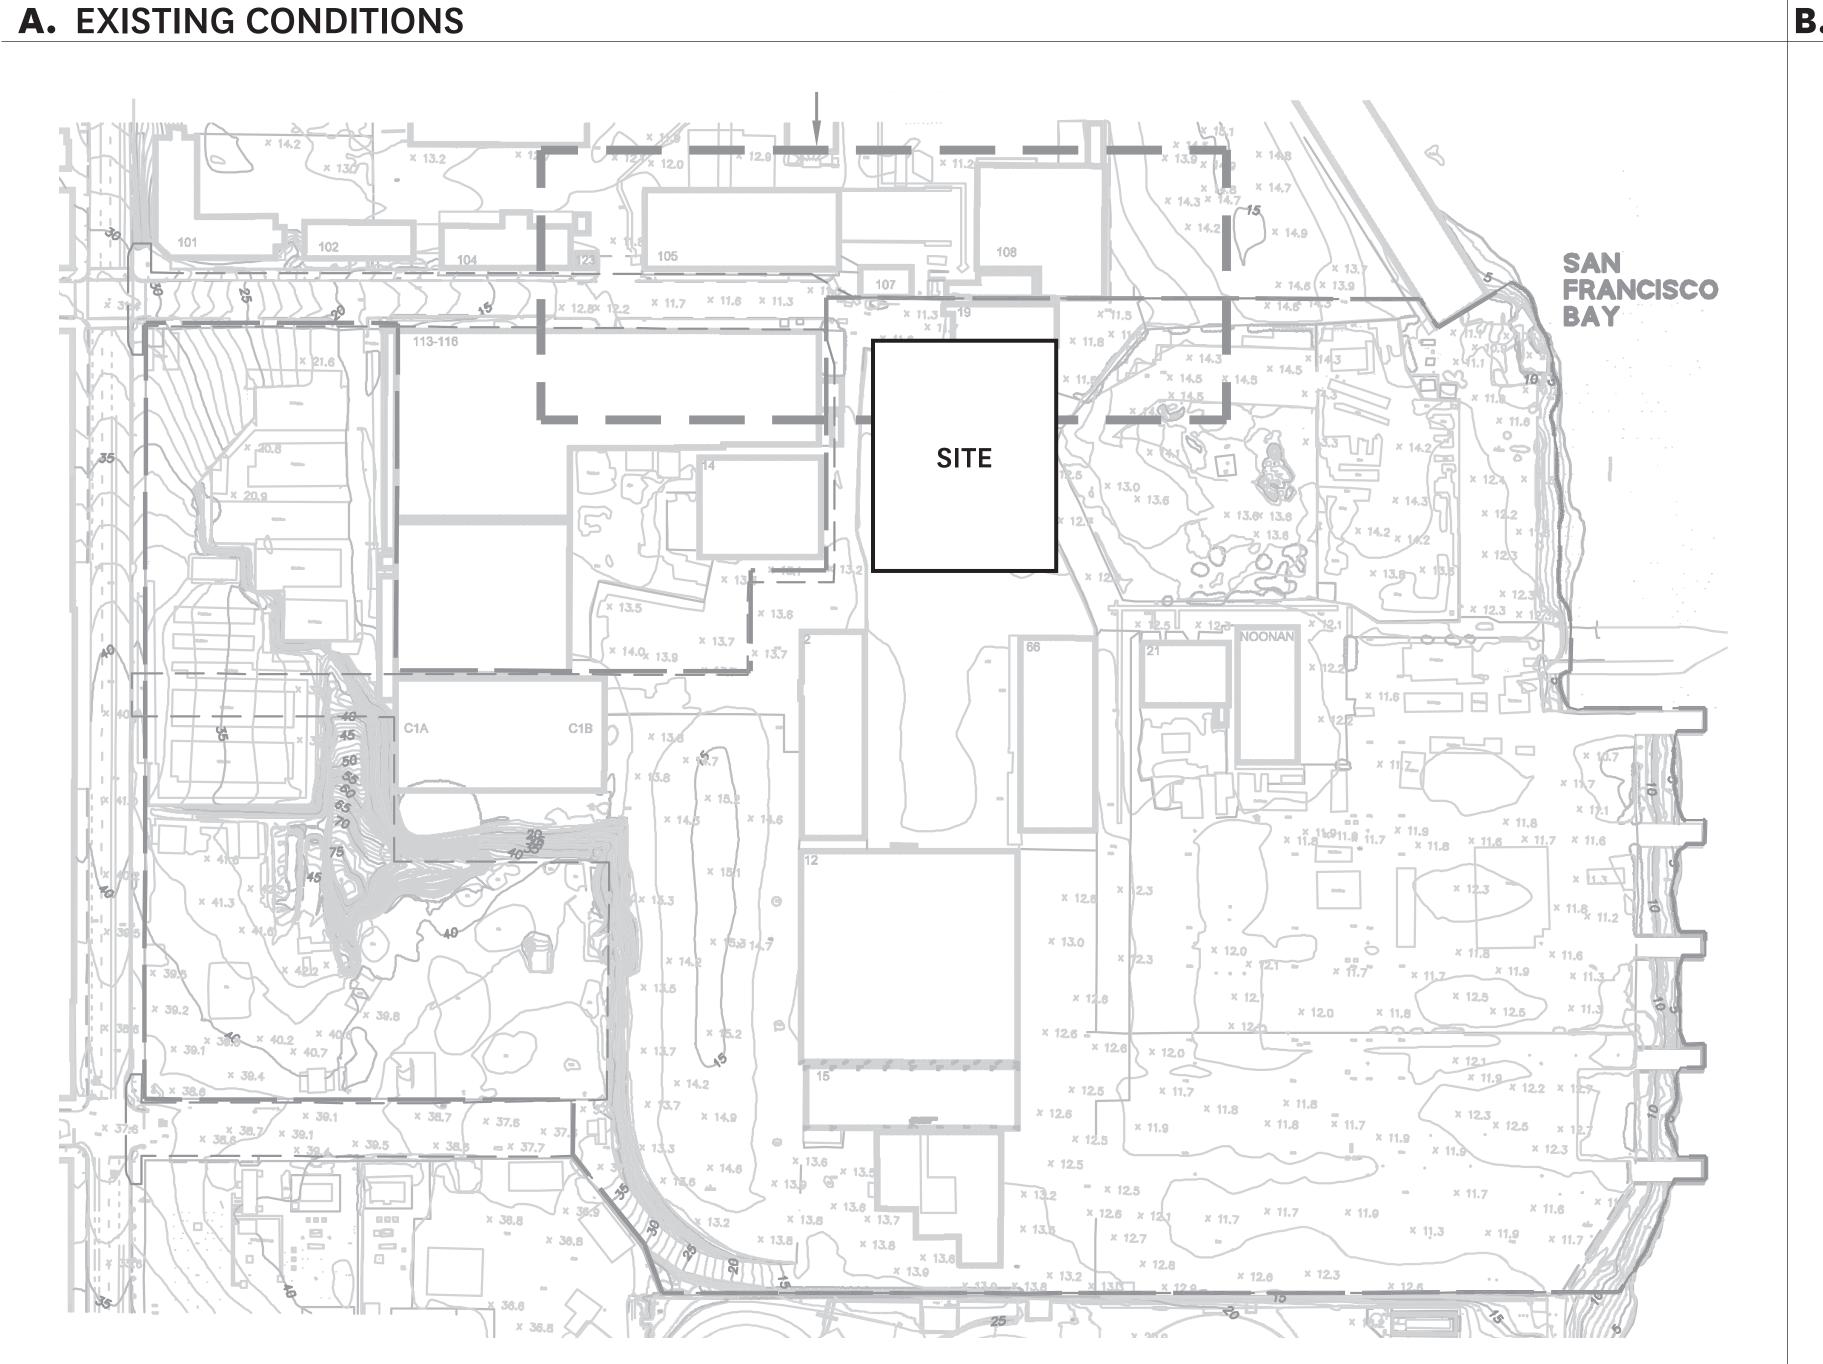


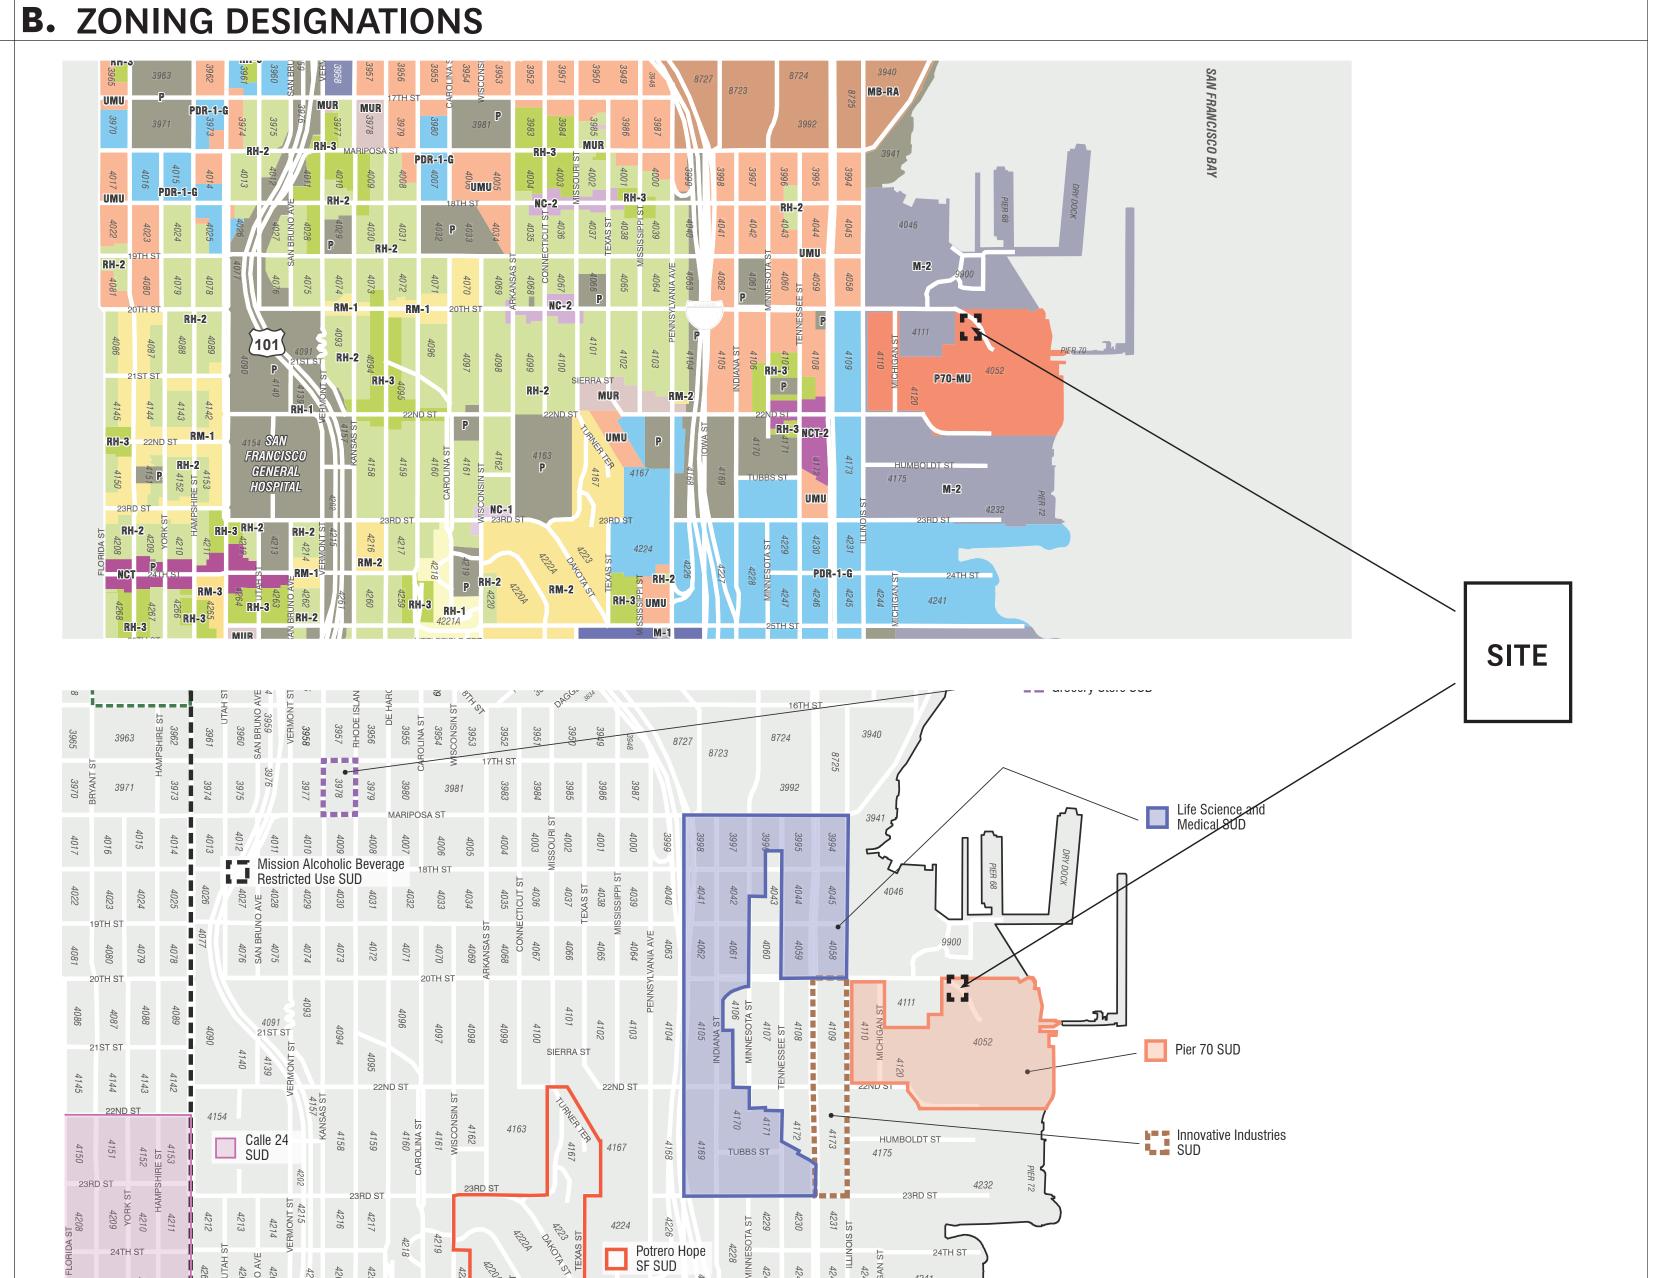

C. PROPOSED DEVELOPMENT



D. SITE CONTEXT

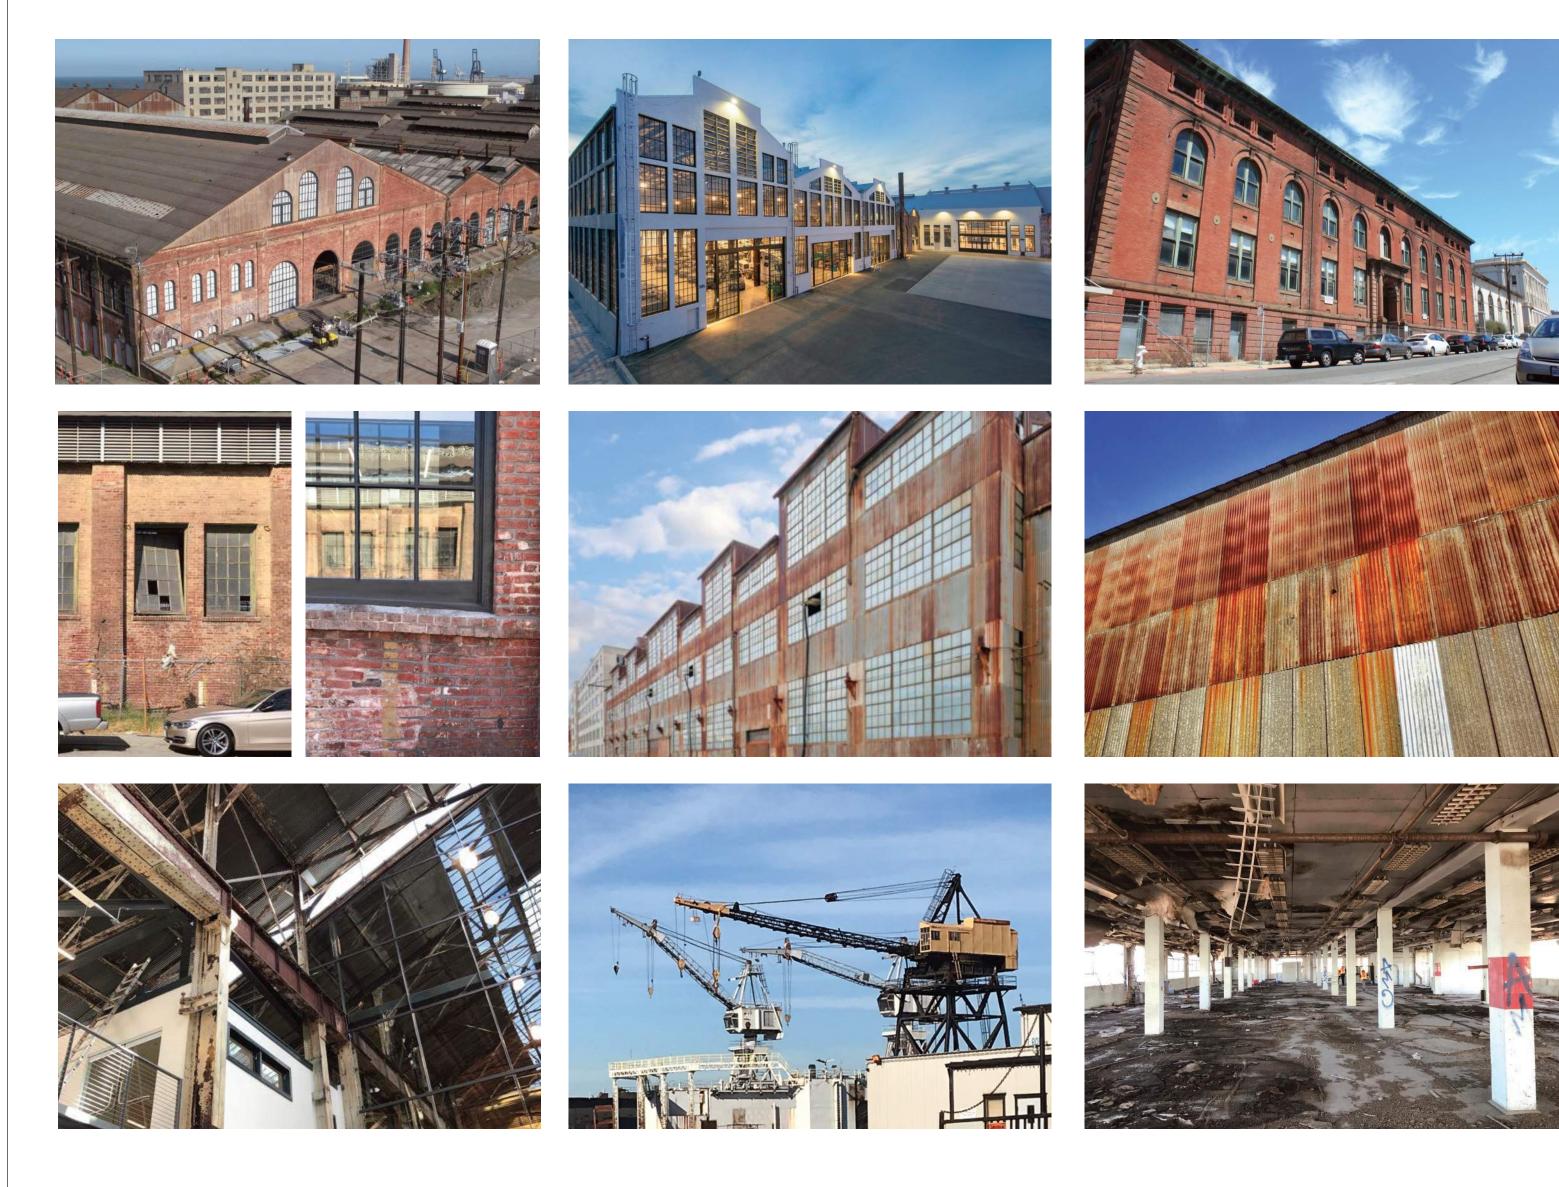

ARCHITEC

HACKER

733 SW Oak, Portland, OR 97205

QA

639 FRONT ST, SAN FRANCISCO, CA 94111

CONSULTANT

Mayor ED 17-02 Priority permit

STAMP

NOT FOR CONSTRUCTION

REVISION NO.

KEY PLAN - (NTS)

TRUE PLAN NORTH

PIER 70

BrookfieldProperties

BROOKFIELD PROPERTIES PIER 70 PARCEL A

ISSUANCE
DESIGN REVIEW PACKAGE

1830 DATE

PROJECT NUMBER

JULY 12, 2019
SCALE

DRAWING TITLE
GENERAL INFORMATION

SHEET NUMBER

G-000.3

A. EXISTING CONDITIONS **B.** EXISTING CONDITIONS



3RD FLOOR LOOKING NORTH



3RD FLOOR LOOKING EAST

C. EXISTING CONDITIONS



3RD FLOOR LOOKING SOUTH

D. EXISTING CONDITIONS



3RD FLOOR LOOKING WEST

HACKER

733 SW Oak, Portland, OR 97205

QA

639 FRONT ST, SAN FRANCISCO, CA 94111

Mayor ED 17-02 Priority permit

NOT FOR CONSTRUCTION

DATE

REVISION NO.

KEY PLAN - (NTS)

TRUE PLAN NORTH

PIER 70

Brookfield Properties

BROOKFIELD PROPERTIES PIER 70 PARCEL A

ISSUANCE
DESIGN REVIEW PACKAGE

PROJECT NUMBER 1830 JULY 12, 2019

DRAWING TITLE GENERAL INFORMATION

SHEET NUMBER

G-000.4

DESIGN SUMMARY

The proposed design of Parcel A is inspired by several particular aspects of Pier 70 and its existing buildings:

- · All existing buildings are expressive of their construction. They are a monumental scale of buildings, created of human scale elements, including sheet metal panels, small panes of glass, bricks, board formed concrete. The buildings are also expressive of their structure, which is typically exposed on the interior and reads through the façade.
- The Façade of adjacent Building 113 is composed of regular rhythms of consistent and well-proportioned elements. Regular piers march down the long north façade creating a textured pattern of light and shade.
- · The passage of time has added a patina and depth to the existing materials.
- ·The remnant of Irish Hill and its trees are an inspiring example of the persistence of nature, even in this thoroughly industrial site.
- The Parcel A design is intended to show influences of these aspects without mimicking the existing buildings. The design concept can be summarized by describing its structure, massing, modulation, material and nature.

Structure - The primary structure will be heavy timber composed of glue laminated beams/columns and cross laminated timber floor/roof decks. This material has a distinctive aesthetic appeal and is most optimized in a unique one-way structural logic that results in tight column spacing in one direction (approximately 15' on center) and broad column spacing in the other (approximately 30' on center). The use of wood beams, columns, and structural decks have led us to a façade concept that reveals the wood as an special aspect of the design that should be expressed. Windows are arranged to express the beauty and unique logic of the wood frame, not distracting from it.

Massing

The largest scale articulation of the design implements a "pinwheel" approach conceived as 4 large "masses" rotating around a center. The masses are elevated above a "base" that features more transparency for the lobby, retail/service, and active social uses on the ground floor. The base creates opportunity for entries, future entries, louvers and planters, with consistent human-scaled "ground floor niches" which help distinguish the base from the upper portions of the building.

Each mass expresses a long side and a short side to the surrounding streets. The long sides feature piers based on the tight column spacing. The short side's piers are based on the broad column spacing. The masses are set apart by "gaps" or vertical recesses in the façade that are cues highlighting the entry points. The gaps on the north and south sides are narrow while the gaps on the east and west sides are wider creating roof terraces on the third floor of the building, maximizing daylight penetration to the interior of the large block. The short side of each mass projects occupiable space over the property line, and features occupiable terraces on the top two floors. The terraces create pleasant outdoor space for the tenants, taking advantage of the best views of the neighborhood, bay, and San Francisco's city center. The northwestern terrace coincides with the "Setback for View" required in the D4D as a reference to the height of adjacent historic Building 113.

Modulation

The scale of the modulation borrows several proportions from Building 113, forming the medium scale articulation for the building. The facades are articulated with horizontal shadow lines, or "ledges," at one- or two-story intervals similar in proportion to the long sides of Building 113. The ledges extend across the facades as datums that are extensions of the voids created by the corner roof terraces. Ledges wrap into the gaps and reset to

other floors on the adjacent mass. Vertical piers between the horizontal ledges march along at regular intervals. Similar to the texture of Building 113's long, north side, the piers create horizontal bands of texture. Piers also feature 6" deep bevels. Bevels do not align above and below the ledges bringing a sense of playfulness to the façade and creating alternating patterns of light, shade and shadow. The windows between piers extend from a sill height to the underside of the floor or roof deck above. Like Building 113, the vertical windows maximize daylight penetration into the interior and feature occasional operable sashes for natural ventilation. Additional areas of maximized glazing punctuate the facades, identifying interior spaces where, in some cases, floor panels can be removed to create floor-to-floor connections if a single tenant leases more than one floor. While the pier patterns articulate the four pinwheeling masses, the backs of the gaps are intentionally mostly glass as a place for the observer's eye to rest between patterns and as a means of improving daylight penetration. These areas of maximum glazing will include vertical and horizontal mullions with protruding snap caps that carry a simple pattern that does not distract from the structure inside.

Material

- The material is intended to have similar visual interest and depth as the weathered materials visible throughout historic Pier 70.
- The piers will be clad with aluminum that is attached with concealed fasteners. The aluminum will be finished with a highly detailed multi-layered coating that simulates blackened steel. The simulated finish allows the intended character to be present from the onset and be consistent for the life of the project. The dark cladding will stand in contrast to the light warm color of the wood frame inside.
- · Ground floor niches will be clad in the same cladding material used on the façade piers.
- · Window mullions will be a dark bronze color designed to recede in space and disappear against the interior during the day.
- The areas of spandrel glazing that happen mostly at floor lines will be back-painted glass with a color also designed to disappear against the interior during the day.
- ·Service areas, terrace planters, louvers, overhead doors and walls between the overhead doors will be a dark bronze color to match the window mullions. They are intended to recede in space yet pair well with the more interesting cladding material used on the bulk of the facades. The mechanical screen on the roof will be the same material but will also be perforated.
- Due to sea level rise requirements, the ground floor of the building is set at an elevation that is higher than adjacent grade for most of the building's perimeter, creating a plinth that the building stands upon. The plinth will be finished with a board formed concrete material to create an interesting durable surface that is reminiscent of adjacent historic buildings.

Nature

Finally, the proposal will integrate plantings as a living element in the design. Planters will be integrated into the pedestrian experience as part of the ground floor niches. At the terraces, planters will create edges and foreground for the distant views.

D4D COMPLIANCE TABLE

Title	Reference	Standard	Required	Provided	Compliance Notes
2 Land Use					
2.1 Zoning and Land Use					
Land Use	S2.1.1	Pier 70-MU Accessory Uses limited to 33% floor area Accessory parking limited to 50% floor area		Commercial Office Accessory Parking	See Diagram B/G-003.1
Dwelling Unit Density	S2.1.2	Density not limited by lot area		NA	No proposed Residential.
Publicly Oriented Accessory Retail Uses in Parks & Open Spaces	S2.1.3	Allowed, subject to approval per Pier 70 DDA		N/A	No proposed accessory retail in parks or open spaces.
Off-Street Parking	S2.1.4	Parking structures allowed on C1 & C2 only Permitted as accessory on all others		Complies	Proposed parking is accessory.
Interim Uses	S2.1.5	Permitted in accordance with SUD 249.79		NA	No proposed interim uses.
2.2 Ground Floor uses					
Measuring Frontages	S2.2.1	Linear extent fronting ROW Measured by linear feet for each zone Excludes space for building services		Complies	Acknowledged.
Measuring Corners	S2.2.2	20th, 22nd, Maryland: 75' from the intersection All other: 50' from the intersection Limited Uses for minimum 50% of shaded area		Complies	Acknowledged.
Priority Retail Frontages	S2.2.3	Minimum 25' depth Maximum of 40' of lobby counts toward compliance		Complies	See Diagram B/G-003.1
Retail & Service Frontages	S2.2.4	Limited Uses for minimum 50% of shaded area Minimum 25' depth		Complies	Tenants are not yet identified. However priority retail uses as listed in S2.2.3 will be located at SE corner. See Diagram B/G-003.1
Ground Floor Office Frontage	S2.2.5	Limited on 20th & 22nd Shall not exceed 75% of designated parcels		Complies	Tenants are not yet identified. However, tenant agreements will stipulate maximum 75% of north frontage (20th Street) will be ground floor office use. 25% of frontage will be uses listed in S2.2.4 located in NE corner. See Diagram B/G-003.1
Ground Floor Office Frontages	G2.2.1	Commercial spaces >30' long should make social or common functions visible to activate the street edge		Complies	Tenants are not yet identified. However, tenant agreements will stipulate social or common functions in this area. Part of the north frontage social common area is planned to be a "Bike Lounge". See Diagram B/G-003.1

ADCHITECTS

HACKER

733 SW Oak, Portland, OR 97205

QA

639 FRONT ST, SAN FRANCISCO, CA 94111

CONSULTAN⁻

Mayor ED 17-02 Priority permit

MP

NOT FOR CONSTRUCTION

DATE

REVISION NO.

KEY PLAN - (NTS)

TRUE PLAN NORTH

PIER 70

BrookfieldProperties

BROOKFIELD PROPERTIES
PIER 70 PARCEL A

ISSUANCE
DESIGN REVIEW PACKAGE
PROJECT NUMBER
1830

JULY 12, 2019
SCALE

DRAWING TITLE
ZONING NARRATIVE

5 Parking and Loading					
5.1 Bicycle parking		Class 1 & 2 provided in accordance with parking minimums per use as indicated in Planning code Minimum 5% of Class 1 for cargo bikes Class 2: Retail Sales and Services Uses: Minimum two spaces. One Class 2 space for every 2,500 sq. ft. of Occupied Floor Area. For uses larger than 50,000 occupied square feet, 10 Class 2 spaces plus one Class 2 space for every additional 10,000 occupied square feet.	Retail Sales and Services SF (Max. Estimated - tenants are not determined but maximum is accounted for to accommodate appropriate bike parking): 10,317 SF Office SF: 246,167 SF Class 2: 10,317 SF/ 2,500 sf= 4 spaces	12 Class 1 Bike Parking Spaces Provided	
Bicycle Parking Capacity	S5.1.1	Office: Minimum two spaces for any Office Use greater than 5,000 square feet of Occupied Floor Area, and one Class 2 space for each additional 50,000 occupied square feet.	2 min. for 5,000 sf + (241,167 sf/ 50,000 sf= 5	152 Class 2 Bike Parking Spaces Provided	Current design spec = Lift Assist Dero Decl (4 bikes per unit)
		Class 1: Retail Sales and Services Uses: One Class 1 space for every 7,500 square feet of Occupied Floor Area.	10,317 SF/ 7,500 SF = 2 spaces 246,167 SF/ 5,000 SF = 50 spaces 52 Class 1 spaces total required		
		Office: One Class 1 space for every 5,000 square feet of Occupied Floor Area.			
Class 1 Bicycle Parking Location	S5.1.2	Residential: maximum 250' from building entrance Commercial: maximum 100' from building entrance Retail, Arts, Industrial: max. 250' from entrance		Complies	Class 1 parking is located at the ground floo north frontage "Bike Lounge". See Diagram B/G-003.1
Class 1 Bicycle Parking Signage	S5.1.3	Signage at lobby and any basement access points		Complies	Signs will be located as shown on Diagram 003.1
Class 2 Bicycle Parking Location	S5.1.4	ROW, setbacks, or open space within 100' of entrance		Complies	Located 100' from entrances as part of the Horizontal Work permitted separately. See sheet G-000.2 for reference.
Bicycle Parking Design	S5.1.5	Consistent with Planning Code Lift-assist racks can fufill 100% of Class 1 req. Vertical can fulfill 50% of req.		Complies	Current design spec = Lift Assist Dero Decl (4 bikes per unit) Fulfills 100 percent of c 1 parking requirements per D4D
		Consistent with Planning Code One repair stand per building			
Bicycle Support	S5.1.6	Non-Retail Sales and Services Uses (Office): One shower and six clothes lockers where the Occupied Floor Area exceeds 10,000 square feet but is no greater than 20,000 square feet, Two showers and 12 clothes lockers where the Occupied Floor Area exceeds 20,000 square feet but is no greater than 50,000 square feet, Four showers and 24 clothes lockers are required where the Occupied Floor Area exceeds 50,000 square feet.	Office: >50,000 sf = 4 showers and 24 lockers Retail: 27,265 sf = one shower & 6 lockers Total required = 5 showers & 30 lockers	Complies, 6 showers and 67 lockers	
		Retail Sales and Services: One shower and six clothes lockers where the Occupied Floor Area exceeds 25,000 square feet but is no greater than 50,000 square feet Two showers and 12 clothes lockers where the Occupied Floor Area exceeds 50,000 square feet.			
Bike-Share	S5.1.7	One station recommended near E2		NA	A bike share location is planned on Maryla adjacent to Parcel A. It is included in the Horizontal Work permitted separately. See sheet G-000.2 for reference. Currently Locat 20th St & Maryland Street. Proposed to move to 21st Street and Maryland Street in accordance with required fire aerial access zone stipulated by Port Fire.
Bicycle Parking Access	G5.1.1	Access to bicycle parking areas should be direct and clearly indicated with signage.		Complies	Class 1 bike parking will be in the "Bike Lounge" visible through the glass from the sidewalk on the north frontage. An interior access ramp will be provided for access to "Bike Lounge". Bike parking entry will be
Bike-Share Location	G5.1.2	Locations recommended to avoid obstructions to open spaces.		Complies	marked with signage. Exterior bike parking is provided on the Pa A side of Maryland by the Horizontal Work permitted separately. See sheet G-000.2 for reference.
Bicycle Parking Lighting	G5.1.3	Bicycle parking should be sufficiently lit for safety and functionality.		Complies	Interior lighting will be provided in the "Bike Lounge". Lighting for exterior parking will be provided in the Horizontal Work permitted separately. See sheet G-000.2 for reference
.3 On street parking & Passenger Loading					
On-Street Parking Locations	S5.3.1	20th Street & Maryland Street	See Figure 5.31	Complies	Included in the Horizontal Work permitted separately. See sheet G-000.2 for reference
ADA Parking Requirements	S5.3.2	1 per 25 spaces, 1 van per 6 spaces (1 minimum)	Reference CBC Chapter 11B for req.	6 spaces provided including 2 van spaces.	See sheet A-100
Universal Passenger Loading Zones	S5.3.3	Five ADA compliant locations within the Pier 70 site		NA	Included in the Horizontal Work permitted separately.
Universal Passenger Loading Zones	G5.3.1	Zones should be limited to 5 min stops. Located to provide convenient access to buildings.		NA	Included in the Horizontal Work permitted separately.
5.4 Off street parking Parking Maximums	OF 4.4	Office/commercials May northing 4 are as in a 4 500 OF and	251,000 SF / 1,500 SF=	Complies 140 and an area delete	
Parking Maximums	S5.4.1	Office/commercial: Max parking 1 space per 1,500 SF gross floor area Parking within residential or commercial buildings	167 spaces max.	Complies, 149 spaces provided	
Parking Location	S5.4.2	may be located either above- or below-grade in accordance with Section 6.13.		Complies (below grade)	
Residential Parking	S5.4.3	Residential parking shall primarily serve residential tenants.		N/A	

HACKER

733 SW Oak, Portland, OR 97205

QA

639 FRONT ST, SAN FRANCISCO, CA 94111

CONSULTANT

Mayor ED 17-02 Priority permit

NOT FOR CONSTRUCTION

DATE

REVISION NO.

KEY PLAN - (NTS)

TRUE PLAN NORTH PIER 70

Brookfield Properties

BROOKFIELD PROPERTIES PIER 70 PARCEL A

DESIGN REVIEW PACKAGE PROJECT NUMBER
1830

DATE
JULY 12, 2019

SCALE

DRAWING TITLE
ZONING NARRATIVE

District Parking Garage	S5.4.4	1 space per ea. 25 off street spaces 1 van per 6 spaces (1 min.)		N/A	
Parking Layout	S5.4.5	Comply with Planning Code section 154	144 sq. ft. (8' x 18') min. for standard & 112.5 sq. ft. (7.5' x 15') min. for compact	Complies	See sheet A-100
Acessible Off-Street Parking	S5.4.6	1 Accessible Space per 25 spaces	149 spaces (provided)/ 25 = 6 Spaces required	Complies, 6 spaces provided	See sheet A-100
5.5 Loading & Services		O a ma ma a mai a lu			
Loading Spaces	S5.5.1	Commercial: 0-50,000 GFA Not required 50,001 - 100,000 GFA 1: on-street 100,001 - 250,000 GFA :1 off-street 250,001 - 500,000 GFA: 2 off street 500,001 & above: 3 off street Retail: may be served by loading provided for other predominant uses, other uses must be calculated separately	2 loading spaces	Complies, 2 Spaces provided	See sheet A-101
Loading Space Location in Mid-Block Passages	S5.5.2			N/A	
Street Parking	S5.5.3			N/A	
Loading Space Dimension	S5.5.4	Per table 5.5.2	Min 12' wide x 35' long and 14' vert. clearance	Complies	See sheet A-101
Historic Buildings	S5.5.5	Drovido collection and leading area for		N/A	
Refuse & Recycling	S5.5.6	Provide collection and loading areas for the three separate streams of recycling, composting, and landfill waste. All refuse collection shall be screened from the public ROW.		Complies, provided in loading dock area	See sheet A-101
.6 Loading & Parking Access					
Prohibited curb cut locations Building Loading Access	S5.6.1 S5.6.2	Limited to Louisiana or 21st Street	No applicable prohibited locations	N/A Complies, provided on Louisiana	
Vehicular Entrance	S5.6.3	All vehicular passenger vehicles shall enter or exit in a forward direction		Complies	
District Parking Garage Entrance	S5.6.4			N/A	
Accessory Parking Access	S5.6.5	Max. one entrance/exit allowed per frontage	1 entrance max per frontage	Complies, one entrance on Louisiana	
Accessory Parking Door	S5.6.6	Max. curb cuts width per Table 5.6.1 Secure motorized door located at the property line. To remain open during peak times for non- residential buildings. Electronic access control required at non-peak times.		Complies	See sheet A-101
Access locations	S5.6.7	Access entry points for garages, accessory parking, and off-street loading shall be at least 60' from the corner of an intersection, measured from the property line		Complies	See sheet A-101
Frequency of curb cuts	S5.6.8	Max. one curb cut per parcel is permitted for every 200 lin. ft. of frontage		Complies, Louisiana frontage >200' (259'), 2 curb	
Dimension of Curb Cuts	S5.6.9	Per Table 5.6.1	Curb cuts max. dim: Parking garage 2 way: 22' width or 25' incl. both flared sides Double loading 20' width or 23' incl. both flared sides	cuts provided Complies	Will be coordinated and included in the Horizontal Work permitted separately. See sheet G-000.2 for reference.
Curb Cut Treatment	S5.6.10	Curb cuts shall be designed to prioritize pedestrian movement, with a continuous material treatment extending from the sidewalk or pedestrian path over the vehicular path. Perpendicular curb ramps shall have flared sides. The slope of the flared sides shall be no more than 10 percent to conform to ADA requirements. See Figure 5.6.7. The flat area of the		Complies	Will be coordinated and included in the Horizontal Work permitted separately. See sheet G-000.2 for reference.
Driveway Slope	S5.6.11	driveway between the driveway ramp and the property line shall be at least eight feet in length with a three percent maximum slope minimum of 10 feet in length with a slope equal to half of the difference between		Complies	See detail 1/ A-302
Transition Strips	S5.6.12	the two slopes it transitions. The top transition strip adjacent to the driveway entry transition strip shall be a minimum of eight feet in length with a slope equal to half of the difference between the two slopes it transitions between		Complies	See detail 1/ A-302

HACKER

733 SW Oak, Portland, OR 97205

QA

639 FRONT ST, SAN FRANCISCO, CA 94111

CONSULTANT

Mayor ED 17-02 Priority permit

NOT FOR CONSTRUCTION

REVISION NO.

DATE

KEY PLAN - (NTS)

TRUE PLAN NORTH

PIER 70

Brookfield Properties

BROOKFIELD PROPERTIES PIER 70 PARCEL A

DESIGN REVIEW PACKAGE

PROJECT NUMBER
1830

DATE
JULY 12, 2019

SCALE

DRAWING TITLE
ZONING NARRATIVE

SHEET NUMBER

Driveway sightlines	S5.6.13	sight triangles shall be provided at all egress points such that vision within the triangle is not obstructed, per Figure 5.6.5. These triangles shall be 10 feet wide, parallel to the street, and 10 feet wide perpendicular to the street, with a minimum vertical clearance of 14 feet. Street trees shall not be located within driveway sightlines. Driveways crossing sidewalks shall be no wider than necessary	Complies	Will be coordinated between this project and the the Horizontal Work permitted separately. See sheet G-000.2 for reference.
Driveway Access	S5.6.14	for ingress and egress, and shall be arranged, to the extent practical, so as to minimize the width and frequency of curb cuts, to maximize the number and size of onstreet parking spaces available to the public, and to minimize conflicts with pedestrian and	Complies	Will be coordinated and included in the Horizontal Work permitted separately. See sheet G-000.2 for reference.
Porte Cocheres	S5.6.15	transit movements.	N/A	No porte cocheres are proposed.
Accessory Parking Entrance	G5.6.1	Where possible, parking entrances are encouraged to be located separate from the primary façade of the building or to be integrated into the architectural design to avoid negatively impacting the overall aesthetic quality of the building. Off-street loading entrances	Complies	Parking Entrance is located on Louisiana, separate from primary lobby entrance on Maryland
Shared Egress	G5.6.2	and exits should be combined with garage parking entries wherever reasonable and feasible along the same block frontage.	Complies	Both loading and parking entrance are located on Louisiana.
6 Buildings				
6.3 Buildable Zones				
New Construction Zones	S6.3.1	New construction limited to zones shown in Figure 6.3.1 New construction permitted adjacent to historic buildings with minimum	Complies, Parcel A	The proposed design is 40'-3" clear from its
Buffer Zones and Easements	S6.3.2	separation identified in 6.3.2	Complies	westernmost facade to Building 113.
6.4 Maximum Building height				
Building Height Maximum	S6.4.1	Compliant with Planning Code 90' max	Complies	Building code limits the height of Type III construction to 85'. Therefore the building is well within the D4D height requirement. See Diagram A/G-003.1.
Maximum Stories	S6.4.2	Residential: 8 stories above grade Commercial: 6 stories above grade Measurement includes mezzanine levels	Complies	The proposed building is 6 stories above grade. See Diagram A/G-003.1.
	S6.4.3	Method of height measurement	Complies	There is less than 5' of grade across the site so so building height maximum is measured from the highest grade.
6.7 Streetwall				
Streetwall	S6.7.1	Minimum 1 story for at least 80% of façade length	Complies	See Diagram A/G-003.2. The design features several Ground Floor niches that integrate several features for D4D ground floor requirement compliance in a rhythmic human scaled fashion that highlights the wood structural grid. They are no greater than 3' deep and vary in width between 9' and 10'. They are lined with a simulated blackened steel finish. They are intended to serve as opportunities for planters, benches, and for future tenants to introduce new doors, louvers, and other accouterments in a way that fits naturally into the design.
Streetwall Exceptions: Variations	S6.7.2	May not exceed 20% of the façade length	Complies	See Diagram A/G-003.2
Corners	S6.7.3	Maximum 3' setback at ground floor	Complies	The proposal does not include any corner setbacks more than 3' deep
Southern Boundary Condition	S6.7.4	Min. 15; setback from Potrero Power Plant	NA	Site is not adjacent to the Potrero Power Plant

HACKER

733 SW Oak, Portland, OR 97205

QA

639 FRONT ST, SAN FRANCISCO, CA 94111

CONSULTANT

Mayor ED 17-02 Priority permit

NOT FOR CONSTRUCTION

REVISION NO. DATE

KEY PLAN - (NTS)

TRUE PLAN NORTH

PIER 70

Brookfield Properties

BROOKFIELD PROPERTIES PIER 70 PARCEL A

DESIGN REVIEW PACKAGE

PROJECT NUMBER
1830

DATE
JULY 12, 2019

SCALE

DRAWING TITLE
ZONING NARRATIVE

SHEET NUMBER

Setbacks	G6.7.1	Streetwall setbacks should relate to the pedestrian scale and expand the public realm. Setback landscape areas should be limited to 2' in width.	Applicant requests a minor exception to this guideline.	A number of planters are proposed at the ground floor. They are between 9' and 10' wide depending on the location. They are integrated into the ground floor niches that do not contain doors. Sheet A-101, A-201 and A-202.
Corner	G6.7.2	Corner controls (S6.7.3) are encouraged to apply to building corners at the intersection of public streets and vehicular mid-block passages.	NA	The proposal does not include any corner setbacks more than 3' deep.
6.8 Building Base and Ground Floor				
Defined Base	S6.8.1	Base 1 story min., up to 3 stories max.	Complies	The proposal features a base that is one or two stories high, distingushed from the floors above by increased glazing, and Ground Floor Niches as described in S6.7.1. See Diagram B/G-003.2. Due to sea level rise requirements, the
Ground Floor Transparency	S6.8.2	Ground floor façade min. 60% transparent	Complies with % requirement. Applicant requests minor modification on sill height.	maximum sill height to top of sill mullion will be as high as 3'-3" above the sidewalk on portions of the north, east, and west frontages. See Diagram C/G-003.2.
Ground Floor Height	S6.8.3	15' min. measured floor to floor	Complies	See sheets A-301 and A-302.
Ground Floor Modulation	S6.8.4	Max 30' between vertical articulations on facades fronting22nd, 20th, Maryland & public parks	Complies	Ground floor niches create vertical articulation at a spacing that does not exceed 30' on center.
Ground Floor Horizontal Element	S6.8.5	Required at ground floors along 22nd, 20th, Maryland & public parks for a min. 20% of linear frontage	Complies	Horizontal elements consist of canopies at building entries and trellises within Ground floor Niches. See Diagram A/G-003.3.
Ground Floor Commercial Office Frontage	S6.8.6	The interior area within 4' from the window between 4' - 8' above the side walk must be min. 75% transparent	Complies	No interior walls are proposed, parallel to the windows within 4' of the windows.
Ground floor Entries	S6.8.7	Frequent entries required based on building length	Complies	See Diagram B/G-003.1.
Ground Floor Storefronts	S6.8.8	Temporary artwork allowed during construction	Complies	No temporary ground floor storefronts are proposed.
Ground Floor Storefronts	G6.8.1	Storefront facades are encouraged to open up to the public realm through the use of large, movable openings	Applicant requests exception.	The owner may introduce large movable openings in tenant and retail spaces in locations where they are likely to be used. For example, if retail/service areas are leased by food/beverage tenants, sliding windows will be installed in their spaces. Because tenants are not yet identified, the facade design remains flexible to accommodate this in the future.
Entry Design	G6.8.2	Entry design should incorporate two or more strategies: change in plane related to primiary facade, use of accentuating light/color, projecting element above. change in material or detailing, recessed doors or cased openings	Complies	The main entry on Maryland Street is recessed from the primary facade plane, incorporates a recessed door and a canopy overhead. See Sheets A-101 and 2/A310.2
Commercial Lobbies and Entryways	G6.8.3	Primary entries and lobbies should be visually active through both programming and materials	Complies	Primary entry will be clearly visible from the street, will incorporate active use and will have ample transparency to the exterior. See Detail 2/A310.2. See section S7.7 for signage.
Ground Floor Setbacks Along Irish Hill Passage	G6.3.4	Stoops or building projections facing mid-block passages should be accommodated in setbacks to avoid encroachment	NA	Parcel A has no mid-block passages.
6.9 Façade design				
No Replication of Historic Buildings	S6.9.1	Do not replicate or mimic historic buildings	Complies	The proposal does not mimic historic buildings.
Building Variety	S6.9.2	New buildings must vary from adjacent in at least two ways: massing, materials, glazing pattern,proportion, color, detail, articulation, roofline	Complies	The proposed has different material, massing and roofline from Building 113. It has different integral color and architectural detail than Building 2.

HACKER

733 SW Oak, Portland, OR 97205

QA

639 FRONT ST, SAN FRANCISCO, CA 94111

CONSULTANT

Mayor ED 17-02 Priority permit

NOT FOR CONSTRUCTION

REVISION NO. DATE

KEY PLAN - (NTS)

TRUE PLAN NORTH PIER 70

Brookfield Properties

BROOKFIELD PROPERTIES PIER 70 PARCEL A

DESIGN REVIEW PACKAGE PROJECT NUMBER
1830

DATE
JULY 12, 2019

SCALE

DRAWING TITLE
ZONING NARRATIVE

SHEET NUMBER

Facade Articulation	S6.9.3	Materials shall not replicate scale, pattern, and rhythm of adjacent contributing resources. No false sense of historic development.		Complies	The proposed facade does not replicate Building 113 but it reflects some of the proportions and rhythm of the building and its elements. See Diagrams A and B /G-003.6.
Facade Rhythm	S6.9.4	Facades longer than 200' shall use vertical facade articulation at max. 30' intervals. May be achieved through bays, fenestration, articulation, materials. Must be perceptible from the street.		Complies	All facades feature beveled piers at intervals less than 30' apart. See sheets A-201 and A-202.
Facade Depth	S6.9.5	Architectural details must create shadows and texture across the facade; minimum depth of 6".		Complies	Shadow lines are provided across all facades. See elevation sheets A-201, A-202 and A- 310.1.
Blank Walls	S6.9.6	Blank Walls, prohibited more than 50' long on Maryland and 20th. Always shall incorporate articulation or artistic treatments		Complies	No blank walls proposed on Maryland or 20th. See sheets A-201 and A-202.
Historic Rhythms & Patterns	G6.9.1	New construction should incorporate contemporary interpretations of historic features: horizontal banding, shifted patterns/glazing, articulated rooflines, repetitive patterns, gridded windows, weathered materials		Complies	The proposal incorporates shifted patterns/glazing, and repetitive patters. See sheets A-201 and A-202.
Material & Color Palette	G6.9.2	Materials and color should draw from the site's historic texture and utilize the recommended material palette provided. Materials that patina or weather are encouraged.		Complies	The proposal features a metal cladding with a custom, multi layered simulated blackened steel finish. The finish has similar depth and weathered appearance to historic materials without mimicry. See sheets A-201 and A-202.
6.10 Projections					
Ground Floor Non-Occupiable Projections	S6.10.1	Fins, louvers, etc may extend 1' into ROW, with min. 7'-6" clearance below Ground floor horizontal projections (awnings, etc.) may extend up to 2' from curb edge with min. 10' clearance		Complies	Awnings at doors and trellises in ground floor niches project into the ROW 2'-6" feet. See details D/G-003.3
Upper Level Non-Occupiable Projections	S6.10.2	Horizontal extend 3' over ROW with a 2.5' max. height Vertical elements may extend 2' max. over ROW		Complies	No upper level non-occupiable projections are proposed
Occupiable Projections	S6.10.3	Consistent with Planning Code Section 136 Further limited to max. 60% length of façade and 33% overall building façade Max. 4' projection over property line.		Complies	Aggregated occupiable projections are proposed on all four frontages of the building. See Diagram C/G-003.3.
6.11 Roofs		Max. 4' projection over property line			
Mechanical Screening	S6.11.1	Set back 1.2' for ever foot above the max height limit Screen at least as tall as the equipment	Screens are 10' taller than D4D height limit of 90'. 10x1.2=12' setback minimum.	Complies	Screening is set back more than 12' from exterior building walls facing public ROWs. See sheets A-301 and A-302
Roofline	S6.11.2	No direct replication of the particular geometries of the rooflines of the historic buildings 12, 21, 113-116		Complies	No direct mimicry of historic rooflines are proposed.
Better Roof Requirements	S6.11.3	Per SF Environment code		Complies	The applicant proposes a PV array on the roof of Parcel A in compliance with Better Roof.
Rooftop Structures	S6.11.4	Common access rooftop amenities		Complies	The construction type prohibits occupiable floors above the 6th floor. There are no private rooftop structures or amenities on the highest roof of Parcel A. It is non-occupiable space dedicated to mechanical and photovoltaics. However, 5 terraces are proposed at lower floor levels for use by building occupants. The western 3rd floor terrace will be a common access terrace.
Rooftop Sustainability Strategies	G6.11.1	Encourage to provide useable open space or carbon reducing strategies on roof		Complies	The applicant proposes a PV array on the roof of Parcel A in compliance with Better Roof.
Railings	G6.11.1	Railings shall be set back to minimize visibility		Complies	No railings are proposed around the perimeter of Parcel A.
6.13 Garage and Service Entry Design					31 1 G. 331 7 C.
Parking Garage Treatment	S6.13.1	Parking Garages shall comply with S6.7-6.11 and if over 200' long shall meet S6.18.4		NA	Proposal is not a Parking Garage
Accessory Parking Treatment	S6.13.2	Above ground accessory parking must be wrapped by non-parking uses permitted in Table 2.11		NA	No above ground accessory parking is proposed.
Garage Screens and Facades	G6.13.1	Garage entries should be screened and designed in a manner harmonious with the building's overall composition and materiality		Complies	Garage entry is harmonious with design composition and materiality. See sheet A-201
6.14 Sustainability 6.15 Adjacency to Cultural Resources					

6.15 Adjacency to Cultural Resources

ARCHITECTS

HACKER

733 SW Oak, Portland, OR 97205

QA

639 FRONT ST, SAN FRANCISCO, CA 94111

CONSULTANT

Mayor ED 17-02 Priority permit

NOT FOR CONSTRUCTION

DATE

REVISION NO.

KEY PLAN - (NTS)

TRUE PLAN NORTH

PIER 70

Brookfield Properties

BROOKFIELD PROPERTIES PIER 70 PARCEL A

DESIGN REVIEW PACKAGE

PROJECT NUMBER
1830

DATE
JULY 12, 2019

SCALE

DRAWING TITLE
ZONING NARRATIVE

SHEET NUMBER

Locations & Views	S6.15.1	Preserve sightlines and visual corridors	Complies	View of Building 113 is preserved, looking west on 20th.
Setback and Massing Standards for Building A	S6.15.2	Setback shall be 60 feet (height of Building 113) Min. span at least 50 percent of length of the west façade of Building A minimum of 15 feet from the corner, as measured horizontally, and diagonally at a 45 degree angle from the north and west façades minimum area of 2,000 square feet per floor	Complies	The D4D is not clear about the base point from this measurement. The owner conducted a survey and found that Building 113's gable peak is 60' when measured from NW corner of Parcel A. Therefore, the NW corner of Parcel A will be the base point for this historic building reference. This is a different base point than used in S6.4.1, but it more accurately meets the intent of S6.15.2. See Diagram C/G-003.1.
Height References of Historic Buildings	S6.15.3	West: 60 feet height (Building 113) North: 35 feet base (Building 113) North: 60 feet height (Building 113)	Complies	The D4D is not clear about the base point from this measurement. The owner conducted a survey and found that Building 113's base and gable peak are 35' and 60' respectively when measured from NW corner of Parcel A. Therefore, the NW corner of Parcel A will be the base point for this historic building reference. This is a different base point than used in S6.4.1, but it more accurately meets the intent of S6.15.3. See Diagram D/G-003.1.
Dimensional Quality	S6.15.4	Height reference must have a dimensional quality	Complies	See Diagram D/G-003.1.
Related Treatment to Adjacent Resources	S6.15.5	Incorporate elements that relate to adjacent resources The following materials shall be prohibited on the north and west façades	NA	Not required on Parcel A
Limited Façade Materials	S6.15.6	of parcel A: Bamboo wood; Wood resin panels or high-density engineered wood panels; Smooth, flat glass curtain wall; Coarse-sand finished stucco; Highly reflective glazing and materials.	Complies	No prohibited materials are proposed.
Prohibited Façade Materials	S6.15.7	The following materials are prohibited on all façades adjacent to cultural resources:Vinyl planks and siding; Non-commercial and non-industrial façade materials, such as vinyl, artificial stone, and fiberglass.	Complies	No prohibited materials are proposed.
Public Garages at Irish Hill	G6.15.1	Applies to C1 & C2	NA	Not required on Parcel A
Corner Treatment at Irish Hill Passage	G6.15.2	Applies to HDY3 & HDY 1/2	NA	Not required on Parcel A
Materiality	G6.15.3	Applies to D & E1	NA	Not required on Parcel A
6.16 Bird Safe controls		N/A		
6.17 Mid block passage controls		N/A		
6.18 Long Facades in Key Locations				
Key Façades 200-350' in Length	S6.18.1	Primary: two massing/modulation and one materiality Secondary: One massing/modulation and one materiality Four total credits required	Complies	See Diagrams on G-003.4 and G-003.5
Key Facades 350' or More in Length	S6.18.2	Primary: two massing/modulation and one materiality Secondary: One massing/modulation and one materiality Six total credits required	NA	Not required on Parcel A
Long Facades at Southern Parcels	S6.18.3	Compliance not required if built to lot line Compliance required if 15' setback Required on F/G if no mid-block passage	NA	Not required on Parcel A
Parking Garages 200' or More in Length	S6.18.4	Must meet minimum 4 credits	NA	Proposal is not a Parking Garage
Calculating Credits	S6.18.5	Each strategy equals one credit	Complies	See Diagrams on G-003.4 and G-003.5
Façade Design Submittal	S6.18.6	Requirements checklist required with submittal Base/Upper Level Setbacks	Complies	See Diagrams on G-003.4 and G-003.5
Massing: Qualifying Strategies	S6.18.7	Building Over Mid-Block Passages External Courtyards	Complies	See Diagrams on G-003.4 and G-003.5
Modulation: Qaulifying Strategies	S6.18.8	Multiple systems, volumetric articulation, roofline	Complies	See Diagrams on G-003.4 and G-003.5
Materiality: Qualifying Strategies	S6.18.9	Preferred materials, treatment, facae depth, shading Panelized systems should be scaled to relate to the human scale, and	Complies	See Diagrams on G-003.4 and G-003.5 Panelized systems are at human scale. See
		·		Panelized systems are at human scale. See
Materiality: Scale	G6.13.1	expanses of large panels should be avoided in favor of finer grain materials with articulated seams/reveals If treated glass, composites, or plastics are used, a minimum of 20% of	Complies	sheets A-201 and A-202

HACKER

733 SW Oak, Portland, OR 97205

QA

639 FRONT ST, SAN FRANCISCO, CA 94111

CONSULTANT

Mayor ED 17-02 Priority permit

NOT FOR CONSTRUCTION

DATE

REVISION NO.

KEY PLAN - (NTS)

TRUE PLAN NORTH

PIER 70

Brookfield Properties

BROOKFIELD PROPERTIES PIER 70 PARCEL A

DESIGN REVIEW PACKAGE

PROJECT NUMBER
1830

DATE
JULY 12, 2019

SCALE

DRAWING TITLE
ZONING NARRATIVE

SHEET NUMBER

Creative Design Strategy	S6.18.10	Creative design limited to one credit per façade	Complies	Manipulation of scale, craft and facade articulation. the shifting and alternating bevel locations on the facade piers create visual interest when viewed foreshortened from the sidewalk. See Diagram B/G-003.6.
7 Lighting, Signage & Art 7.4 Building Lighting				Lighting design is in development and will be presented as part of the continued development exercise. Lighting information shown in this document is conceptual.
Energy Consumption	S7.4.1	Smart lighting, automated controls, high efficiency (LED)	Complies	The proposed building is shell and core only. The tenant(s) of the building are unknown at this time and will submit propose lighting under separate permits. Shell and core spaces will integrate smart and energy efficient lighting strategies.
Prohibited Lighting	S7.4.2	Blinking or flashing lighting prohibited	Complies	No blinking or flashing lights are proposed.
Building Entrances and Ground Level	S7.4.3	Lighting at entrances must be provided for security	Complies	See sections on 2/A-310.2, and 3/A-310.3.
Accent Lighting	G7.4.1	Encouraged at focal points, art installations, building facades, and historic assets. Accent lighting should incorporate opportunities for art and technology	Complies	Light fixtures will accent the main entries, terraces, and structure.
Energy Efficiency	G7.4.2	Accent lighting is encouraged to be energy efficient	Complies	Light fixtures will use LED or other energy efficient lamp types.
Glare Reduction	G7.4.3	Lighting should not illuminate or produce glare on adjacent properties	Complies	Lighting will be designed to provide security at entries/exits, and highlight landscaping and building structure. The intent is to conceal light fixtures so only the light itself is visible. This concept will prevent glare or illumination on adjacent properties. See sections on A-310.2 and A310.3.
Building 15 Structural Frame	G7.4.4	Building 15 lighting should be subtle and used to display key features	NA	
7.7 Building signage				
Signage placement	S7.7.2	The maximum height of a sign affixed to a building shall be the eave line of the building to which it is affixed	Applicant requests deferment of this requirement	The proposed building is shell and core only. The tenant(s) of the building are unknown at this time. Therefore tenant preferences for exterior signage are unknown.
Historic signage	S7.7.3	Signage on, near, or for historic buildings shall be minimal	Applicant requests deferment of this requirement	The proposed building is shell and core only. The tenant(s) of the building are unknown at this time. Therefore tenant preferences for exterior signage are unknown.
Signage design	S7.7.4	Signage shall be contemporary yet compatible with the industrial character of the Pier 70 Area.	Applicant requests deferment of this requirement	The proposed building is shell and core only. The tenant(s) of the building are unknown at this time. Therefore tenant preferences for exterior signage are unknown.
Identifying signs	S7.7.5	One per storefront	Applicant requests deferment of this requirement	The proposed building is shell and core only. The tenant(s) of the building are unknown at this time. Therefore tenant preferences for exterior signage are unknown.
Wall signs	S7.7.6	50sf, or 1 sf for each linear foot Cannot cover more than 75% of wall surface 15' max. height	Applicant requests deferment of this requirement	The proposed building is shell and core only. The tenant(s) of the building are unknown at this time. Therefore tenant preferences for exterior signage are unknown.

HACKER

733 SW Oak, Portland, OR 97205

QA

639 FRONT ST, SAN FRANCISCO, CA 94111

CONSULTANT

Mayor ED 17-02 Priority permit

NOT FOR CONSTRUCTION

DATE

REVISION NO.

KEY PLAN - (NTS)

TRUE PLAN NORTH PIER 70

Brookfield Properties

BROOKFIELD PROPERTIES PIER 70 PARCEL A

DESIGN REVIEW PACKAGE

PROJECT NUMBER
1830

DATE
JULY 12, 2019

SCALE


DRAWING TITLE
ZONING NARRATIVE

SHEET NUMBER


Window signs	S7.7.7	Opaque windows signs 30% max. of storefront	Applicant requests deferment of this requirement	The proposed building is shell and core only. The tenant(s) of the building are unknown at this time. Therefore tenant preferences for exterior signage are unknown.
Awning signs	S7.7.8	Not to exceed 20 SF	Applicant requests deferment of this requirement	The proposed building is shell and core only. The tenant(s) of the building are unknown at this time. Therefore tenant preferences for exterior signage are unknown.
Signs attached to buildings	S7.7.9	Not to extend above roofline Non- or indirectly illuminated	Applicant requests deferment of this requirement	The proposed building is shell and core only. The tenant(s) of the building are unknown at this time. Therefore tenant preferences for exterior signage are unknown.
Free standing signs	S7.7.10	Max. 40'	Applicant requests deferment of this requirement	The proposed building is shell and core only. The tenant(s) of the building are unknown at this time. Therefore tenant preferences for exterior signage are unknown.
Projecting signs	S7.7.11	Min. 8' clearance from grade Max. 3' projection from building facade	Applicant requests deferment of this requirement	The proposed building is shell and core only. The tenant(s) of the building are unknown at this time. Therefore tenant preferences for exterior signage are unknown.
Preferred Signage Types	G7.7.1	Preferred sign types include small blade signs, split-flap displays, window signs, projections, wall murals, and wall signs	Applicant requests deferment of this requirement	The proposed building is shell and core only. The tenant(s) of the building are unknown at this time. Therefore tenant preferences for exterior signage are unknown.
Projecting Signage	G7.7.2	Projecting and three-dimensional signs are encouraged to relate to pedestrian scale and enrich public realm	Applicant requests deferment of this requirement	The proposed building is shell and core only. The tenant(s) of the building are unknown at this time. Therefore tenant preferences for exterior signage are unknown.
7.8 Public art				

CLASS A BICYCLE PARKING - LIFT ASSIST DERO DECKER (4 BIKES PER UNIT)



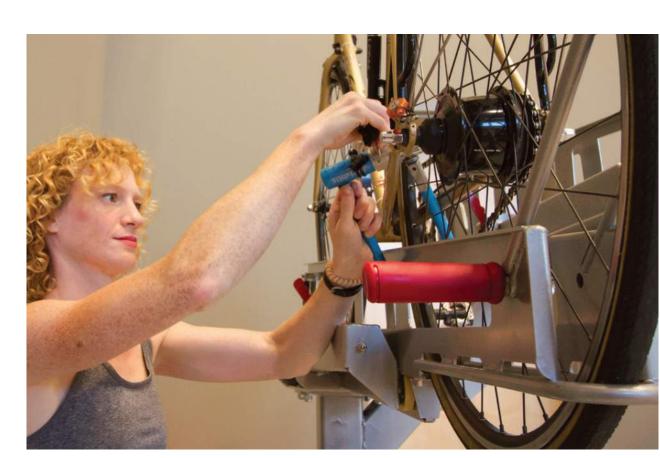



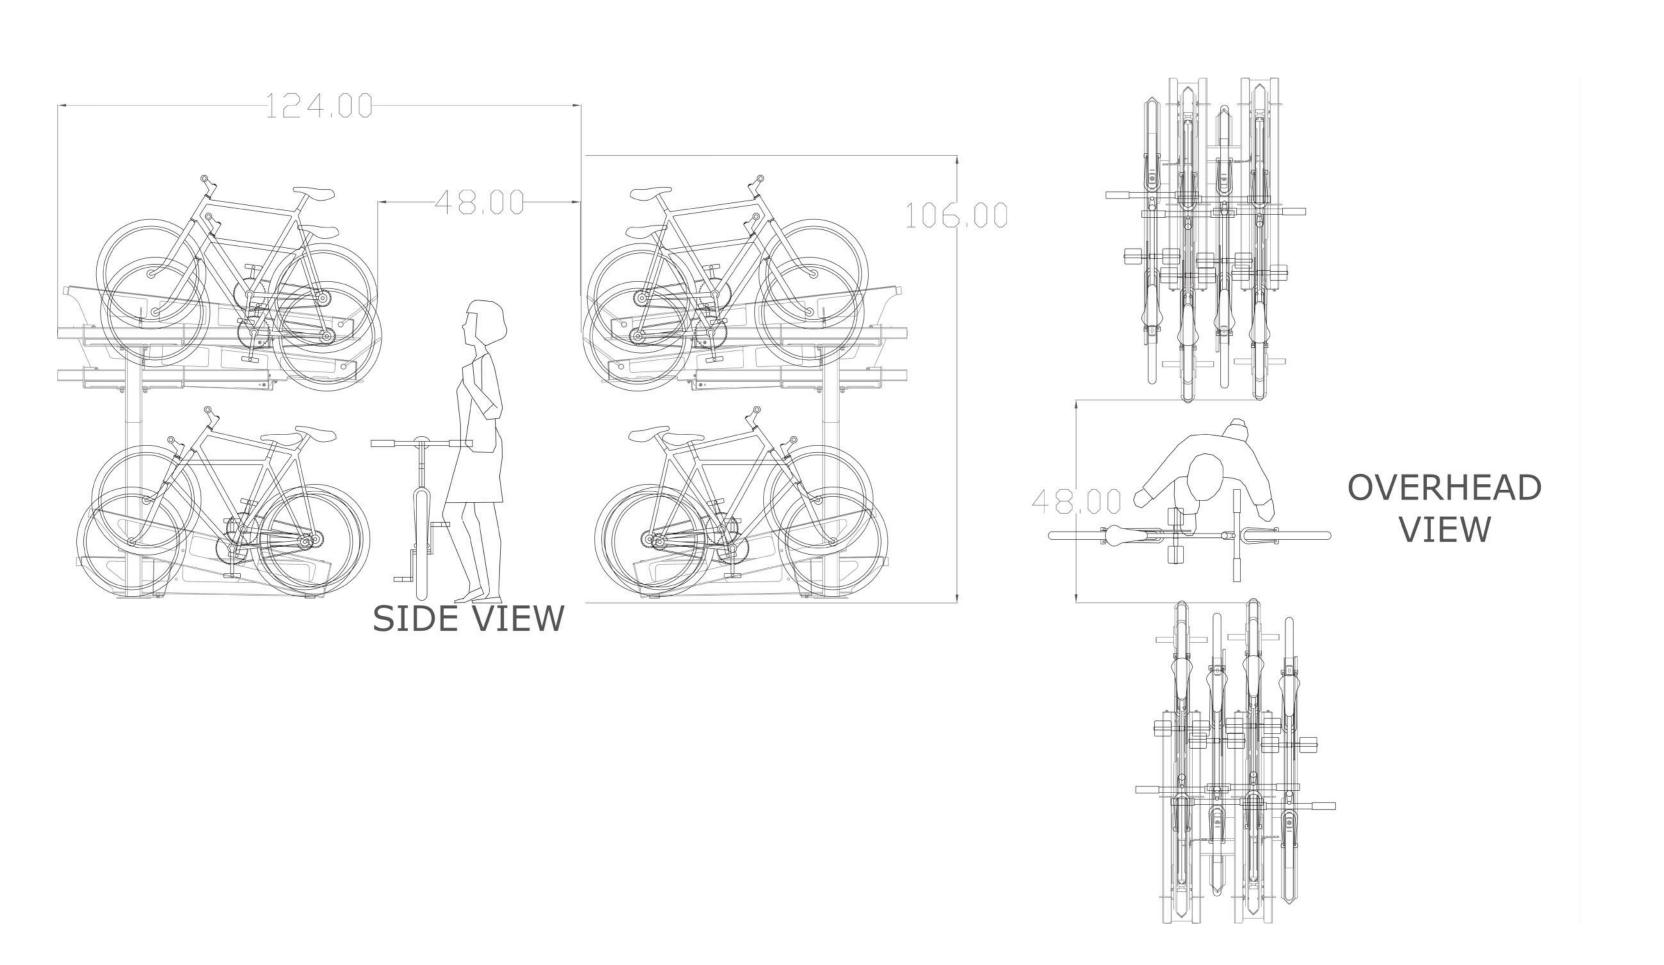

ARCHITECTS

HACKER

733 SW Oak, Portland, OR 97205

QA

639 FRONT ST, SAN FRANCISCO, CA 94111

CONSULTANT

Mayor ED 17-02 Priority permit

STAMP

NOT FOR CONSTRUCTION

REVISION NO.

KEY PLAN - (NTS)

TRUE PLAN NORTH

PIER 70

BrookfieldProperties

BROOKFIELD PROPERTIES PIER 70 PARCEL A

ISSUANCE
DESIGN REVIEW PACKAGE

PROJECT NUMBER
1830
DATE

DATE JULY 12, 2019

DRAWING TITLE
ZONING NARRATIVE

HEET NUIVIBER

ROJECT INFORMATION	SAN FRANCISCO FIRE CODE NOTES	BUILDING HEIGHTS	& AREAS (CHAPTER 5)	FIRE AND SMOKE PROTECTION (CHAPTER 7)	FIRE PROTECTIONS SYSTEMS (CHAPTER 9)	H
TE ADDRESS: 88 MARYLAND ST SAN FRANCISCO, CA 94124		TABLE 504.3	TYPE IIIA B-S S1-S	CONSTRUCTION TYPE IIIB, FULLY SPRINKLERED	AUTOMATIC SPRINKLER SYSTEMS	733 S
ROPERTY ID: APN 4111-009		BASE ALLOWABLE HEIGHT ALLOWABLE STORIES ALLOWABLE AREA (At)	85 85 6 5 85,500 117,000	MAXIMUM AREA OF EXTERIOR WALL OPENINGS	FULLY SPRINKLERED MEETING NFPA 13	Q
OCK NO.: Parcel A		FRONTAGE BONUS (EQUATION		2016 CBC TABLE 705.8		639 FRC
TATE ID: X		If=[F/P25]W/30 .75=[(936/936)25]30/30		FIRE SEPARATION DISTANCE OF 30 FT OR MORE, EXTERIOR WALLS ARE NOT REQUIRED TO BE RATED AND MAY HAVE AN UNLIMITED AMOUNT OF UNPROPENINGS		CONSULTA
AP: X EAR BUILT: NA		AREA BONUSES (EQUATION 5-2 Aa = [At+(NS x If)] x Sa 320,625 = [85,500+(28,50				
EGAL DESCRIPTION		320,023 = [03,3001(20,30	70 X .73/j X 3			
FER TO "TOPOGRAPHIC SURVEY" BY XXX		TOTAL ALLOWABLE HEIGHT	HTS & AREAS AFTER BONUSES 85 85			
OLECT DECEDIDATION	AERIAL FIRE APPARATUS ROAD ACCESS	TOTAL ALLOWABLE STORIES TOTAL ALLOWABLE AREA	6 5 320,625 117,000		FIRE ALARM AND PROTECTION SYSTEMS CBC 907	
ROJECT DESCRIPTION RCEL A INCLUDES THE CONSTRUCTION AND DEVLOPMENT OF A SIX-STORY,		MIXED USE AND OCCUPA	.NCV		REFER TO FA SERIES DRAWINGS FOR FIRE ALARM AND SMOKE ALARM DESIGN	
OUND UP, SPECULATIVE CLASS A OFFICE BUILDING CONSISTING OF ROUGHLY),000 GROSS SQUARE FEET WITH 1 LEVEL OF SUBTERRANEAN PARKING. LIMITEI ILDING AMENITY SPACES WILL BE INLUDED AS A PART OF THE CORE AND SHELL		SEPARATED OCCUPANCY PER 20				
NSTRUCTION.		PROPOSED HEIGHTS & AR	REAS		PORTABLE FIRE EXTINGUISHERS	
OVERNING CODES		PROPOSED HEIGHT PROPOSED STORIES	90 FT (PENDING AB-005 APPROVAL) 6	OTHER FIRE A SMOKE PROTECITON ASSEMBLIES	SECTION CBC 906	
.0 PORT OF SAN FRANCISCO BUILDING CODE .0 PORT OF SAN FRANCISCO ELECTRICAL CODE		PROPOSED AREA	353,459 SQ FT (GSF)	REFERENCE SECTION AS INDICATED	REFER TO G-002 LIFE SAFETY PLANS FOR FIRE EXTINGUISHER LOCATIONS	Ma
10 PORT OF SAN FRANCISCO MECHANICAL CODE 10 PORT OF SAN FRANCISCO PLUMBING CODE		MIVED HEE AND OCCUPATION	.NCV	BUILDING ELEMENT (SECT) FIRE RESISTIVE RATING REQ'D RATING PROVI	DED LOCATIONS EACH LEVEL	
16 CALIFORNIA BUILDING CODE	BUILDING AREAS	CBC 508.1	INCT	SHAFT ENCLOSURE (713.4) 1HR (< 4 STRY) 2 2HR (=/> 4 STRY) 2	MAX TRAVEL DISTANCE 75 FEET	Pri
6 CALIFORNIA ELECTRICAL CODE 6 CALIFORNIA MECHANICAL CODE 6 CALIFORNIA PLUMBING CODE	LEVEL PROPOSED (GSF)			VERT. EXIT ENCLOSURES (CBC 1023.2) 1HR (< 4 STRY) 2	MEANS OF EGRESS (CHAPTER 10)	STAMP
6 CALIFORNIA FLOWIDING CODE 6 CALIFORNIA GREEN BUILDING CODE	BASEMENT 54,012 SF FIRST FLOOR 51,004 SF	FIRE RESISTANCE (C	CHAPTER 6)	2HR (=/> 4 STRY) 2	OCCUPANT LOAD AND EXIT ACCESS	
5 SAN FRANCISCO BUILDING CODE AMENDMENTS	SECOND FLOOR 49,318 SF THIRD FLOOR 48,968 SF	CONSTRUCTION TYPE IIIB, FULL	.Y SPRINKLERED	ATRIUM (CBC 404.6) NA NA	REFER TO G-002 LIFE SAFETY PLANS	
S SAN FRANCISCO ELECTRICAL CODE AMENDMENTS S SAN FRANCISCO MECHANICAL CODE AMENDMENTS	FOURTH FLOOR 49,772 SF FIFTH FLOOR 50,305 SF	FIRE RESISTIVE REQUIREM	ЛFNTS	CORRIDORS (CBC TABLE 1020.1) 0 0 ELEVATOR MACHINE RMS (CBC 3005.2) 2 2		
SAN FRANCISCO PLUMBING CODE AMENDMENTS SAN FRANCISCO ENERGY CODE AMENDMENTS SAN FRANCISCO GREEN BUILDING CODE AMENDMENTS	SIXTH FLOOR 48,640 SF TOTAL 352,019 SF	2016 CBC TABLE 601	<u></u>	(CBC 3005,1 EXCEPTION 1) 1 1	AREA OF REFUGE NOT PROVIDED	REVISION N
SAN FRANCISCO GREEN BOILDING CODE AMENDMENTS SAN FRANCISCO EXISTING BUILDING CODE AMENDMENTS	332,323 3.	BUILDING ELEMENT	FIRE RESISTIVE FIRE RESISTIVE RATING REQUIRED RATING PROVIDED	INCIDENTAL USES (CBC 509) REF. CBC TABLE 509	NOT REQUIRED PER 1007.3, EXCEPTION 2 IN BUILDINGS EQUIPPED THROUGHOUT WITH AN AUTOMATIC FIRE EXTINGUISHER SYSTEM INSTALLED	
	USE AND OCCUPANCY (CHAPTER 3)	PRIMARY STRUCTURAL FRAM	E 1 1	CONTROL AREAS (CBC 414.2.4) NA NA	IN ACCORDANCE WITH SECTION 903.3.1.1 OR 903.3.1.2.	
ILDING CODE EQUIVALENCIES (SF AB-005)	A-3 ASSEMBLY	BEARING WALLS EXTERIOR	2 2	SEPARATED OCCUPANCIES GROUP B, M, S-1 GROUP A-2 OR A-3 AND B, M, OR S-1 1 1	MEANS OF EGRESS SIZING	
ER TO SHEET G-003 FOR APPROVED LOCAL EQUIVALENCIES (CITY OF	CONFERENCE ROOMS AND TERRACES >750 SQ. FT.	INTERIOR	1 1	FIRE AREAS (CBC 707.3.10) 2 NA	SECTION 1005.3, EXCEPTION 2	
FRANCISCO FORM AB-005.)	B OFFICE SPACE, CONFERENCE ROOMS AND TERRACES <750 SQ. FT. M RETAIL	EXTERIOR NONBEARING WALL	LS 0 0	ELEVATOR LOBBY (CBC 3006) 0 0	STAIRWAYS 0.2 INCH PER OCCUPANT (0.15 INCH W/ VOICE ALARM)	
ILDING PERMITS	S1 STORAGE - MODERATE HAZARD STORAGE - UTILITY AND STORAGE ROOMS	INTERIOR NONBEARING WALL	LS 0 0		OTHER COMPONENTS 0.15 INCH PER OCCUPANT	
PERMIT ADDENDUM SCHEDULE:	S-2 STORAGE - PARKING GARAGE	AND PARTITIONS FLOOR CONSTRUCTION	1 1		TWO-WAY COMMUNICATION	
ENDUM #1: FOUNDATIONS ENDUM #2: SUPERSTRUCTURE		ROOF CONSTRUCTION	1 1		TWO-WAY COMMUNICATION IS PROVIDED AT EACH ACCESIBLE FLOOR THAT IS ONE OR MORE STORIES ABOVE OR BELOW THE LEVEL OF EXIT DISCHARGE.	
ENDUM #3: ARCH / MEP ENDUM #4: FACADE	SPECIAL REQUIREMENTS (CHAPTER 4)	EVTEDIOD WALL FIDE DECI	ICTENICE			
DENDUM #5: SPRINKLERS DENDUM #6: FIRE ALARM			NCE FOR CONSTRUCTION TYPE IIIB			KEY PLAN -
HER TBD (PILES, SOIL IMPROVEMENTS)		TABLE 602	DISTANCE TO PROPERTY FIRE RESISTIVE			
			LINE OR CL OF ROW RATING PROVIDED			
		NORTH	60 0			
FERRED SUBMITTALS		SOUTH	60 0 49 0			
		WEST	υ U			TRU NOR
						PIER
		PLUMBING FIXTUR	ES (2016 CPC)	1	l	Bro
				PLUMBING FIXTURE QUANTITY CALCULATION	DNS ¹	Pro
			GROUP 'A2' GROUP 'B' (Office)	GROUP'A'		1 10
			LOAD FACTOR = 30 OCC. LOAD FACTOR = 200	TOTAL REQU	IRED FIXTURES TOTAL PROVIDED FIXTURES DRINKING FOUNTAINS SERVICE SINK REQ'D/ UTURE TI) REQ'D/ PROVIDED PROVIDED	BROOKF PIER 70 PA
		AREA (SF)	OCCUPANTS AREA OCCUPANTS M F (SF) M F	M F M F M²	F M F A (FUT.) B A (FUT) B	ISSUANCE DESIGN
		1	9520 24 24	1 WC/1 UR 2 WC 1 WC/1 UR 1 LAV 1 LAV		PROJECT N 1830
				9 1 9 19 19 19 19 19 19 19 19 19 19 19 1	36-51-100-1995	DATE
		2	48,365 121 121	242 3 WC / 2 UR 8 WC 3 WC / 2 UR 2LAVS 3 LAVS 2LAVS	8 WC 5 WC 8 WC 1 1 1 1 1	JULY 12,
		3 1,832		242 2LAVS 3 LAVS 2LAVS 294 1 WC / 1 UR 2 WC 3 WC / 2 UR 8 WC 4WC / 3 UR 1 LAV 1 LAV 2 LAVS 3 LAVS 3 LAVS	3 LAVS 3 LAVS 4 LAVS 1 1 1 1 1 1 1 1 1 1 1 1 1 1 1 1 1 1 1	SCALE 12" = 1
		3 1,832 4		242 2LAVS 3 LAVS 2LAVS 294 1 WC/1 UR 2 WC 3 WC/2 UR 8 WC 4WC/3 UR	3 LAVS 3 LAVS 4 LAVS 1 1 1 1 1 1 1 1 1 1 1 1 1 1 1 1 1 1 1	SCALE

PER 2016 CPC TABLE 422.1 & TABLE A

HACKER

733 SW Oak, Portland, OR 97205

639 FRONT ST, SAN FRANCISCO, CA 94111

Mayor ED 17-02 Priority permit

NOT FOR CONSTRUCTION

REVISION NO.

Brookfield

DRAWING TITLE **ZONING INFORMATION** AND BUILDING **TABULATIONS**

SHEET NUMBER

3 LAVS


3 WC / 2 UR


8 WC 3 LAVS


The total number of required water closets for females shall be not less than the total number of required water closets and urinals for males.

For each urinal added in excess of the minimum required, one water closet shall be permitted to be deducted. The number of water closets shall not be reduced to less than two-thirds of the minimum requirement.

G-002

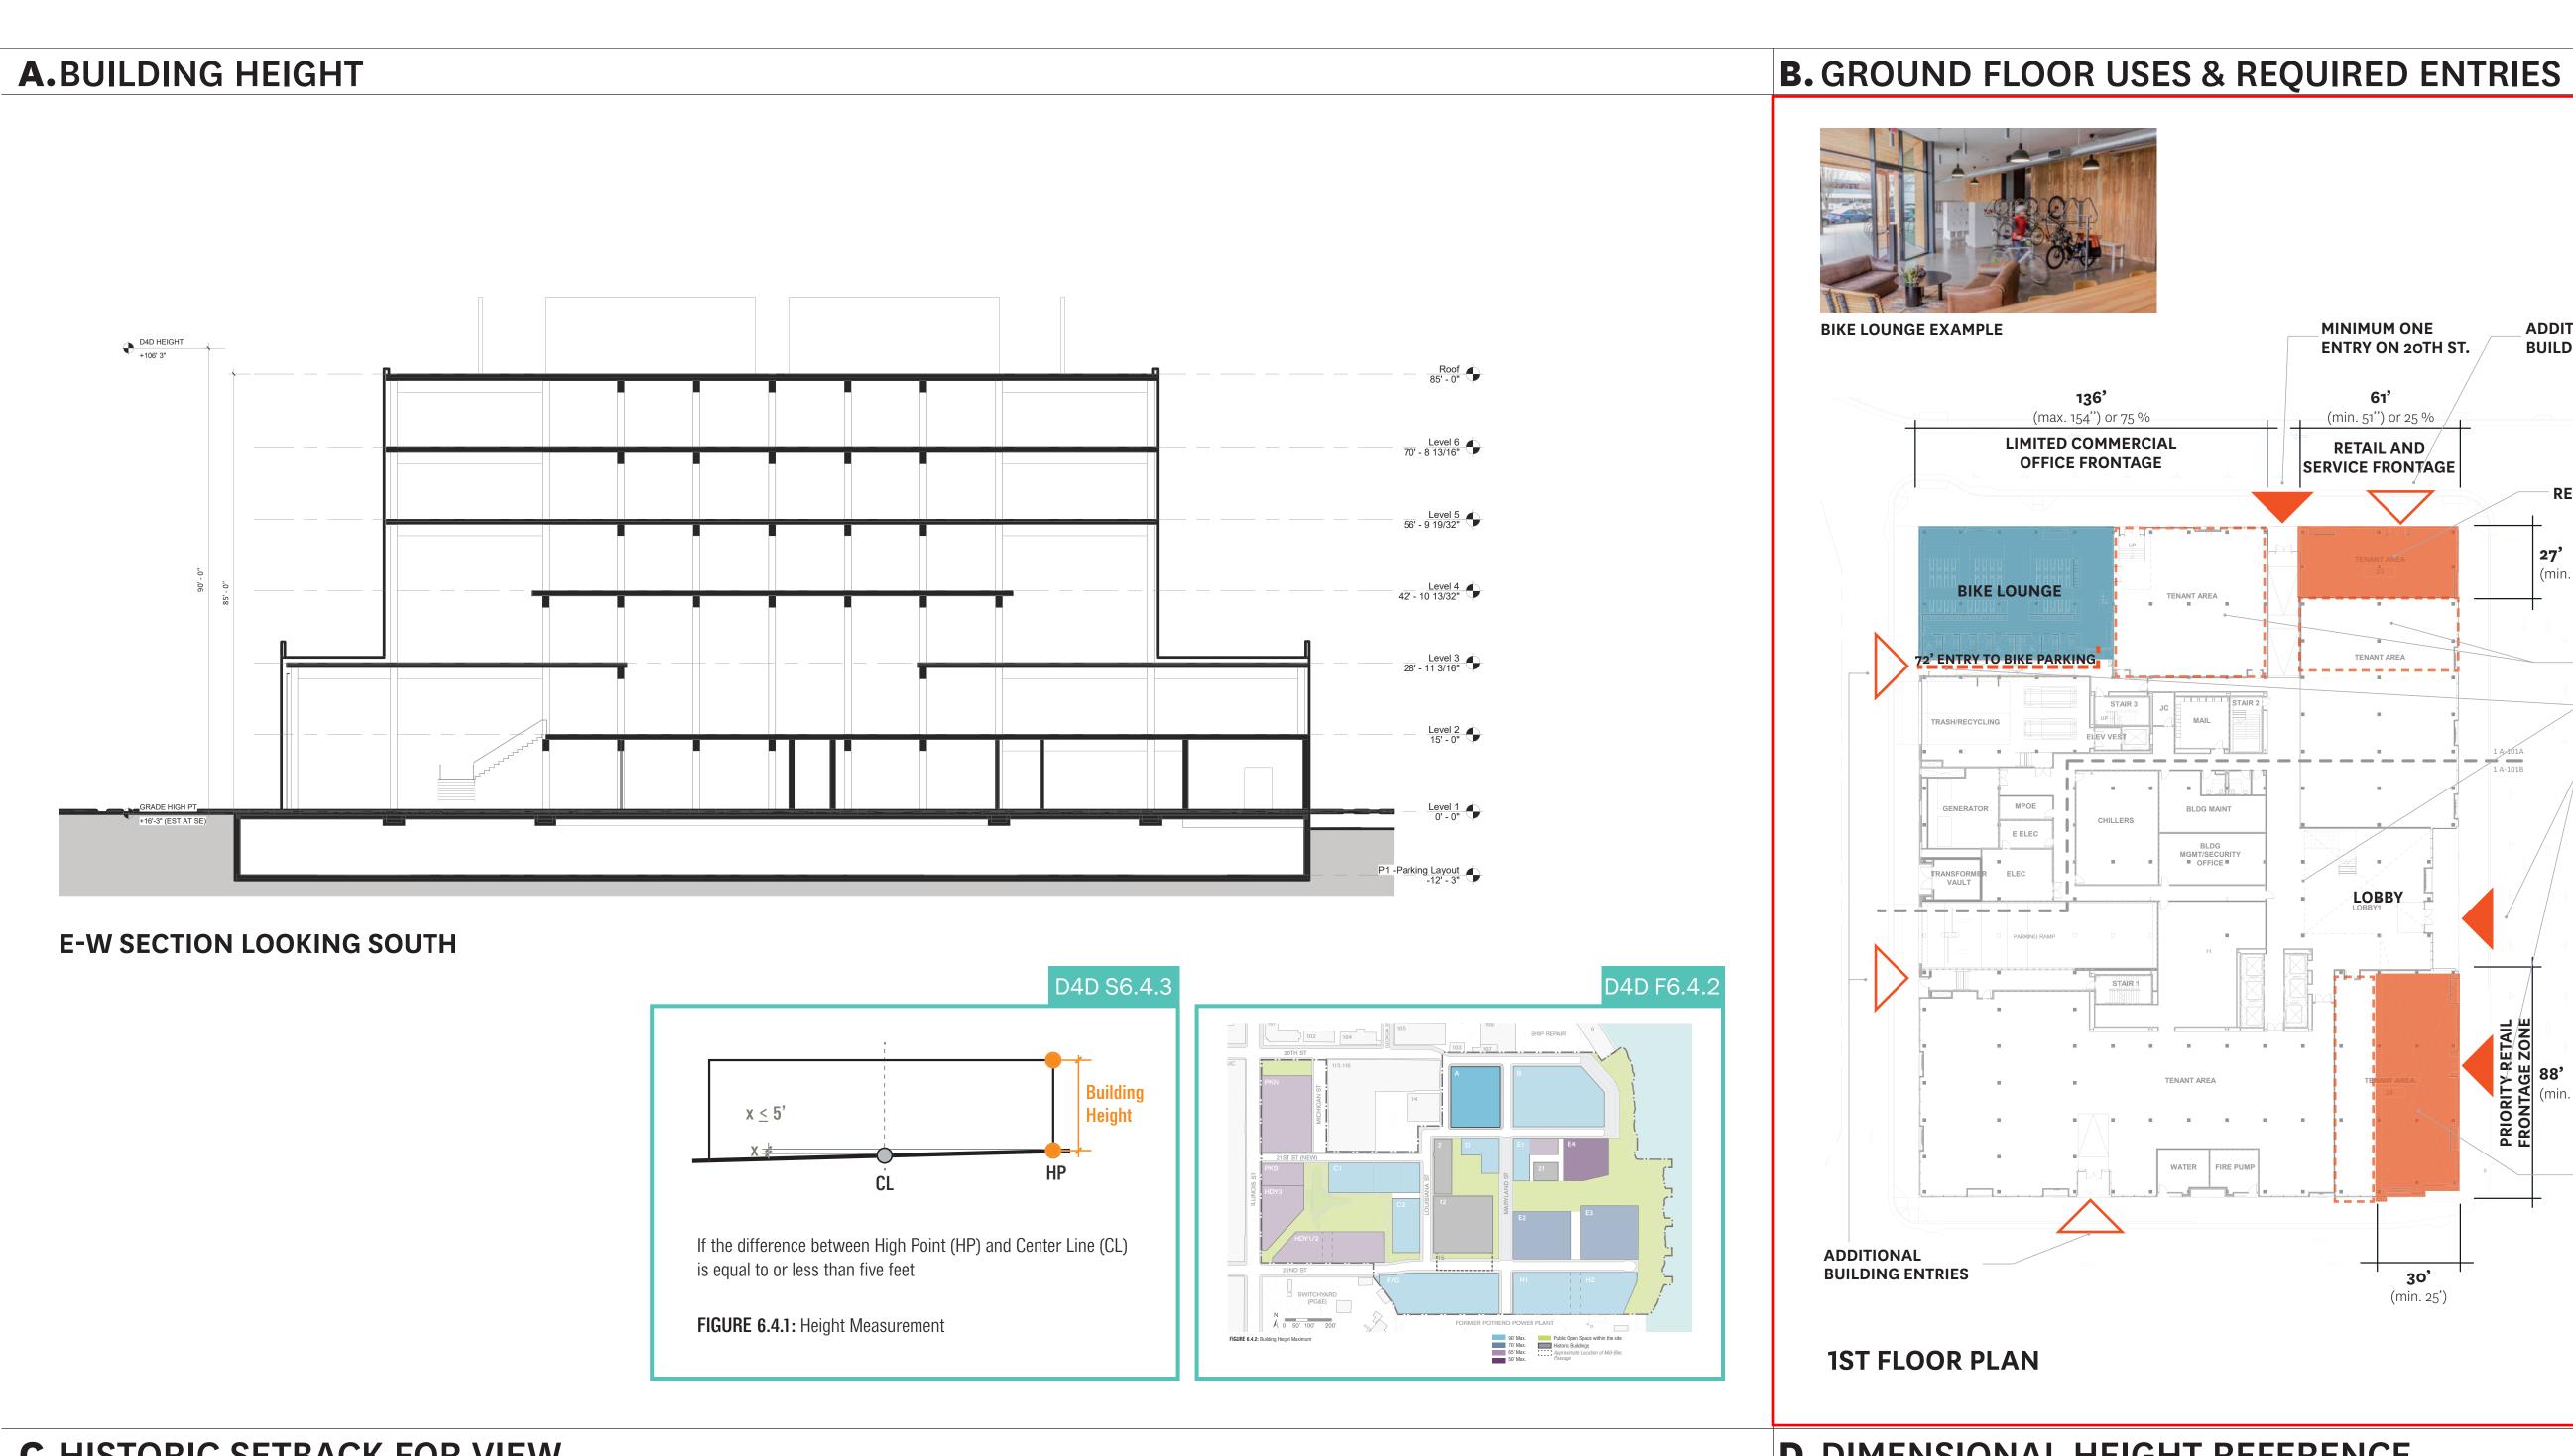


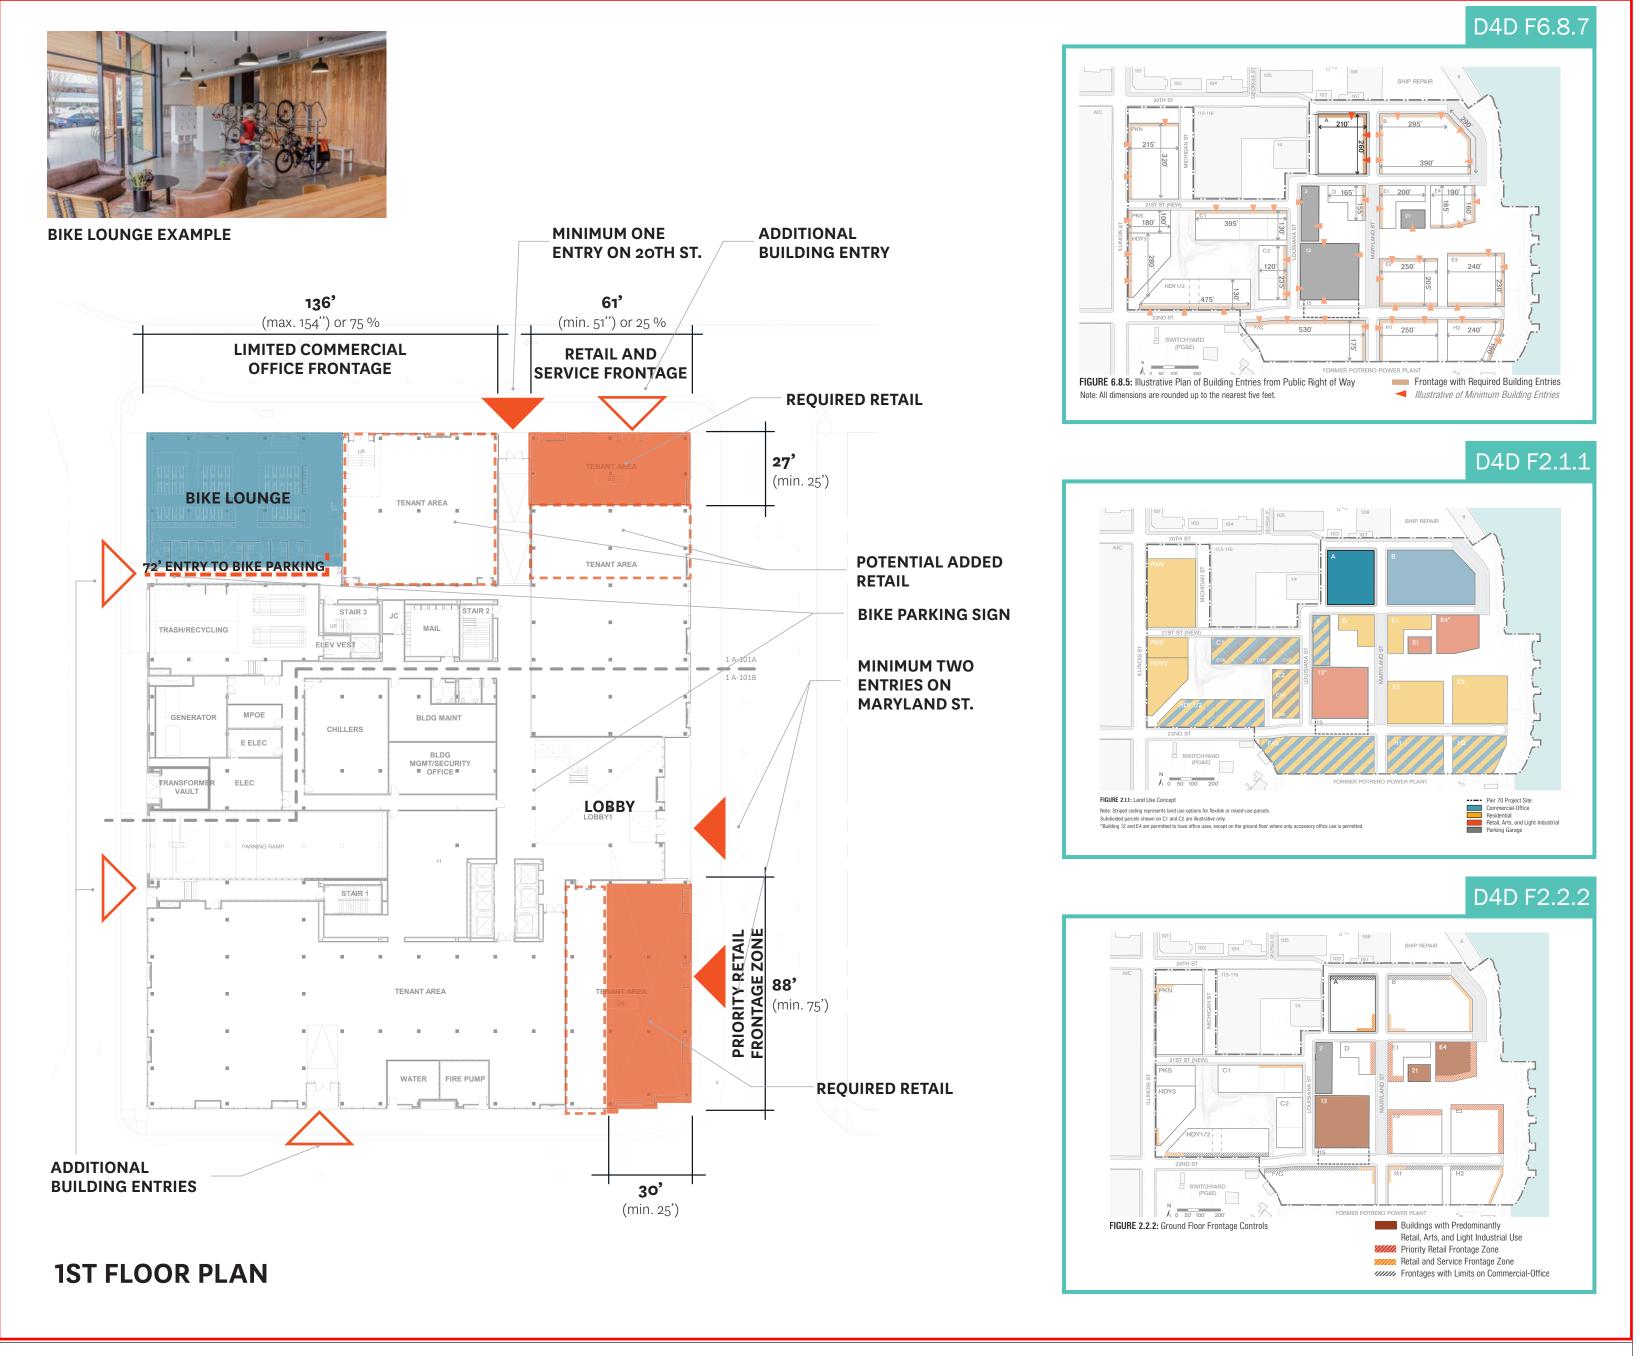


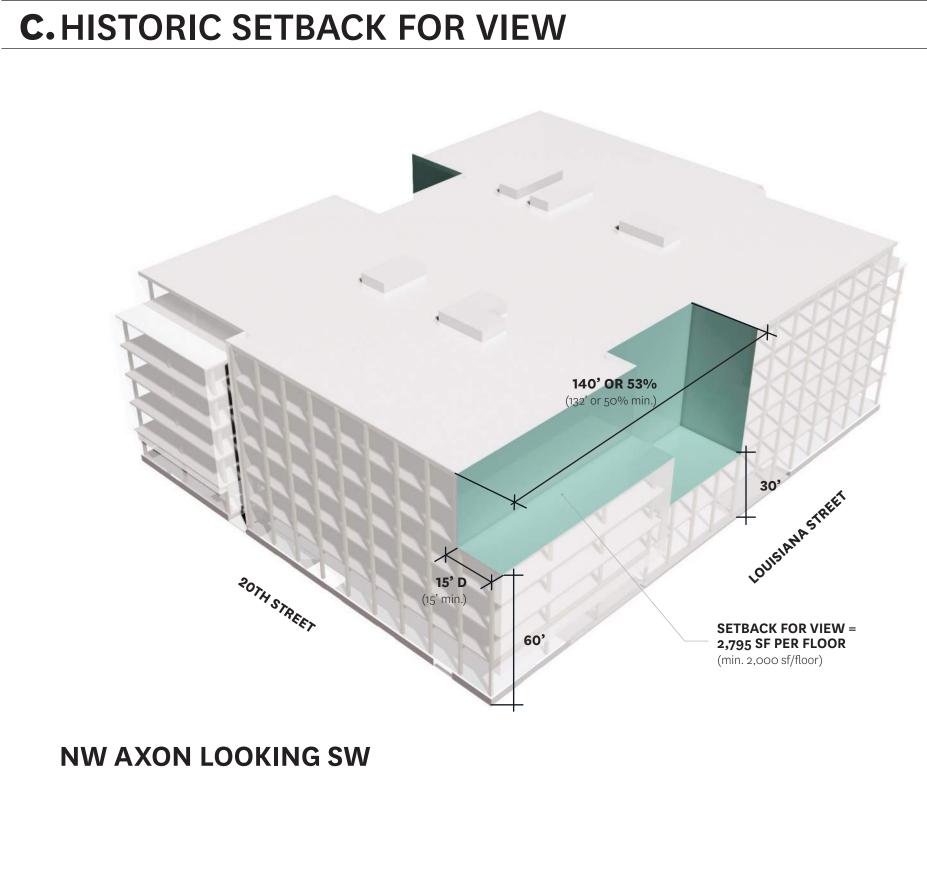

20TH ST. PERSPECTIVE LOOKING EAST



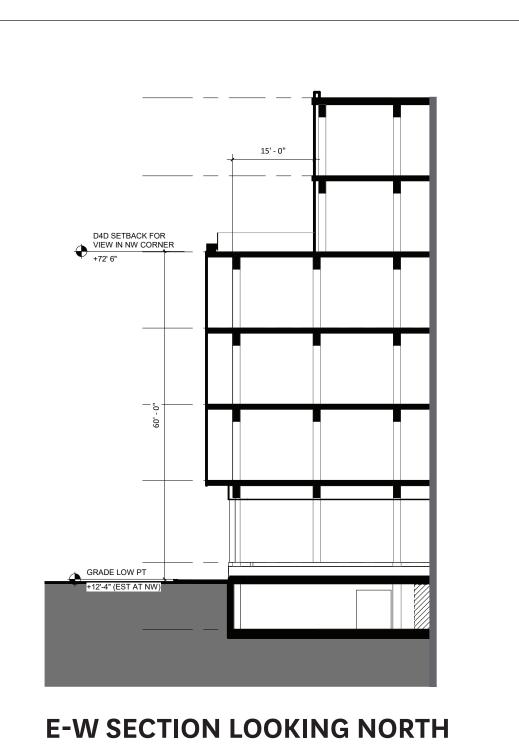

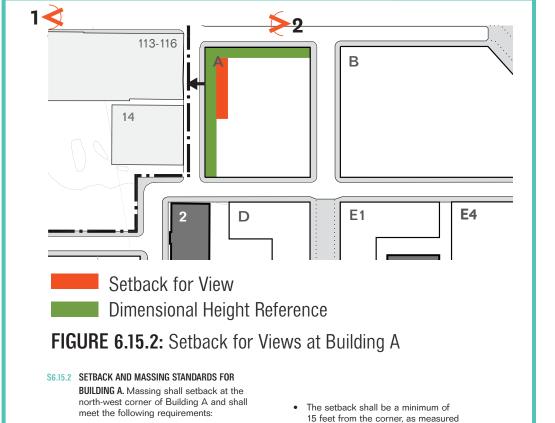

Setback shall be at the height of Building

least 50 percent of length of the west

At minimum, the setback shall span at

113 (60 feet);

façade of Building A;

horizontally, and diagonally at a

The setback shall maintain a minimum

area of 2,000 square feet per floor.

45-degree angle from the north and west

D4D F6.15.2



 \star B \star C1 \to B \star C2

NORTH ELEVATION


PARCEL FAÇADE BUILDING NUMBER / HEIGHT

West Building 113 / 60' height

Building 113 / 35' base

Building 113 / 60' height

(Building 113 Historic Reference)

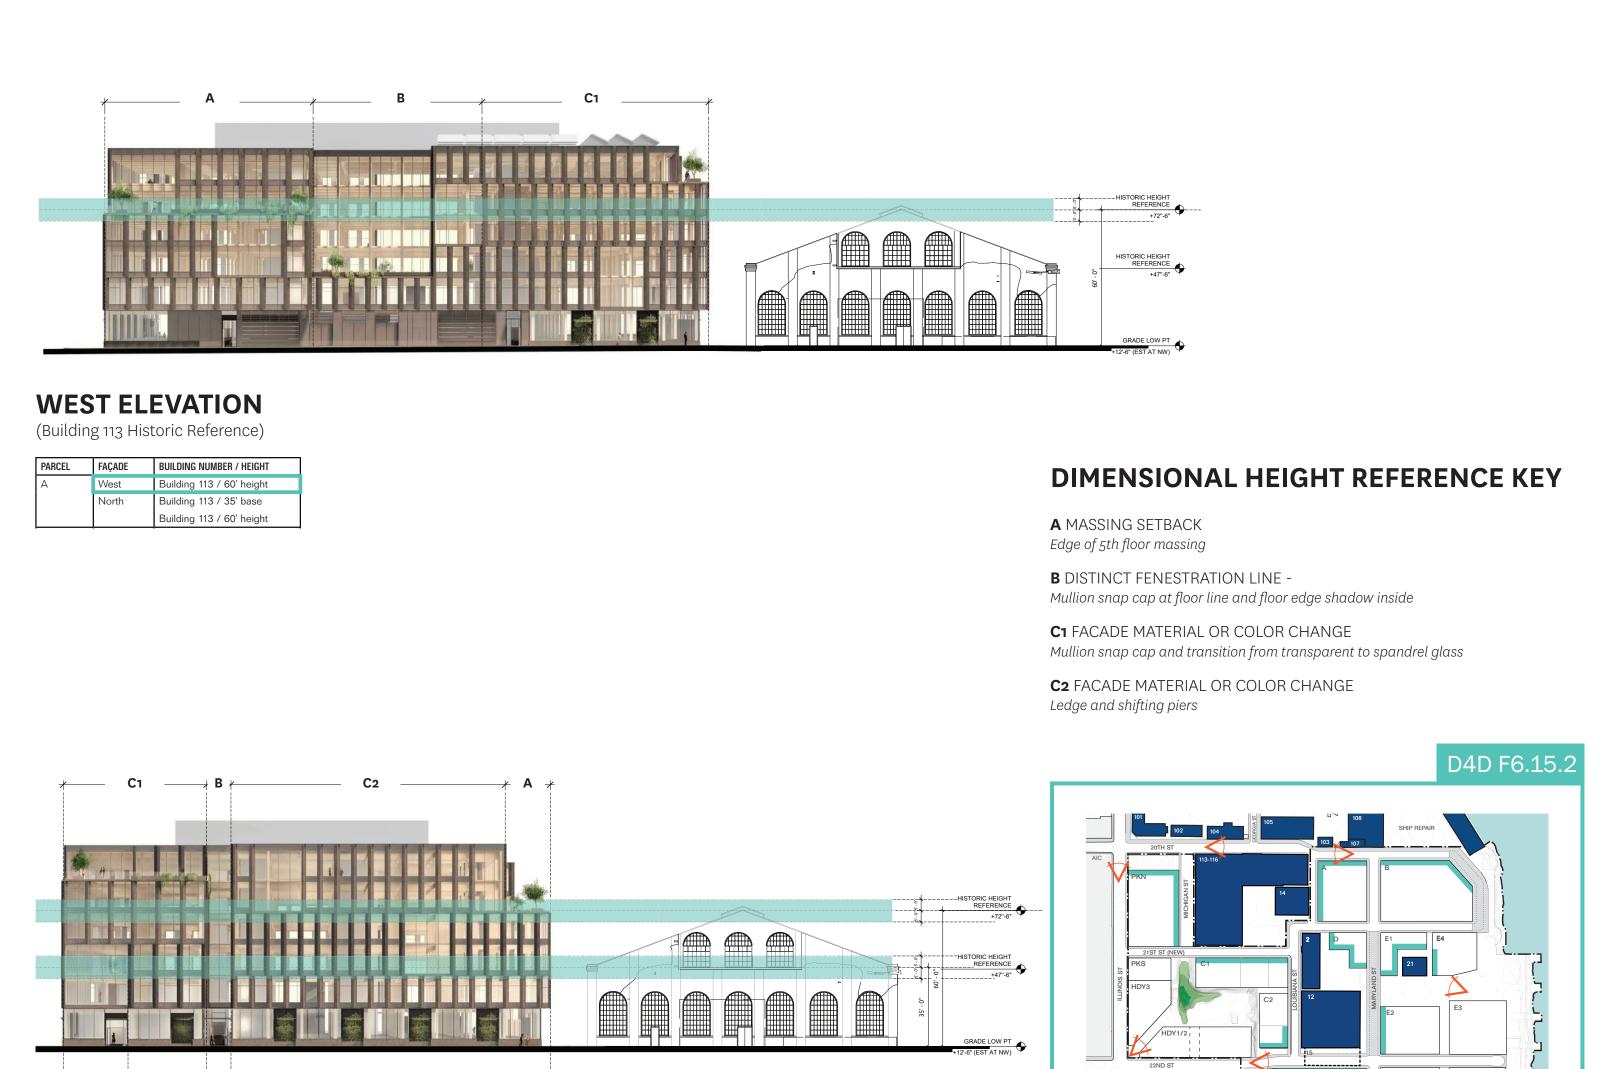

N 0 50' 100' 200'

Building Façades Subject to Cultural Resources Standards and Guidelines

Historic Buildings

Irish Hill Remnant

Key Views

[] Building 15 Structural Frame

ARCHITECTS

HACKER

733 SW Oak, Portland, OR 97205


QA

639 FRONT ST, SAN FRANCISCO, CA 94111

CONSULTANT

Mayor ED 17-02 Priority permit



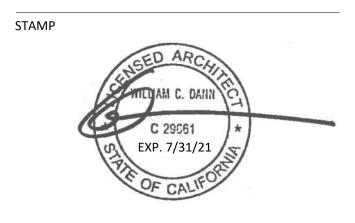

DATE

REVISION NO.

KEY PLAN - (NTS)

TRUE PLAN NORTH

PIER 70

BrookfieldProperties


BROOKFIELD PROPERTIES PIER 70 PARCEL A


ISSUANCE
SITE PERMIT
PROJECT NUMBER
1830
DATE

SEPTEMBER 04, 2019
SCALE

D4D COMPLIANCE

SHEET NUMBER

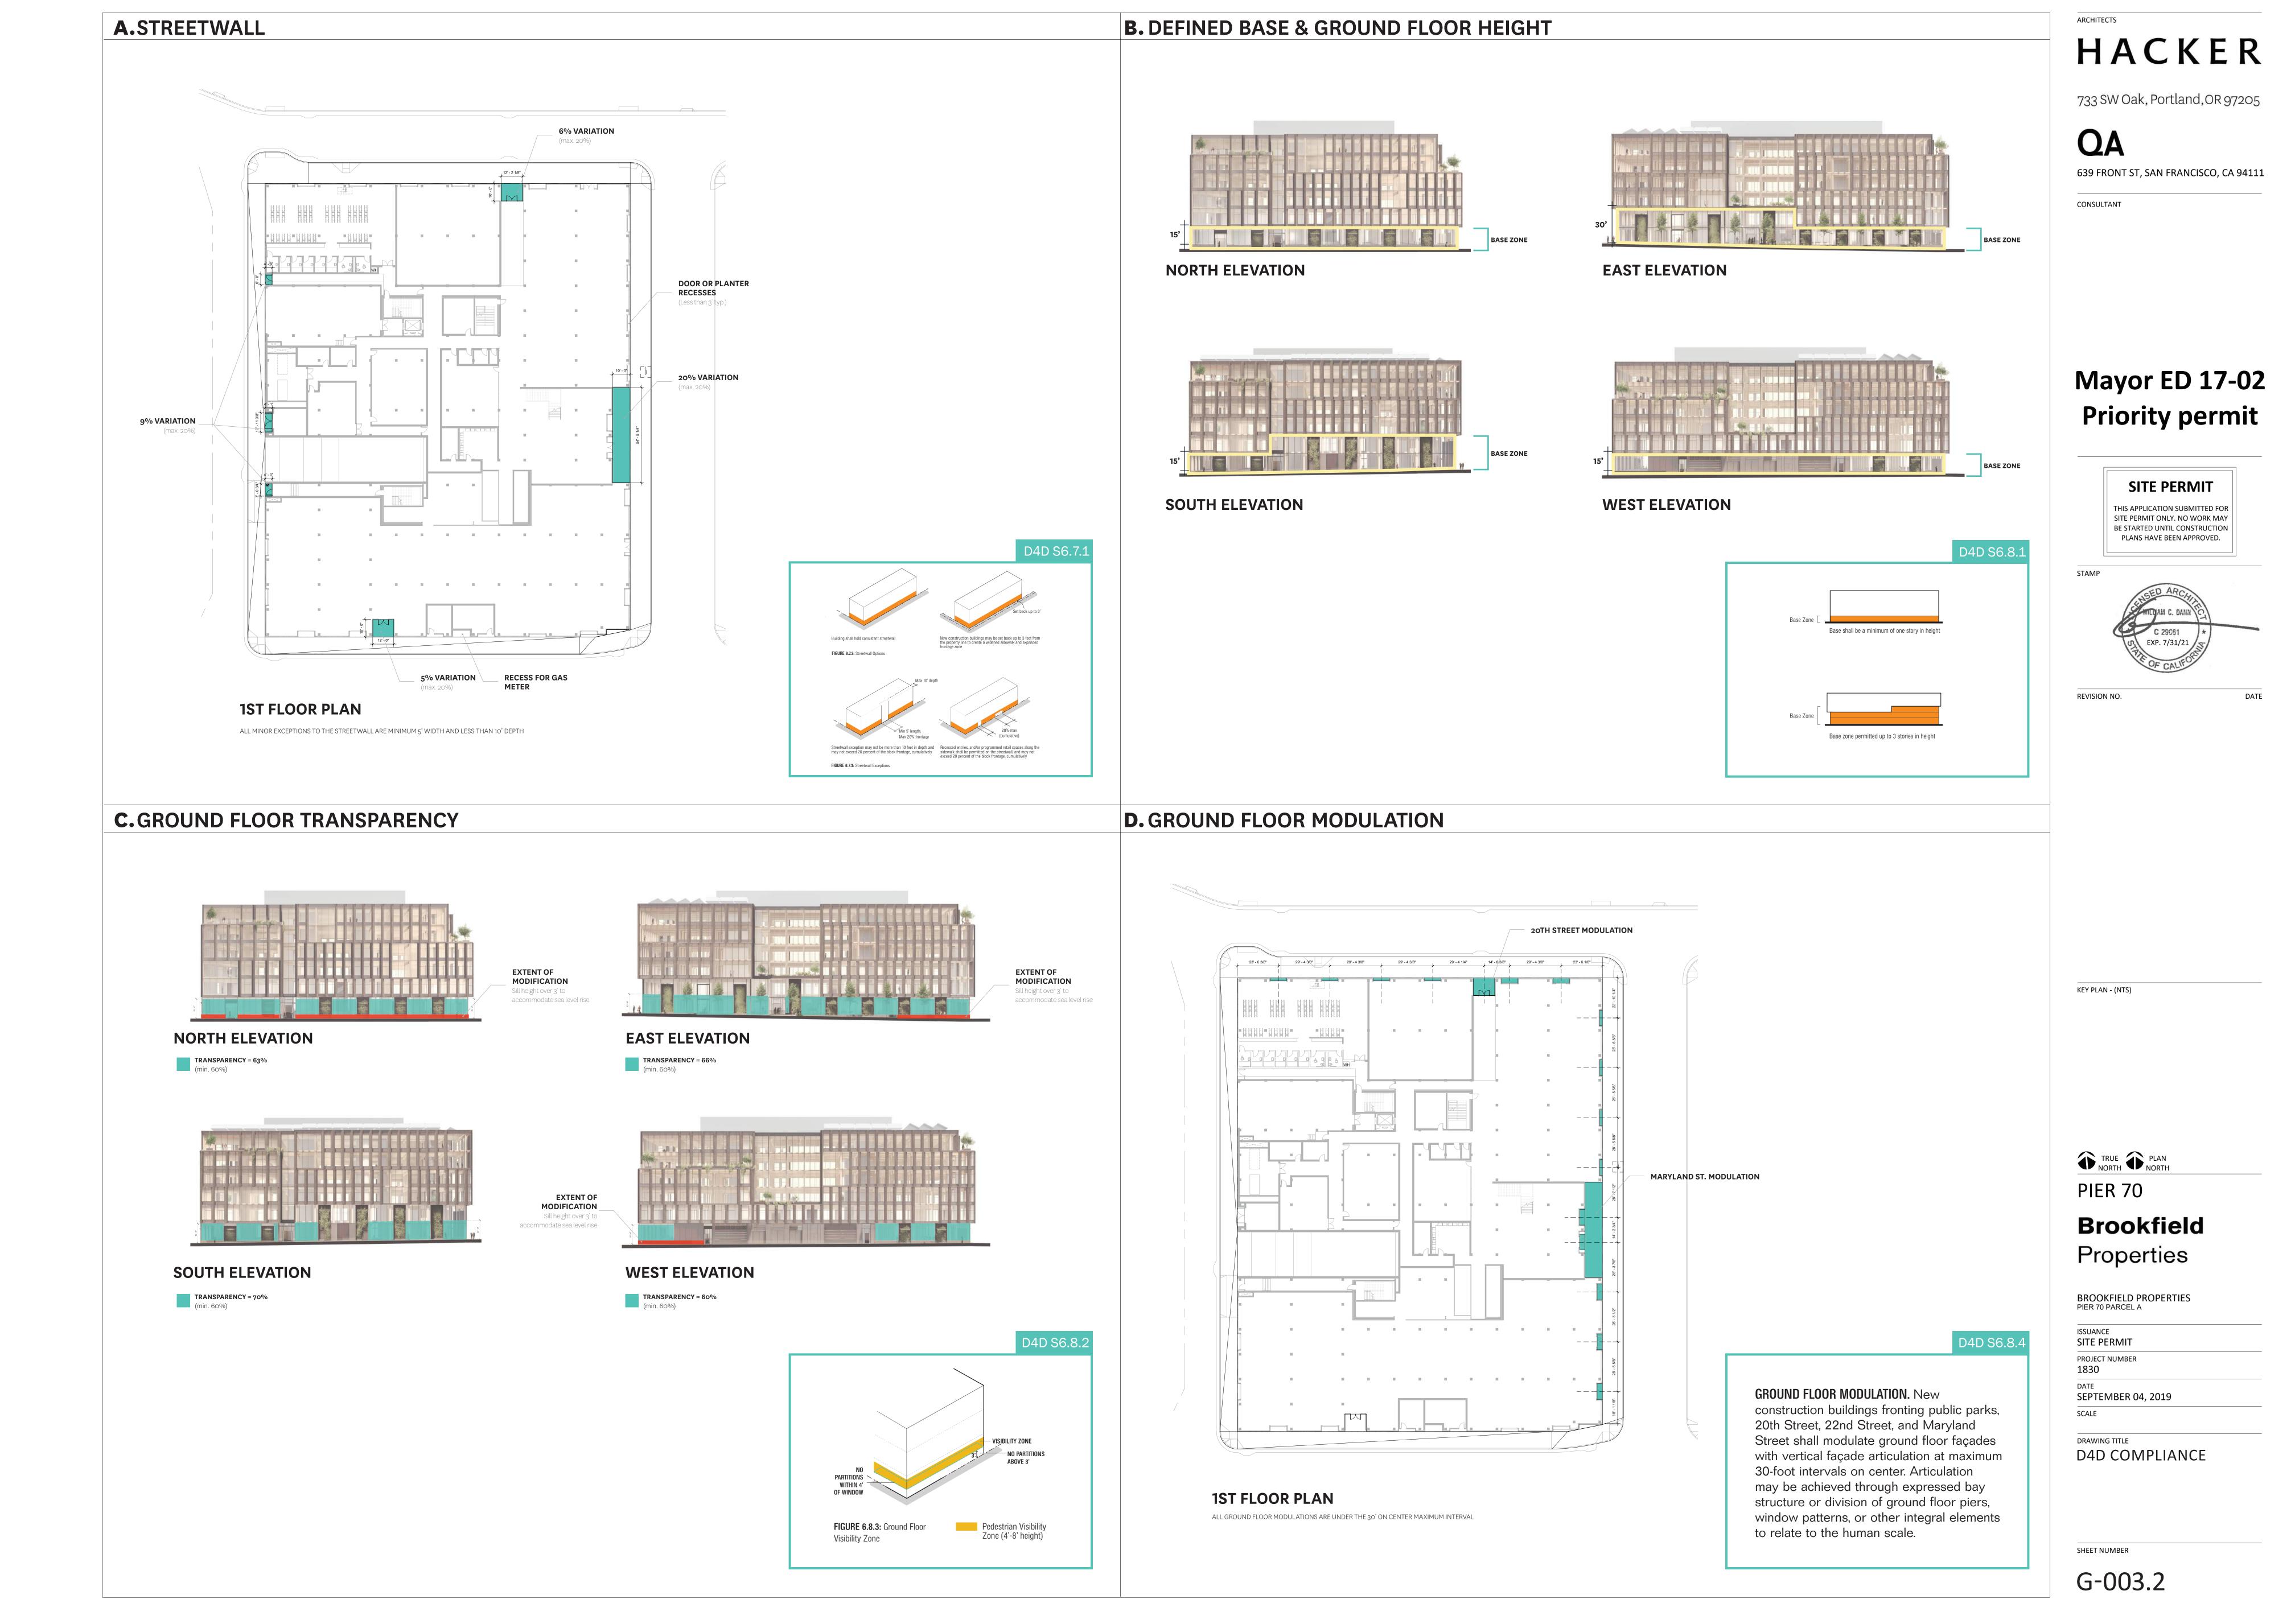


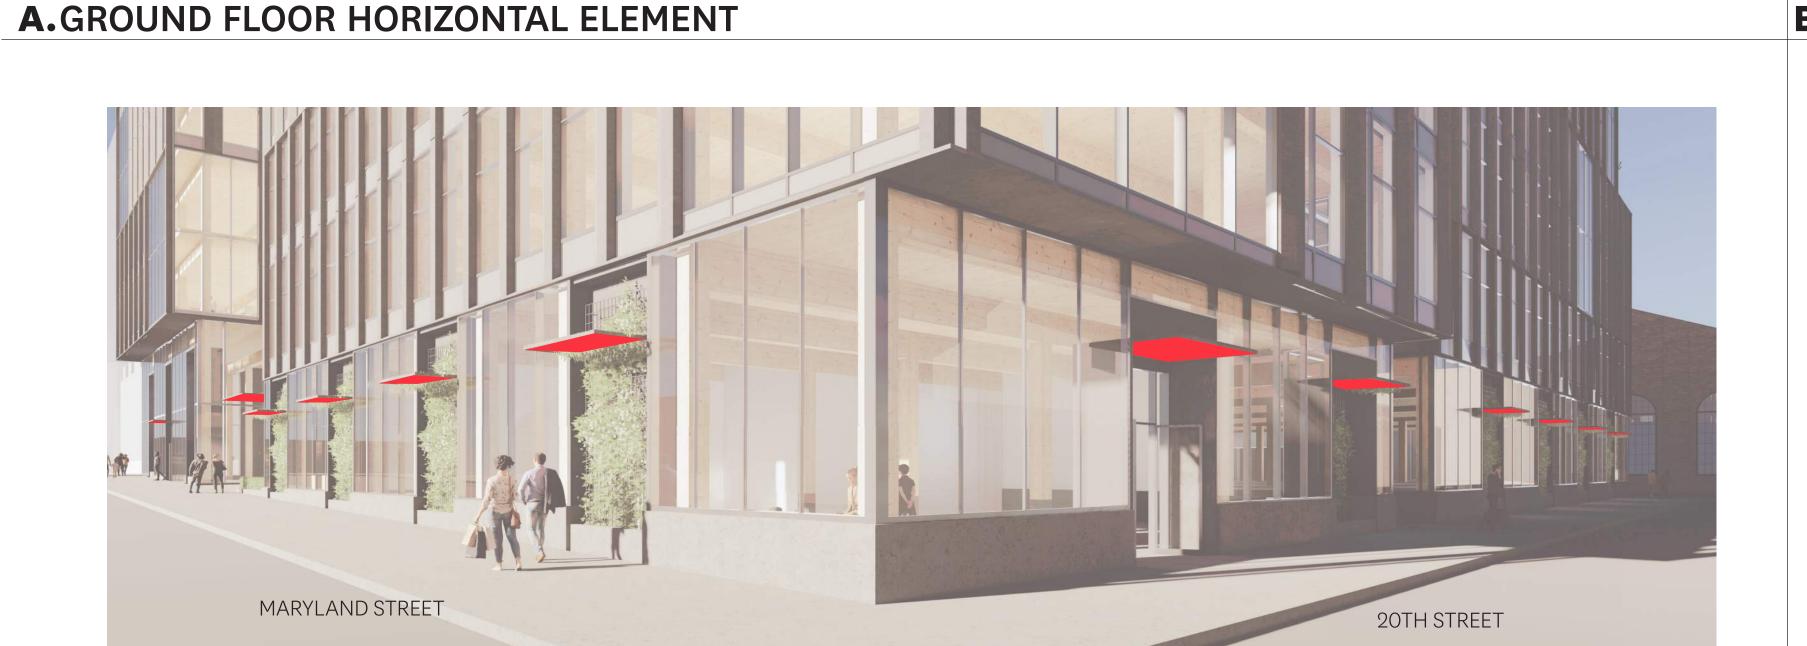

..0 - .697

MARYLAND STREET (EAST ELEVATION)

TOTAL HORIZONTAL ELEMENT = 36% (MIN. REQUIRED: 20%) FACADE LENGTH = 259FT HORIZONTAL ELEMENT = 92FT

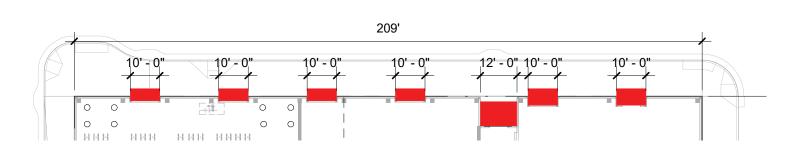

20TH STREET (NORTH ELEVATION)

TOTAL HORIZONTAL ELEMENT = 34% (MIN. REQUIRED: 20%) FACADE LENGTH = 209FT HORIZONTAL ELEMENT = 72FT

D4D S6.8.5


GROUND FLOOR HORIZONTAL ELEMENT. Ground floor frontages for new construction buildings fronting public parks, 20th Street, 22nd Street, and Maryland Street shall have horizontal elements that articulate the pedestrian scale. Frontages along mid-block passages are exempt. Such elements shall cumulatively span a minimum of 20 percent of linear frontage along a building. Horizontal elements may include canopies, marquees, prominent eaves, projections, massing differentiation, and/or architectural features. To create features that relate to a pedestrian scale, no single horizontal projection, including canopies and marquees, shall be continuous for more than 30 feet, in order to create a pedestrian scale and rhythm.

B. GROUND FLOOR COMMERCIAL OFFICE FRONTAGE



NORTH ELEVATION

- VISIBILITY ZONE BETWEEN 4-8 FEET
- NO PARTIONS ABOVE 3 FEET

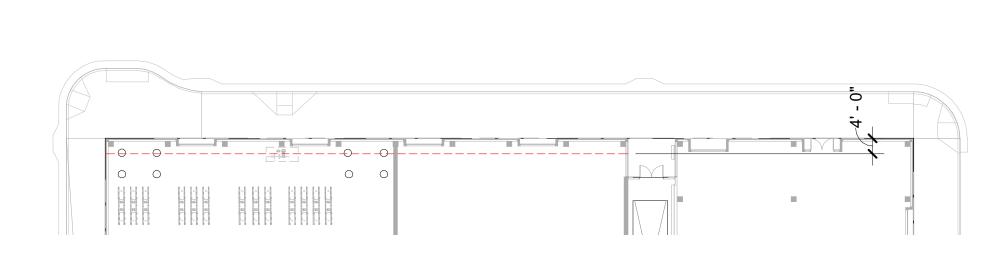

20TH STREET - PLAN VIEW

• NO PARTIONS WITHIN 4 FEET OF WINDOW

D4D S6.8.6 GROUND FLOOR COMMERCIAL-OFFICE FRONTAGE. The interior area within four feet from the

surface of the window glass between a

level shall be at least 75 percent open to

perpendicular view. See Figure 6.8.3 for an

partitions above three feet shall be located

within four feet of the window. See also

G2.2.1 for guidelines on uses.


illustration of the required visibility zone. No

height of four and eight feet above sidewalk

SITE PERMIT THIS APPLICATION SUBMITTED FOR BE STARTED UNTIL CONSTRUCTION

Mayor ED 17-02

Priority permit

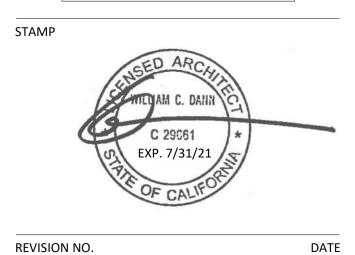

REVISION NO.

ARCHITECTS

QA

CONSULTANT


HACKER

733 SW Oak, Portland, OR 97205


639 FRONT ST, SAN FRANCISCO, CA 94111

C.PROJECTIONS


OCCUPIABLE PROJECTIONS

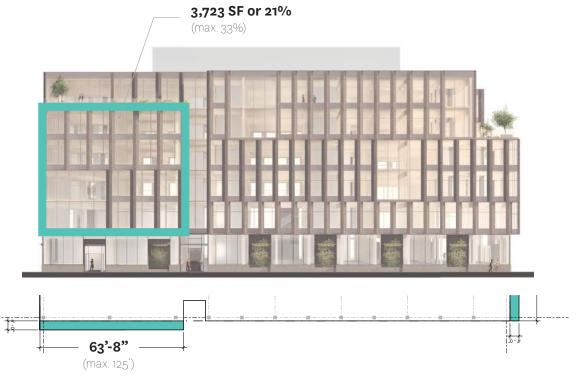


NORTH ELEVATION BASELINE AREA = 17,670 SF

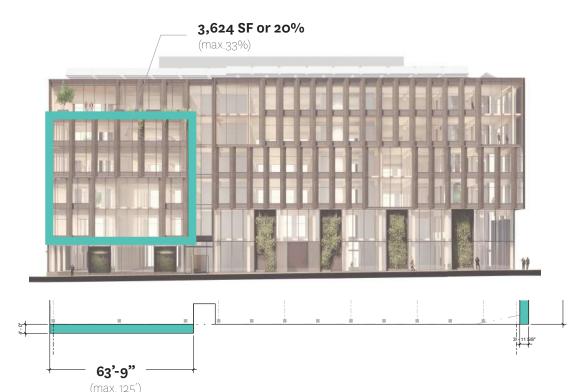


SOUTH ELEVATION BASELINE AREA = 18,192 SF

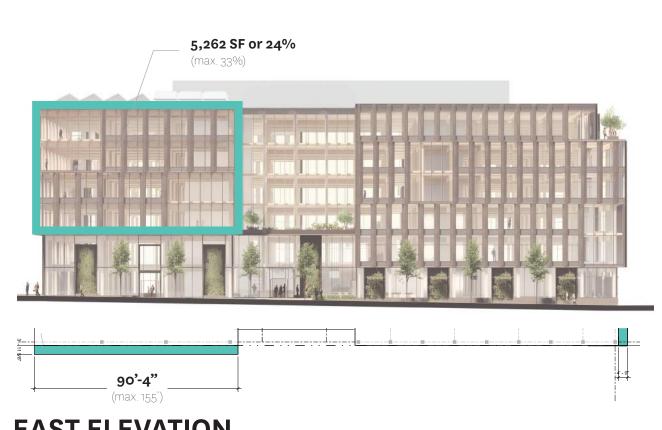

EAST ELEVATION

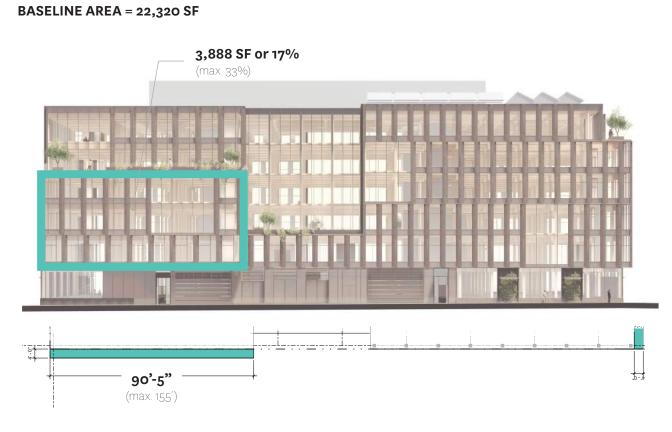


WEST ELEVATION BASELINE AREA = 22,391 SF

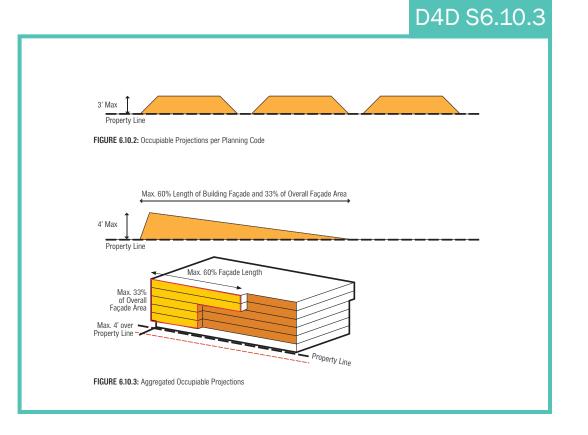


D. PROJECTIONS

NON-OCCUPIABLE PROJECTIONS

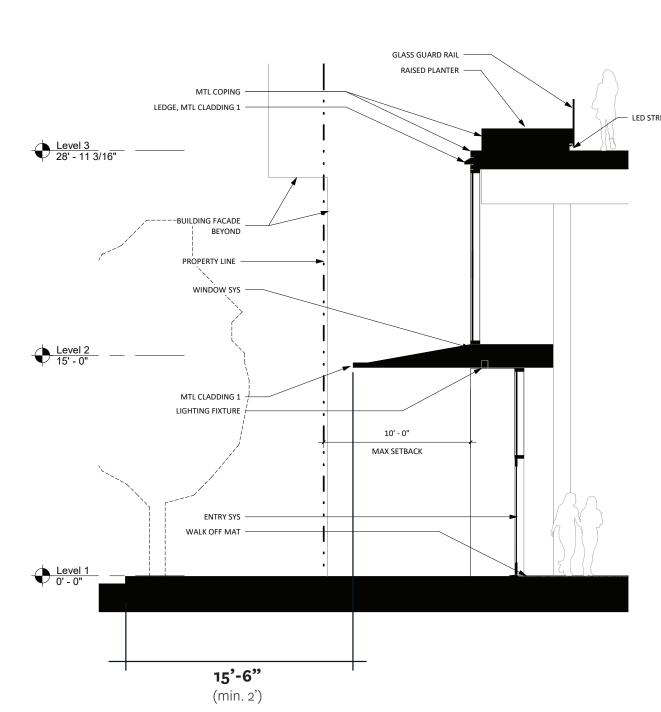

ENTRY LOBBY - ENLARGED SECTION

• MAY EXTEND UP TO 2' FROM CURB EDGE PROVIDED MIN. CLEARANCE OF 10' PROVIDED FROM SIDEWALK GRADE

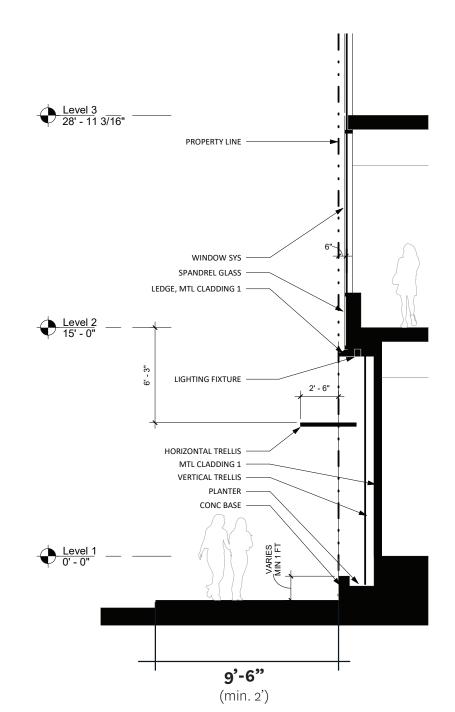

PARTITIONS `

WITHIN 4' OF WINDOW

PLANTER NICHE- ENLARGED SECTION

• MAY EXTEND UP TO 2' FROM CURB EDGE PROVIDED MIN. CLEARANCE OF 10' PROVIDED FROM SIDEWALK GRADE

D4D S6.10.:

GROUND FLOOR NON-OCCUPIABLE PROJECTIONS. Non-occupiable building elements such as cornices, architectural fins, louvers,

rain screens, brise soleil, and decorative elements may extend up to one foot into the ROW, provided a minimum clearance of 7.5 feet is provided from sidewalk grade, and compliance with San Francisco Building Code is met.

Additionally, non-occupiable ground floor horizontal elements such as marquees, awnings, and canopies may extend up to two feet from the curb edge, provided a minimum clearance of ten feet is provided from sidewalk grade.

TRUE PLAN NORTH

PIER 70

KEY PLAN - (NTS)

Brookfield Properties


BROOKFIELD PROPERTIES PIER 70 PARCEL A

ISSUANCE SITE PERMIT PROJECT NUMBER 1830

SEPTEMBER 04, 2019

DRAWING TITLE D4D COMPLIANCE

SHEET NUMBER

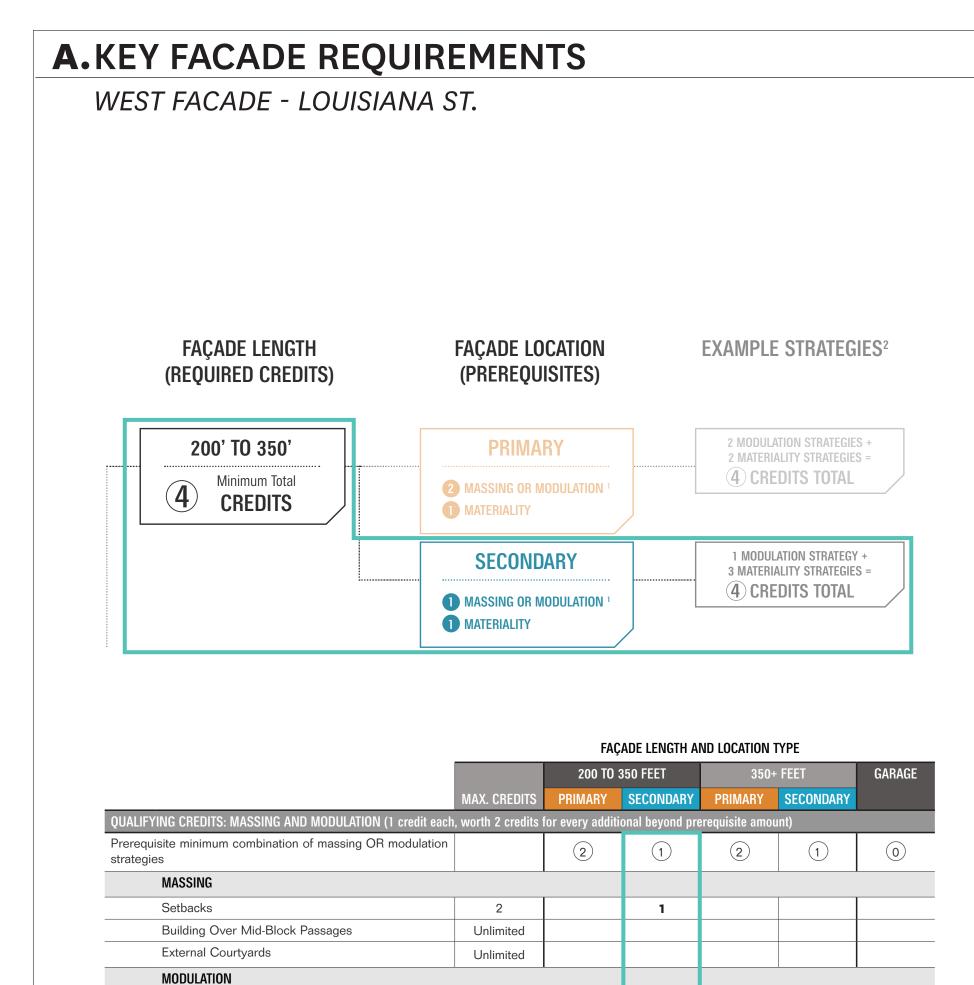

Unlimited

Unlimited

Unlimited

Unlimited

YING CREDITS: MATERIALITY (1 credit each, 1 credit for every additional beyond prerequisite amount

Multiple Façade Systems

Roofline Modulation

Prerequisite minimum materiality strategy

QUALIFYING CREDITS: CREATIVE DESIGN (1 CREDIT)

Does this project meet minimum requirements? (Y/N)


TOTAL CREDITS REQUIRED

TOTAL CREDITS PROVIDED


Preferred Materials


Façade Depth


Shading

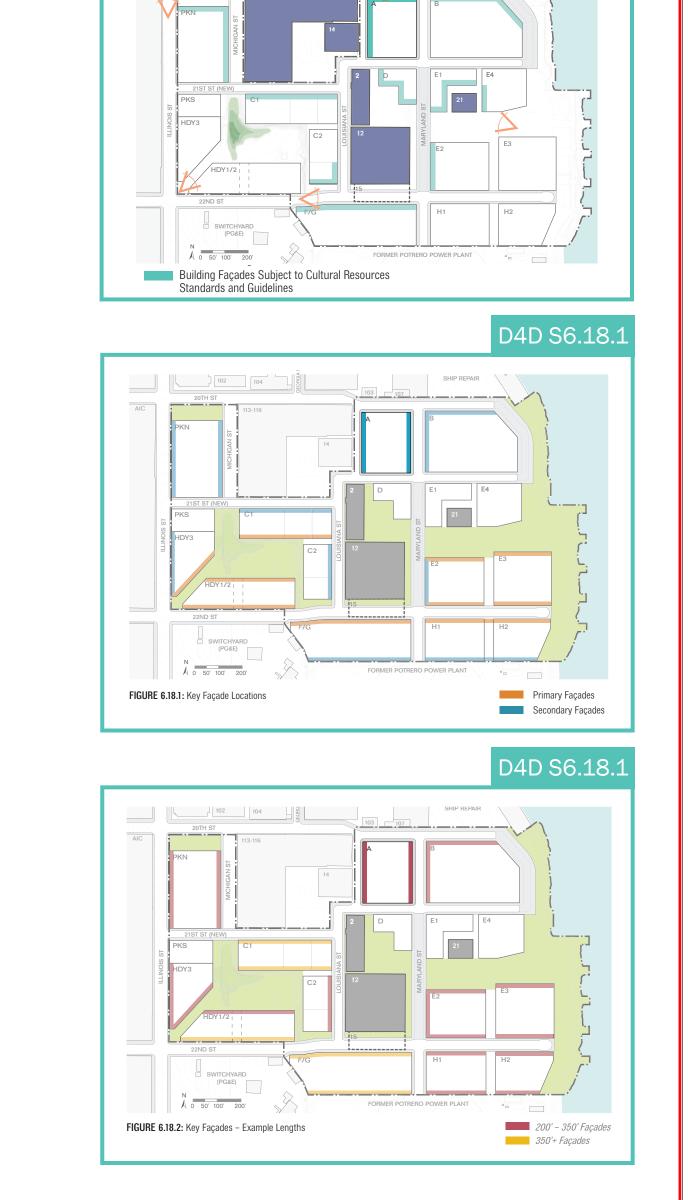


D4D S6.15.1

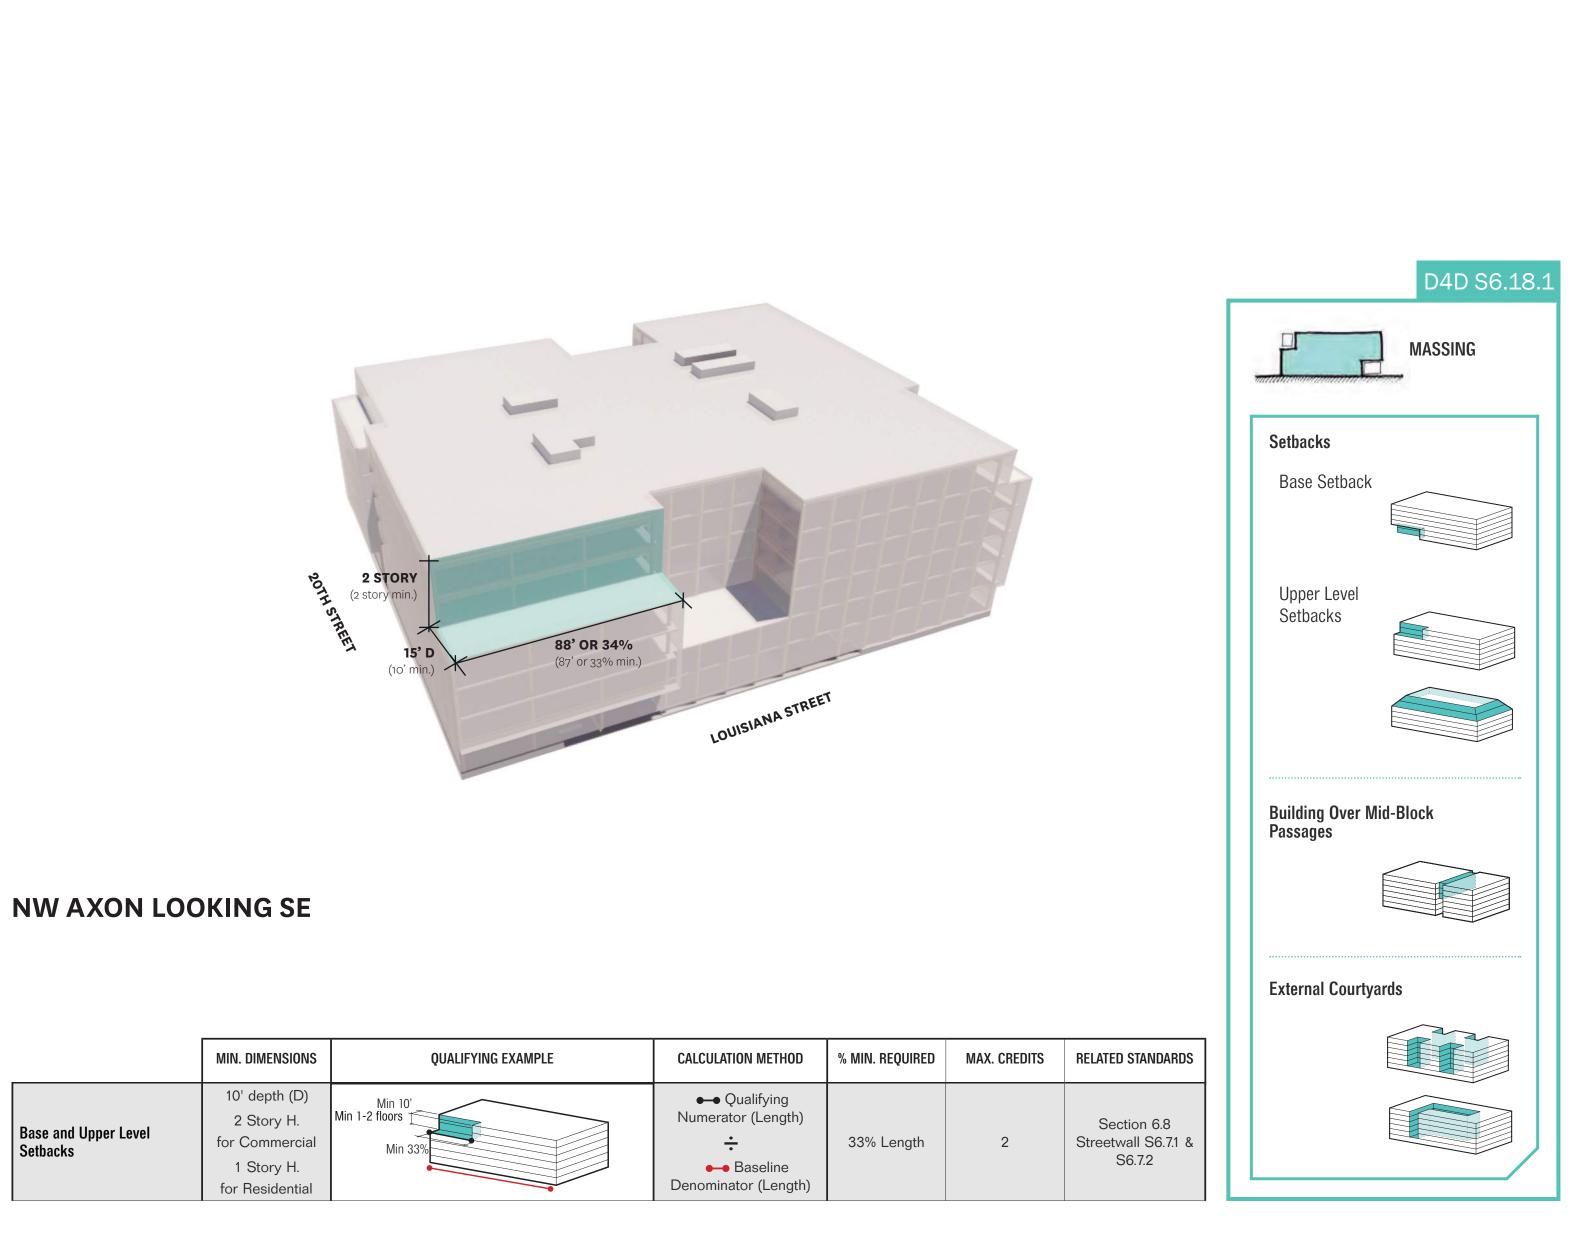

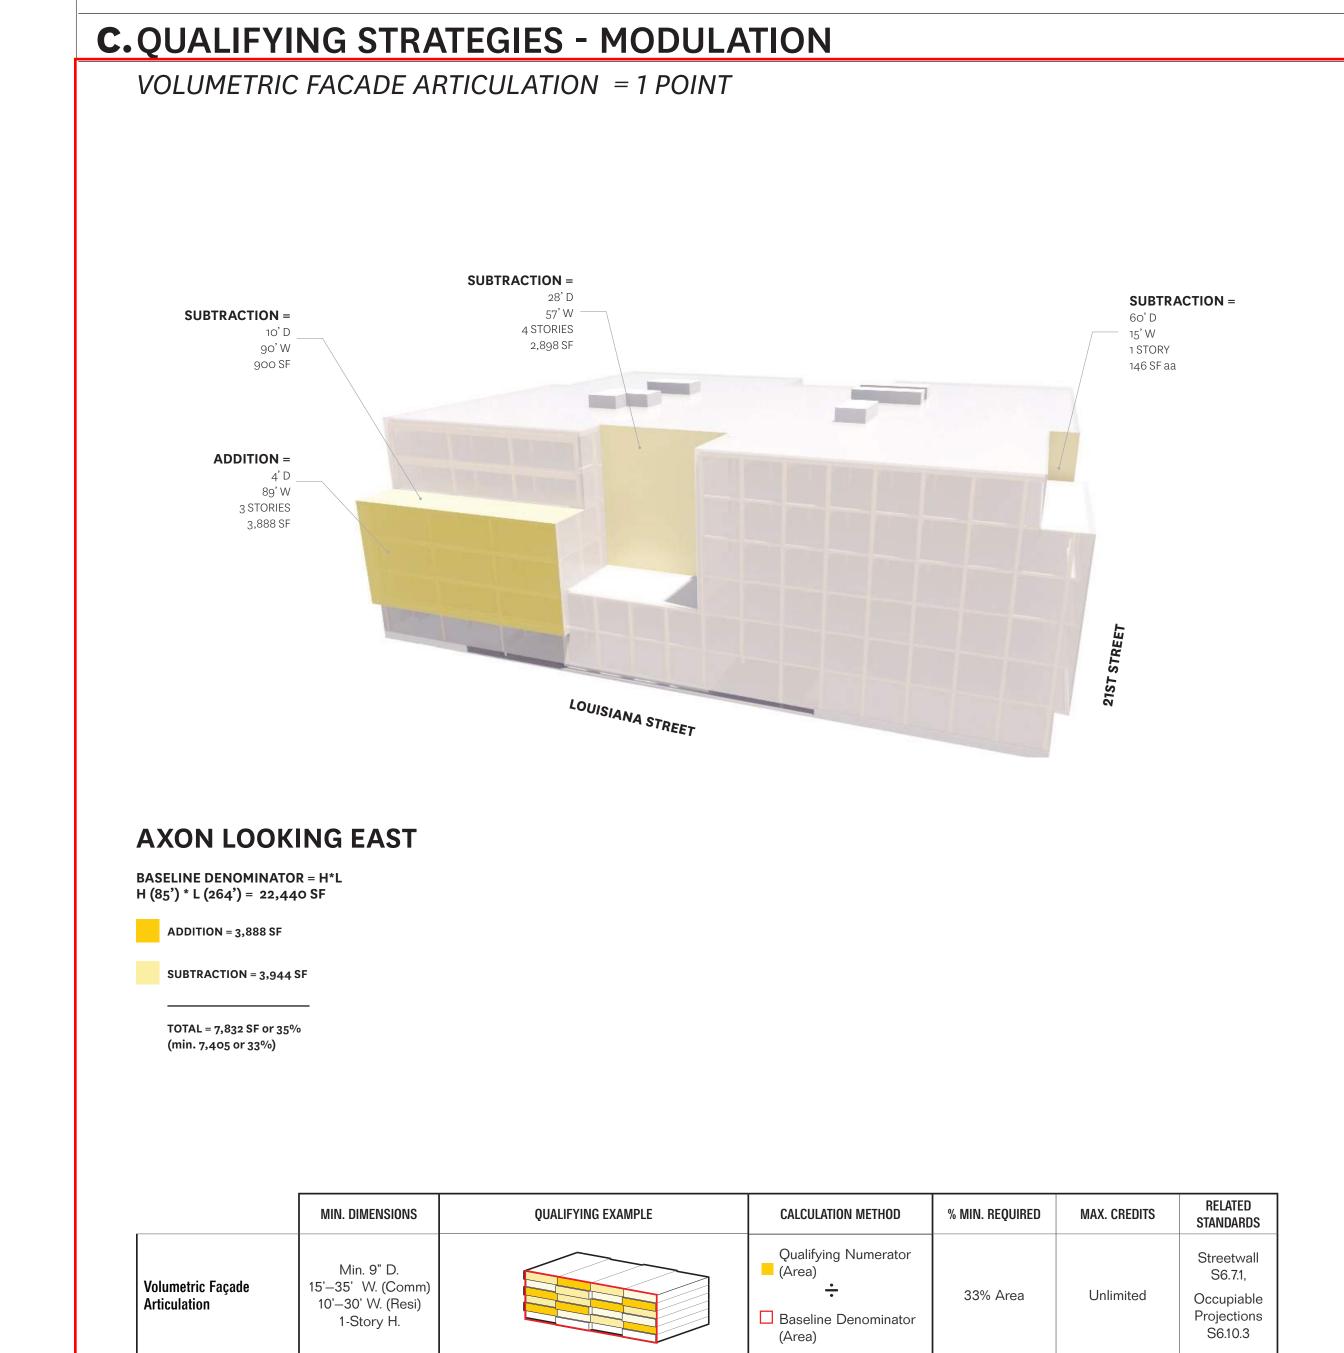


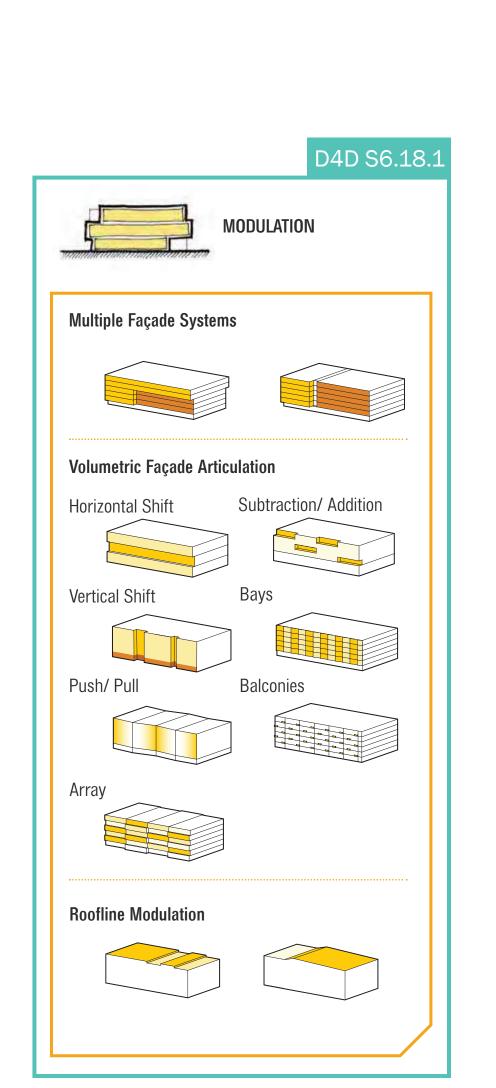

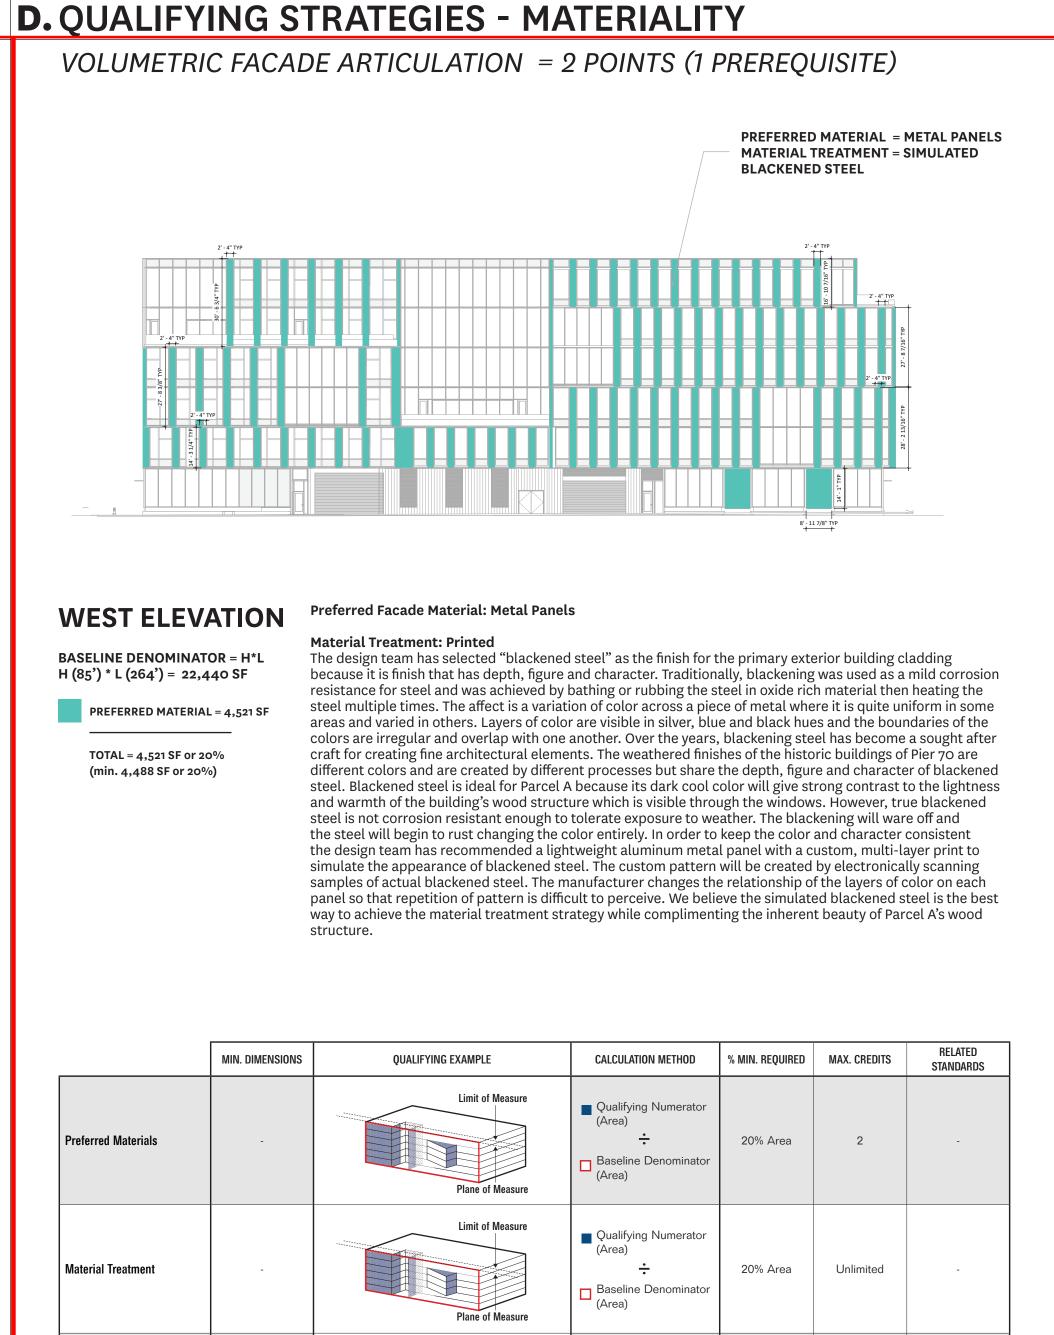

B. QUALIFYING STRATEGIES -MASSING

BASE AND UPPER LEVEL SETBACKS = 1 POINT (1 PREREQUISITE)

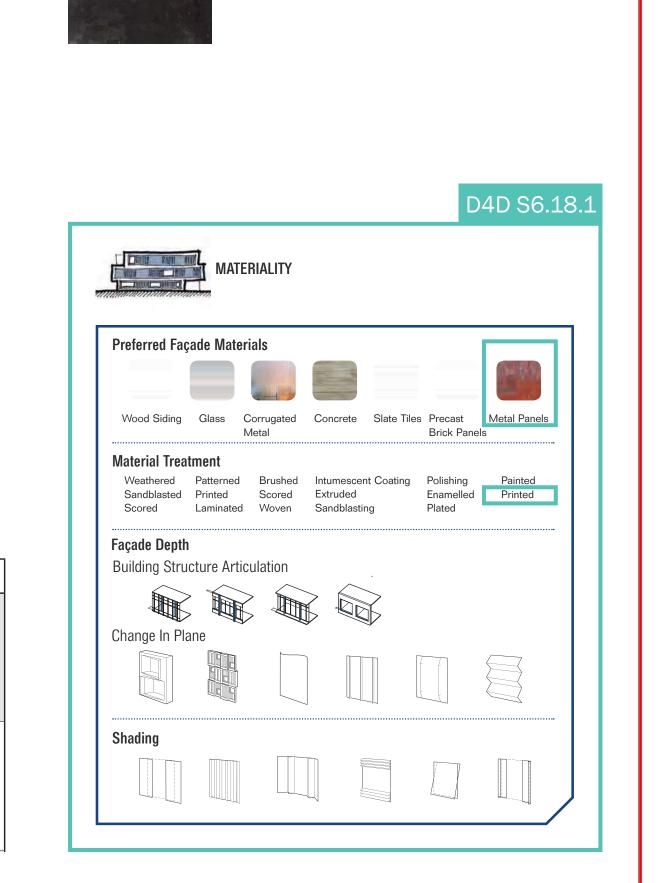

PREFERRED MATERIAL WITH

MTL CLADDING 1

Dark Gray/Black Simulated Blackened Steel

MATERIAL TREATMENT



733 SW Oak, Portland, OR 97205

QA

ARCHITECTS


639 FRONT ST, SAN FRANCISCO, CA 94111

CONSULTANT

Mayor ED 17-02 Priority permit

SITE PERMIT

THIS APPLICATION SUBMITTED FOR SITE PERMIT ONLY. NO WORK MAY BE STARTED UNTIL CONSTRUCTION PLANS HAVE BEEN APPROVED.

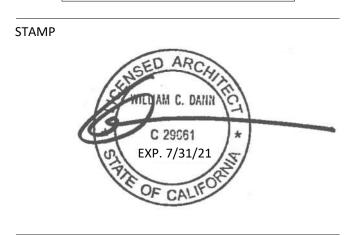

DATE

KEY PLAN - (NTS)

REVISION NO.

TRUE PLAN NORTH

PIER 70

BrookfieldProperties

BROOKFIELD PROPERTIES
PIER 70 PARCEL A

ISSUANCE
SITE PERMIT
PROJECT NUMBER
1830
DATE

SEPTEMBER 04, 2019

DAD COMPLIANCE

SHEET NUMBER



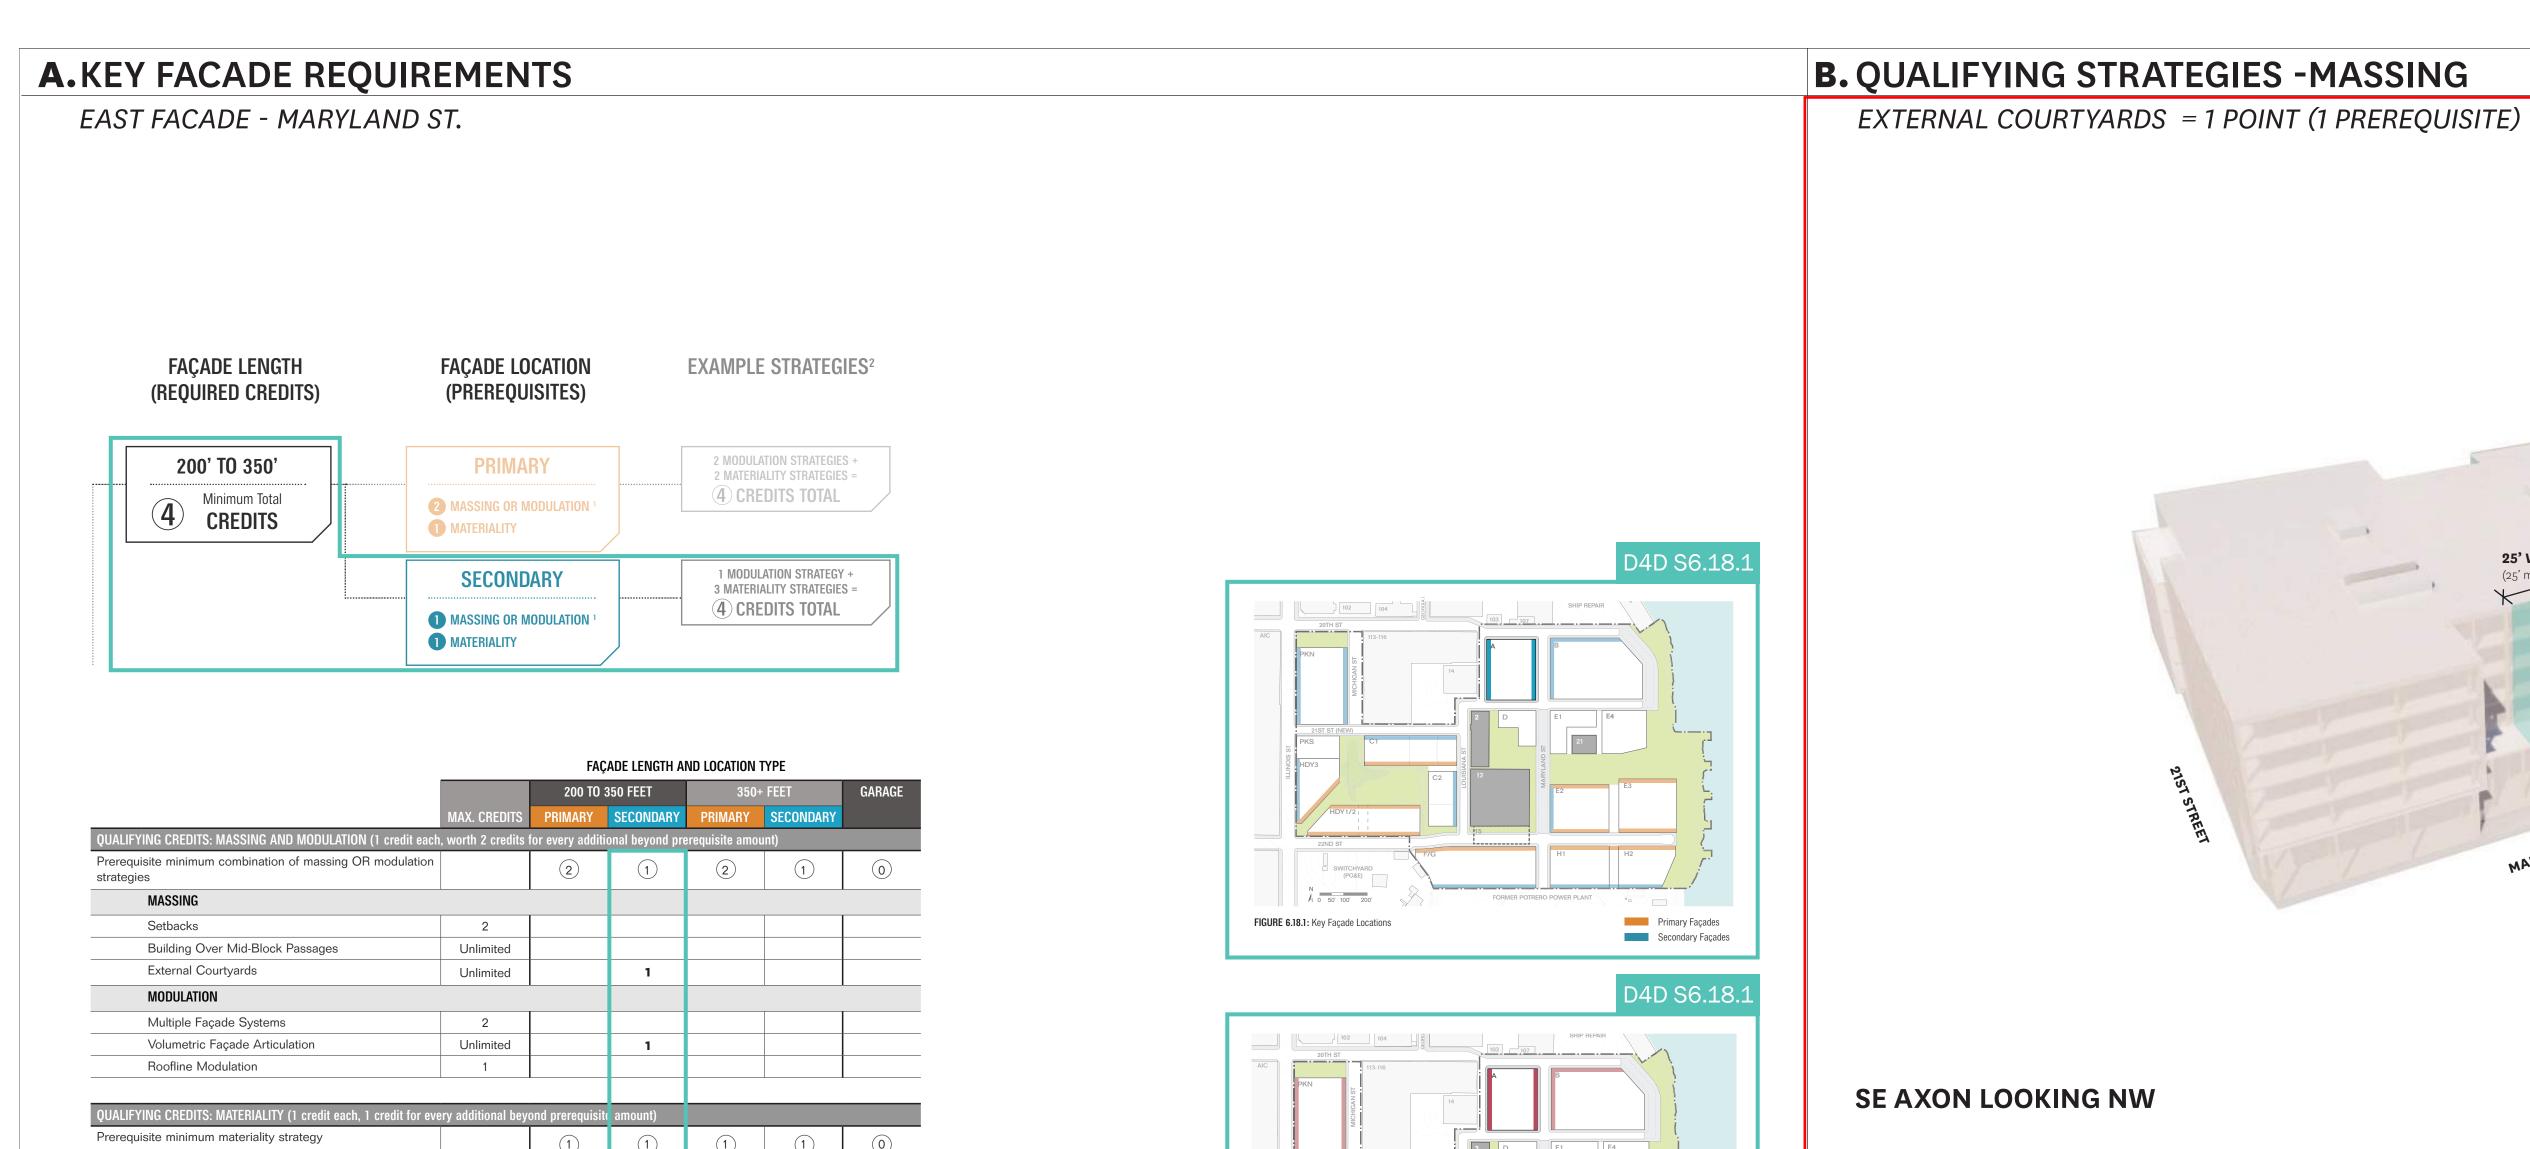


FIGURE 6.18.2: Key Façades - Example Lengths

350'+ Façades

Subtraction/ Addition

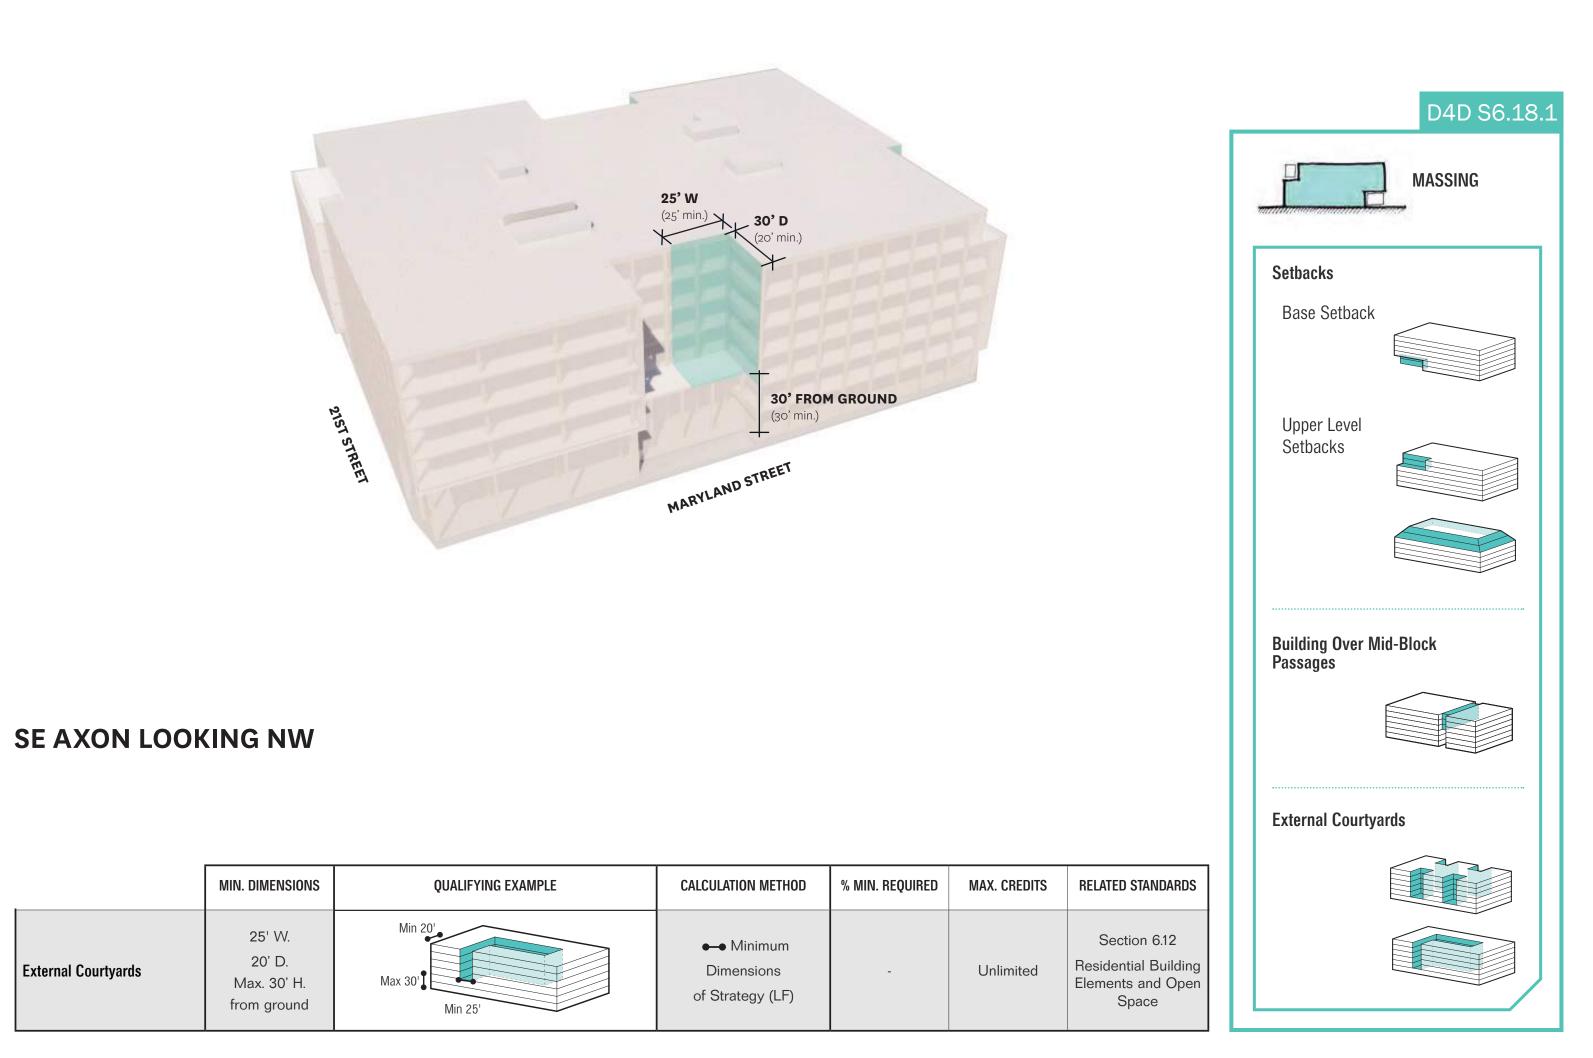

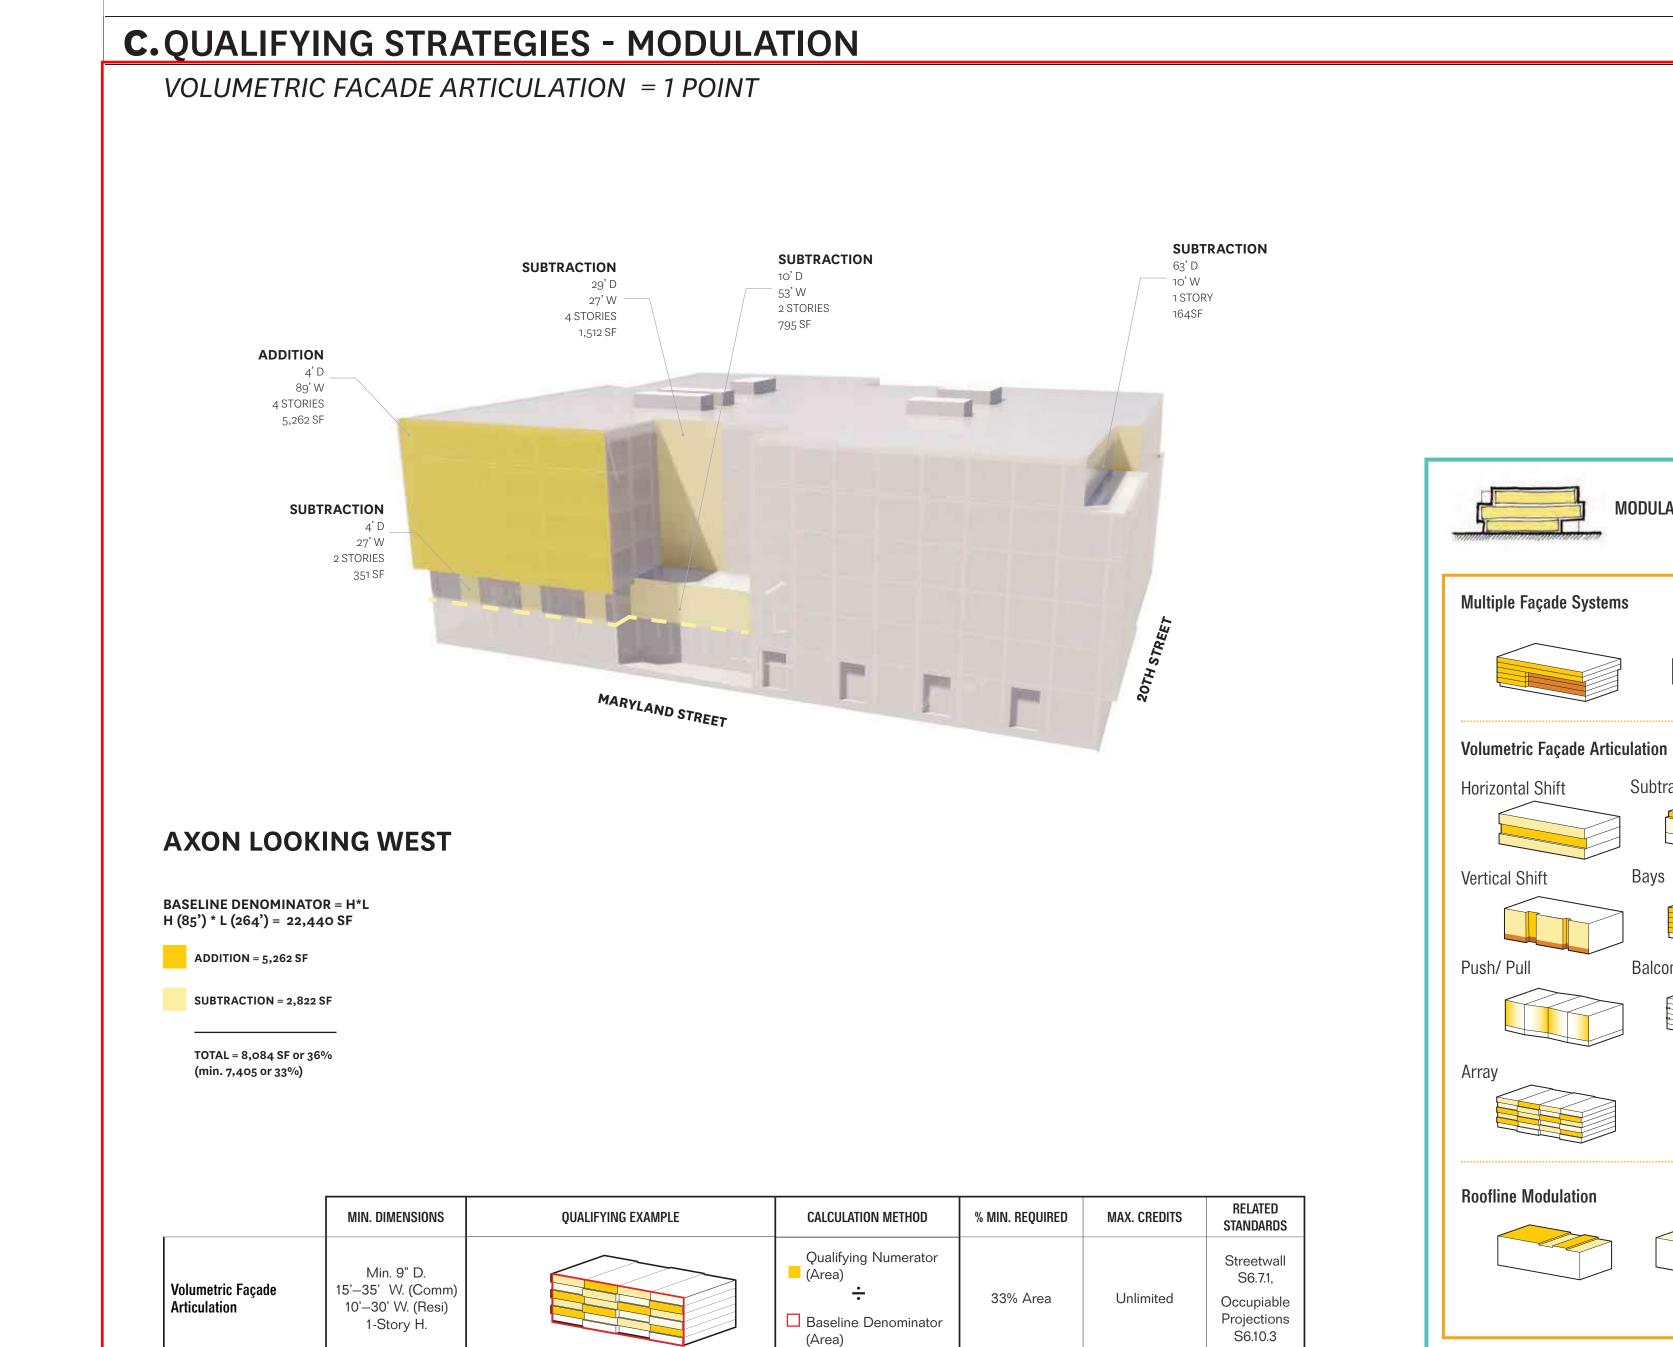

Preferred Materials

QUALIFYING CREDITS: CREATIVE DESIGN (1 CREDIT)

Does this project meet minimum requirements? (Y/N)

TOTAL CREDITS REQUIRED

TOTAL CREDITS PROVIDED


Façade Depth

Shading

Unlimited


Unlimited

Unlimited

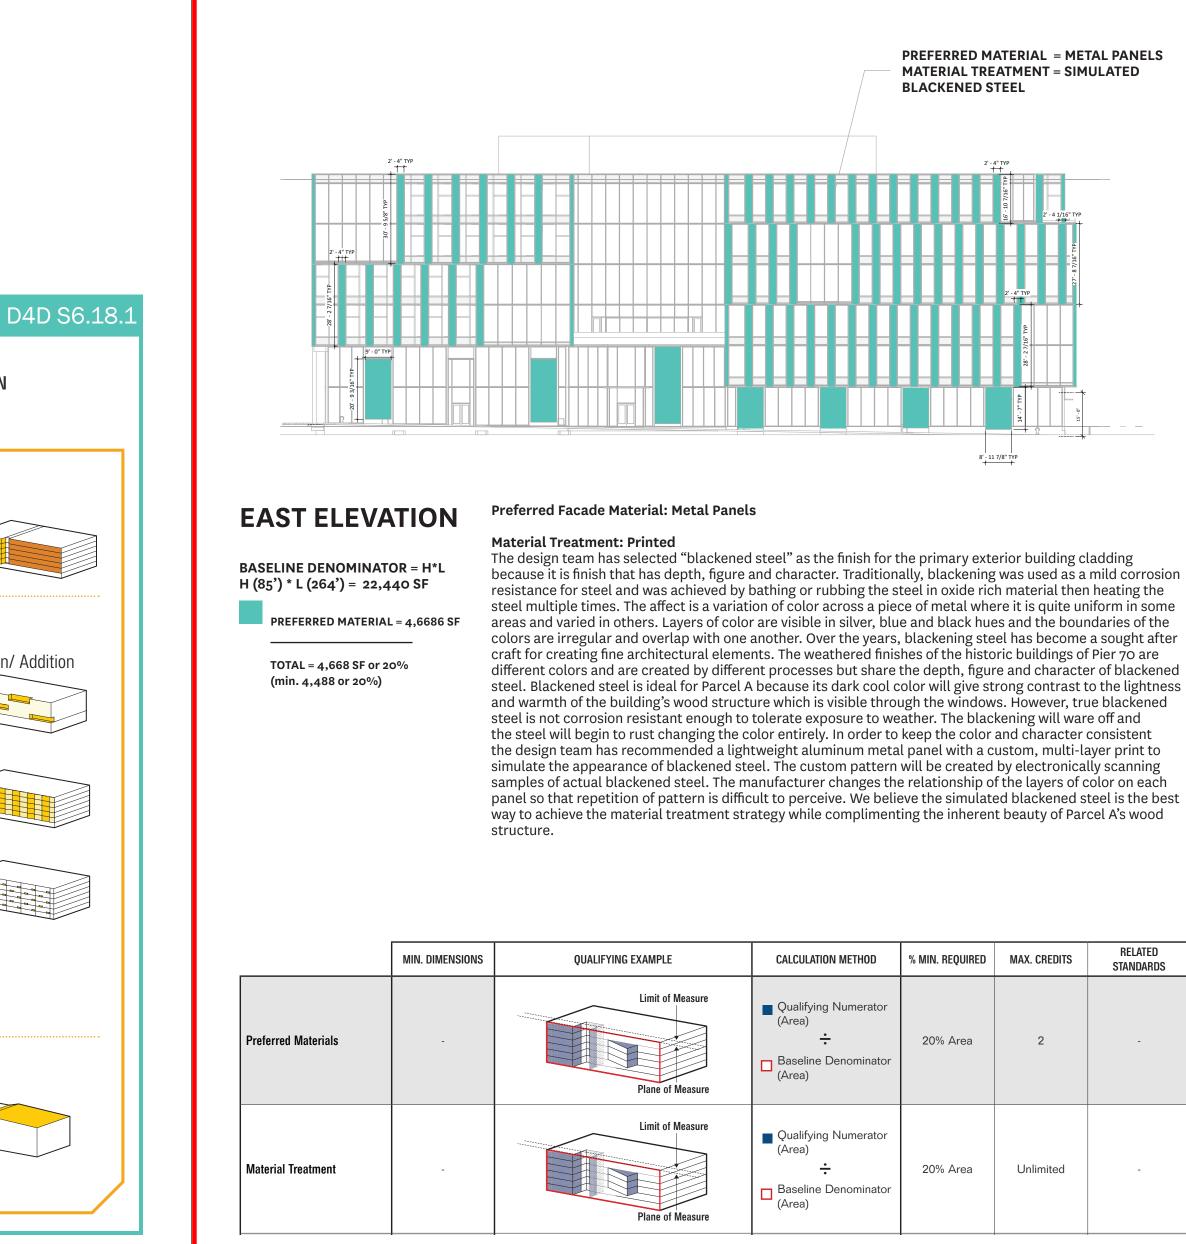

D. QUALIFYING STRATEGIES - MATERIALITY

VOLUMETRIC FACADE ARTICULATION = 2 POINTS (1 PREREQUISITE)

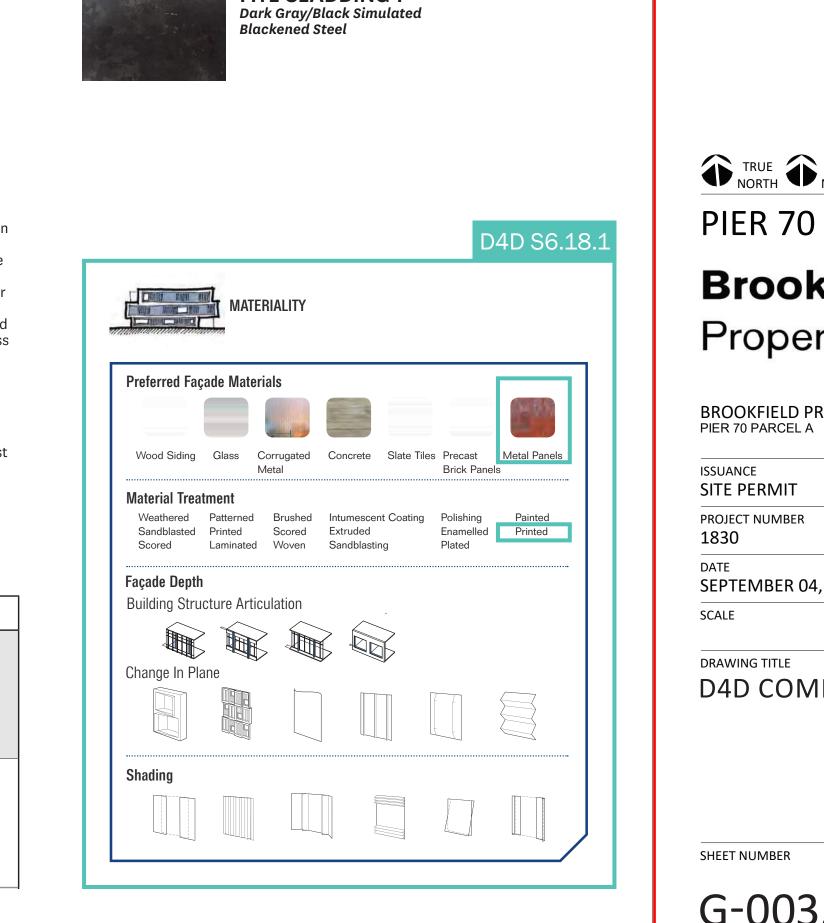

PREFERRED MATERIAL WITH

MTL CLADDING 1

MATERIAL TREATMENT

Mayor ED 17-02 Priority permit

HACKER

733 SW Oak, Portland, OR 97205


639 FRONT ST, SAN FRANCISCO, CA 94111

ARCHITECTS

QA

CONSULTANT



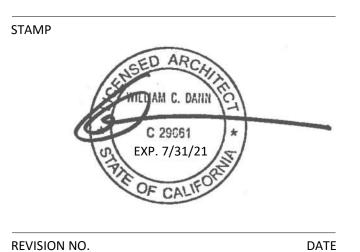

KEY PLAN - (NTS)

TRUE PLAN NORTH


Brookfield

Properties

BROOKFIELD PROPERTIES PIER 70 PARCEL A

SITE PERMIT PROJECT NUMBER SEPTEMBER 04, 2019

DRAWING TITLE D4D COMPLIANCE

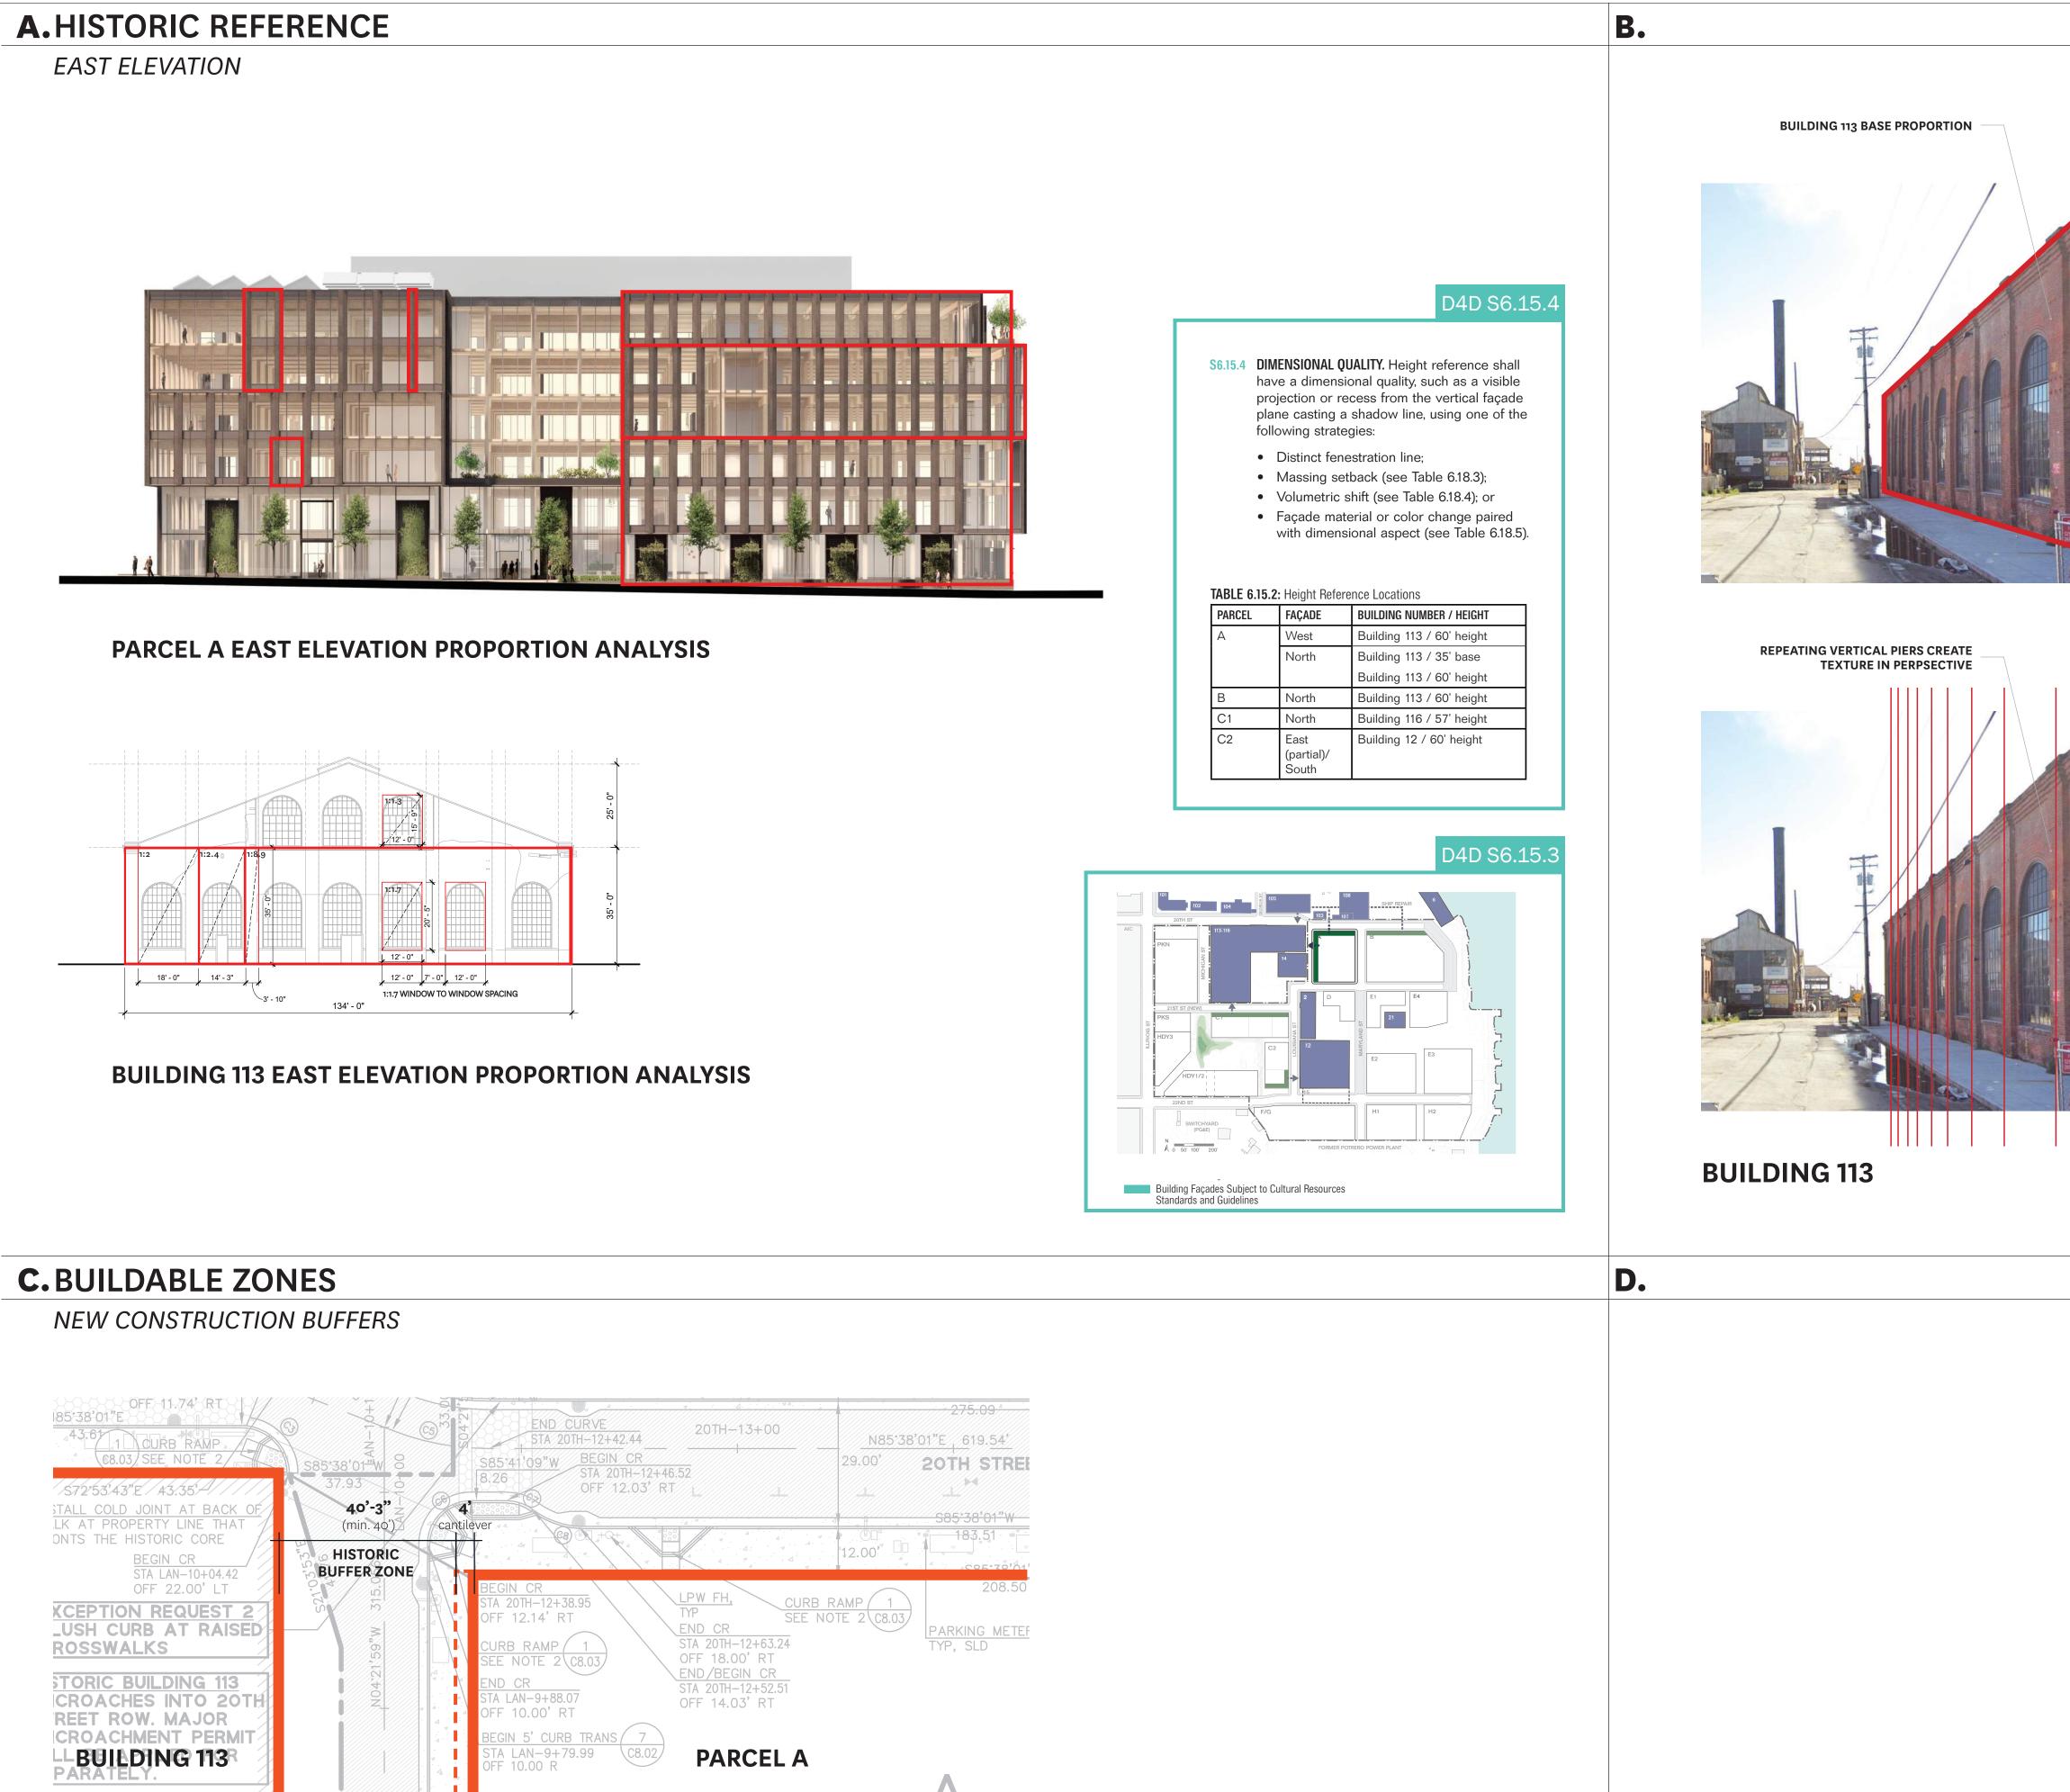

D4D F6.3.2

SITE IMPROVMENT PLAN - NW CORNER

N85°38'01"E

SITE IMPROVMENT PLAN - SW CORNER

BUILDING 113

PARCEL A

CURB_RAMP_/ 1_\displays \displays \d

OFF 11.00' LT

CURB RAMP 1


SEE NOTE 2 CP 07

188,75

21E-11+00

OFF 18.00' R SEE NOTE 1 N 0 50, 100, 500,

te: Construction buffer at Michigan Street to be measured from the façade Building 113, excluding any additions. All buffer zones to be measured from ilding footprint (historic building elements may encroach into buffer zones).

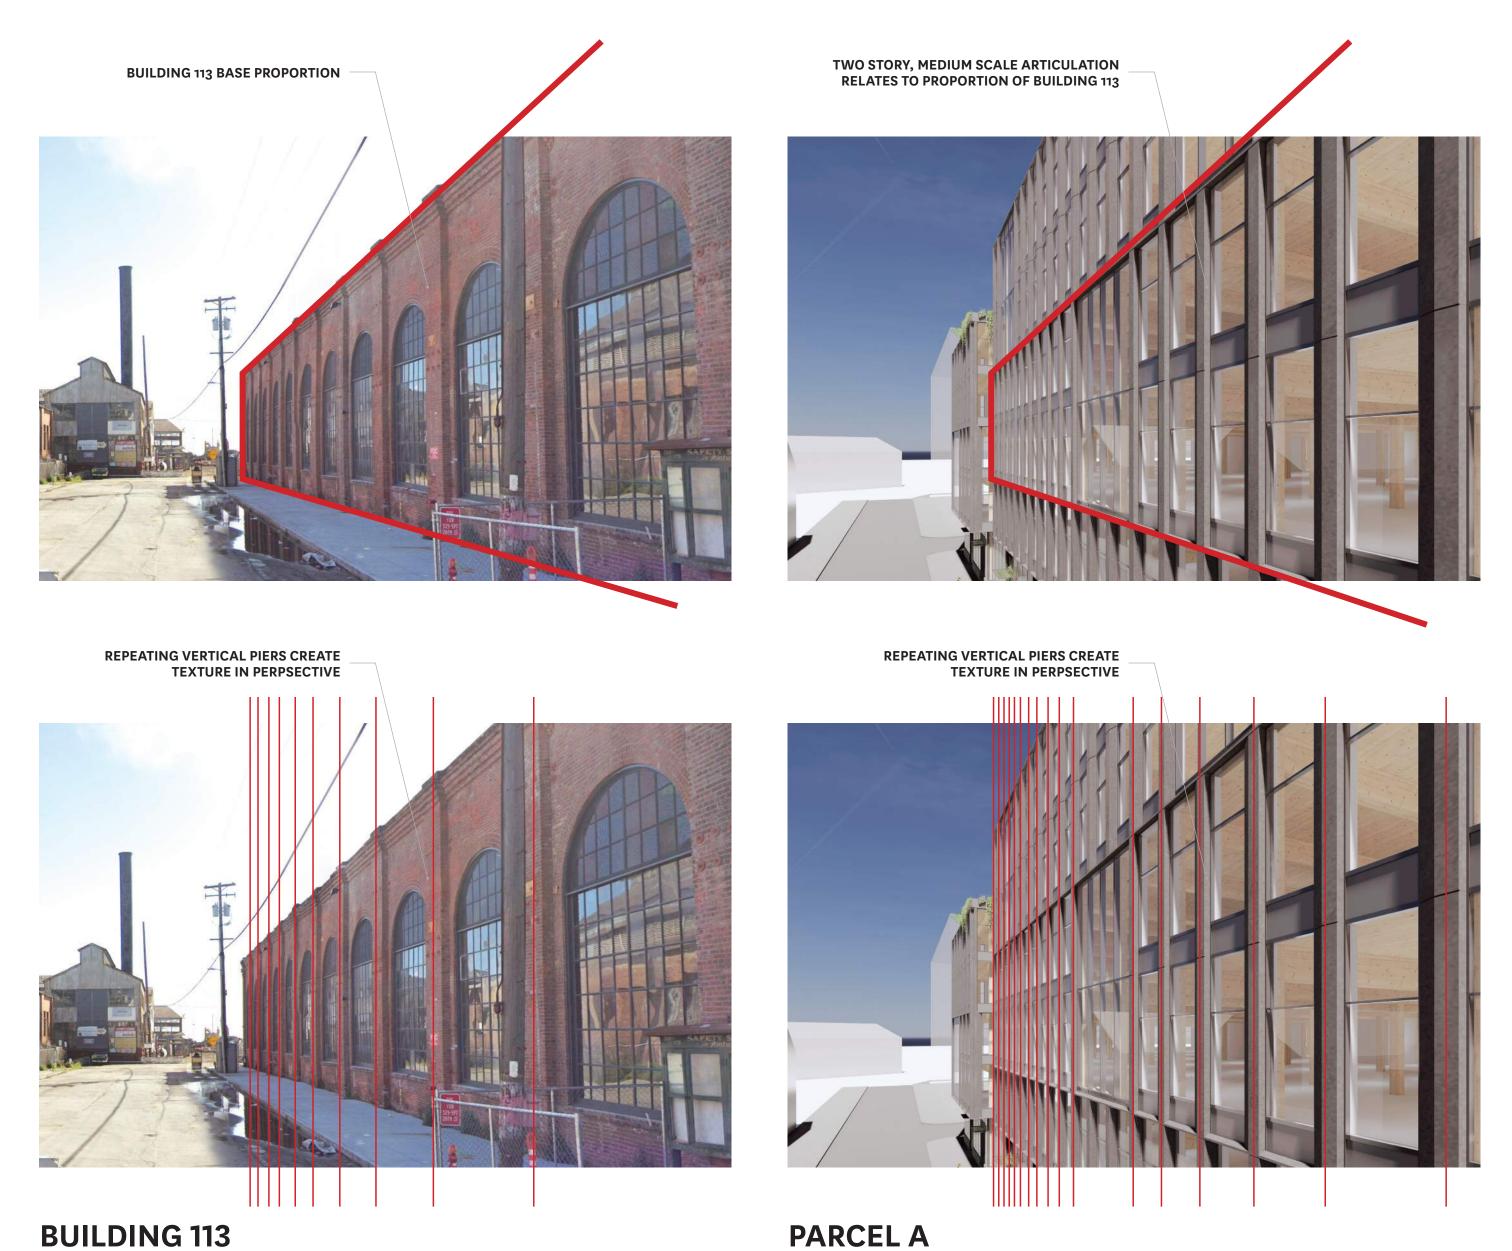



Mayor ED 17-02

Priority permit

ARCHITECTS

QA

CONSULTANT

HACKER

733 SW Oak, Portland, OR 97205

639 FRONT ST, SAN FRANCISCO, CA 94111

REVISION NO. DATE

KEY PLAN - (NTS)

TRUE PLAN NORTH

PIER 70

BrookfieldProperties

BROOKFIELD PROPERTIES PIER 70 PARCEL A

ISSITANICE

DESIGN REVIEW PACKAGE

1830 DATE

PROJECT NUMBER

DATE JULY 12, 2019

DRAWING TITLE

D4D COMPLIANCE

SHEET NUMBER

GENERAL NOTES

- 1. IT SHALL BE UNDERSTOOD THAT THE TERM "CITY ENGINEER" OR "THE CITY" AS USED HEREIN IS THE CITY ENGINEER OF THE CITY OF SAN FRANCISCO OR HIS AUTHORIZED REPRESENTATIVE AND THAT THE TERM "CHIEF HARBOR ENGINEER" AS USED HEREIN IS THE CHIEF HARBOR ENGINEER OF THE PORT OF SAN FRANCISCO OR HIS AUTHORIZED REPRESENTATIVE.
- 2. THE WORK SHOWN ON THESE PLANS SHALL BE CONSTRUCTED IN ACCORDANCE WITH CITY AND COUNTY OF SAN FRANCISCO STANDARD PLANS & SPECIFICATIONS, LATEST EDITION AND WITH APPROVED PIER 70 SUD PHASE 1 IMPROVEMENT PLANS AND SPECIFICATIONS.
- 3. ALL REVISIONS TO THESE PLANS MUST BE REVIEWED AND APPROVED IN WRITING BY THE DESIGN ENGINEER, BKF ENGINEERS AT (650)482-6300, PRIOR TO CONSTRUCTION OF AFFECTED ITEMS, REVISIONS SHALL BE ACCURATELY SHOWN ON REVISED PLANS.

EARTHWORK AND GRADING

1. GRADING AND EARTHWORK SHALL BE PERFORMED IN ACCORDANCE WITH THESE CONSTRUCTION DOCUMENTS AND THE REQUIREMENTS AND RECOMMENDATIONS FROM THE GEOTECHNICAL REPORT TITLED "ONSITE AND OFFSITE IMPROVEMENTS, PIER 70 -28-ACRE SITE, SAN FRANCISCO, CALIFORNIA, GEOTECHNICAL EXPLORATION" PREPARED BY ENGEO DATED JANUARY 5, 2018.

<u>UTILITIES</u>

WATER:

a. WATER WORKS SHALL BE IN ACCORDANCE WITH THE LATEST SAN FRANCISCO WATER DEPARTMENT STANDARD PLANS AND SPECIFICATIONS, AND SHALL BE SUBJECT TO INSPECTION BY THE DEPARTMENT.

LEGEND:	<u>PROPOSE</u>
PROPERTY/RIGHT OF WAY LINE	
PROJECT BOUNDARY LINE	
PARCEL LINES	
CENTERLINE	
CONTOUR LINE	14
COMBINED SEWER LINE	XX" CS
COMBINED SEWER FORCE MAIN	—XX" CSFM
AUXILIARY WATER SUPPLY SYSTEM	—XX" AWS
LOW PRESSURE WATER LINE	─XX" LPW
NON-POTABLE WATER LINE	—XX" NPW
COMBINED SEWER MANHOLE	
CATCH BASIN	
FIRE HYDRANT AND CLEARANCE SPACE	(+0+)
WATER VALVE	×
BACKFLOW PREVENTER	
AIR VALVE	
BLOW-OFF VALVE	•
UTILITY METER	F =]
PARKING METER	•
TRASH CAN	•
BENCH	
STREET LIGHT	
STREET TREE	
BIKE RACK	

ABBREVIATIONS:

AWSS AUXILIARY WATER SUPPLY SYSTEM BLDG BUILDING BW BACK OF WALK CS COMBINED SEWER CSFM COMBINED SEWER FORCE MAIN INFORMATION BULLETIN FIRE ACCESS ZONE

R/W,ROW RIGHT-OF-WAY LOW PRESSURE WATER NPW NON-POTABLE WATER STORM DRAIN SANITARY SEWER TOP OF CURB TOP OF PAVEMENT TYPICAL

FIRE WATER

FLOW LINE

FW

ARCHITECTS

HACKER

733 SW Oak, Portland, OR 97205

639 FRONT ST, SAN FRANCISCO, CA 94111

CONSULTANT

ENGINEERS . SURVEYORS . PLANNERS 150 CALIFORNIA STREET, SUITE 600 SAN FRANCISCO, CA 94111 (415) 930–7900 www.bkf.com

STAMP

NOT FOR CONSTRUCTION

REVISION NO.

KEY PLAN - (NTS)

TRUE PLAN NORTH

Project Name

Brookfield Properties

BROOKFIELD PROPERTIES PIER 70 PARCEL A

50% SD SET 20170209 ClientProjectNo.


NOTES, LEGEND, AND **ABBREVIATIONS**

SHEET NUMBER

C-01

NOTE:

DETAILS FOR IMPROVEMENTS ON FRONTAGES, INCLUDING BUT NOT LIMITED TO CURB AND GUTTER, DRIVEWAYS, SIDEWALKS, ETC. ARE INCLUDED IN THE PIER 70 SUD PHASE 1 IMPROVEMENT PLANS, PERMIT 19IE—00245.

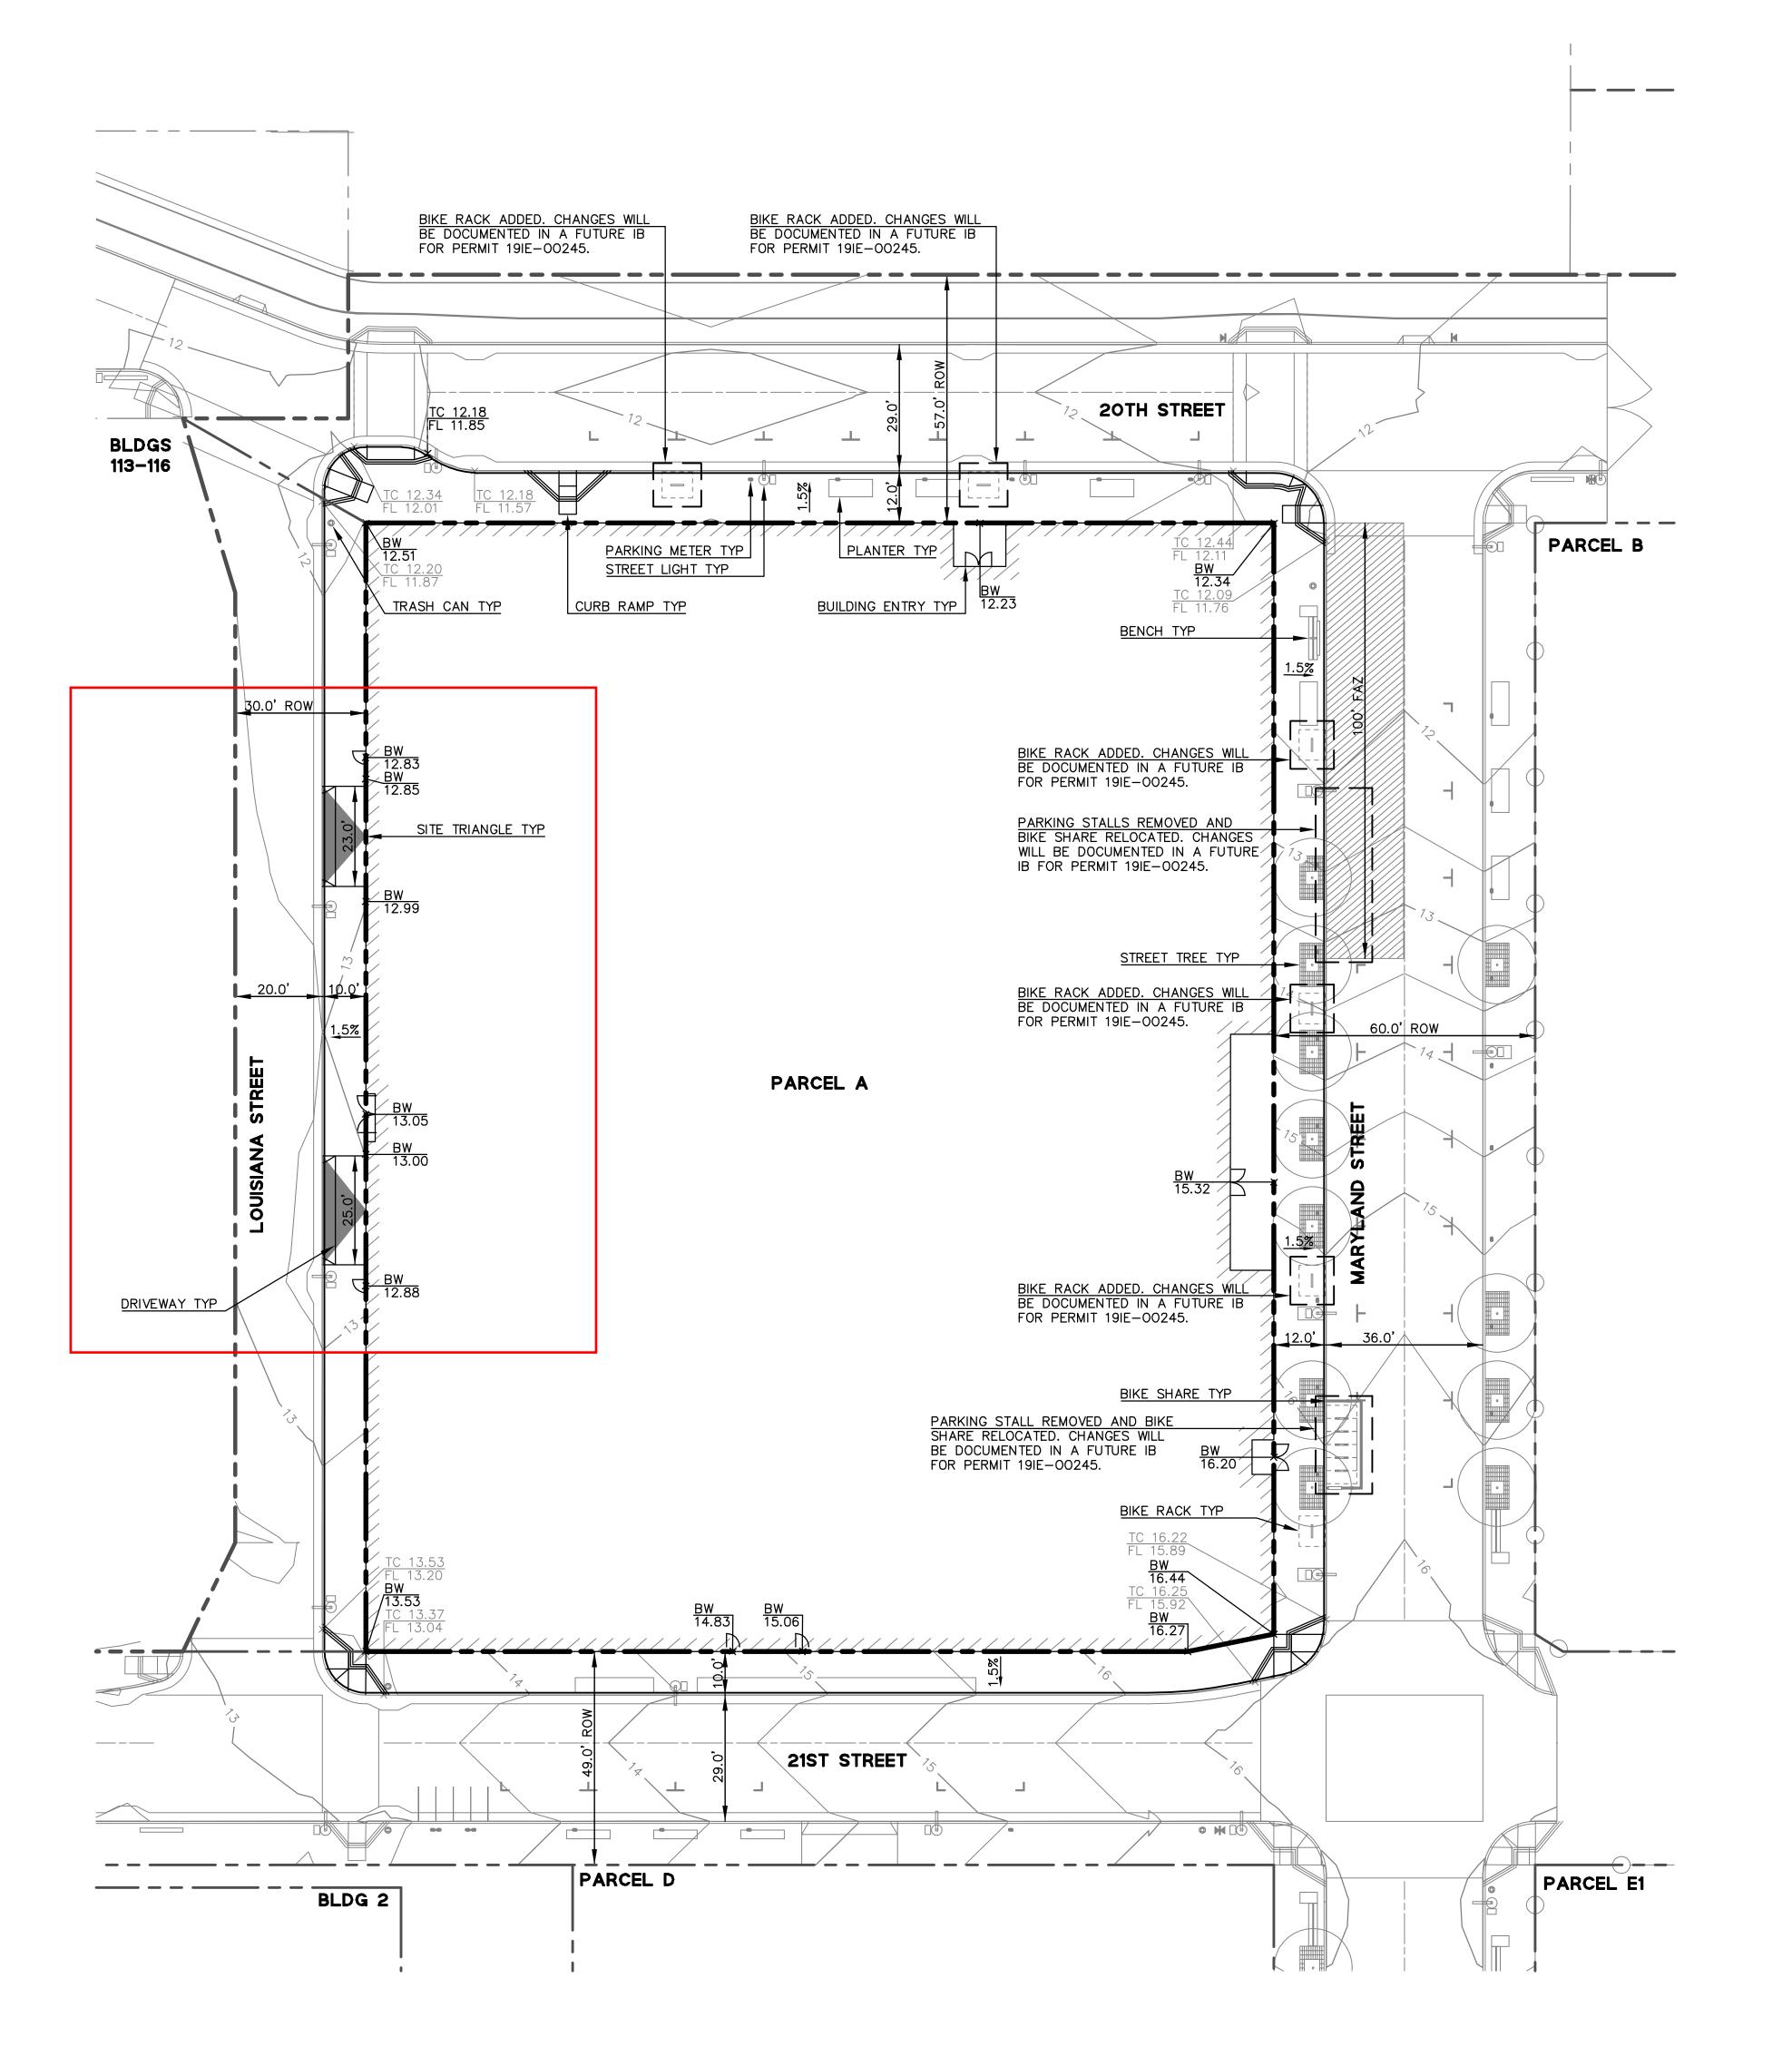

ARCHITECTS

HACKER

733 SW Oak, Portland, OR 97205

639 FRONT ST, SAN FRANCISCO, CA 94111

150 CALIFORNIA STREET, SUITE 600 SAN FRANCISCO, CA 94111 (415) 930-7900 www.bkf.com

NOT FOR CONSTRUCTION

DATE REVISION NO.

KEY PLAN - (NTS)

TRUE PLAN NORTH

Project Name

Brookfield

Properties

BROOKFIELD PROPERTIES PIER 70 PARCEL A


ISSUANCE 50% SD SET


ClientProjectNo. 20170209

1" = 20'

SITE PLAN AND GRADING

NOTE:
THESE PLANS INCLUDE INFRASTRUCTURE TO BE INSTALLED PER THE APPROVED PIER 70 SUD
PHASE 1 IMPROVEMENT PLANS. SEWER AND STORM DRAIN LATERALS ARE ASSUMED TO BE
INSTALLED TO BACK OF WALK, AND WATER LATERALS TO BACK OF CURB FOR METER
INSTALLATION BY PROJECT AND LATERAL EXTENSIONS TO POC AT BUILDING. HORIZONTAL
DEVELOPMENT TEAM IS COORDINATING WITH SFPUC TO CONFIRM SCOPE OF IMPROVEMENTS TO
BE INCLUDED WITH HORIZONTAL IMPROVEMENTS FOR COORDINATION OF SCOPE WITH VERTICAL
DEVELOPMENTS.

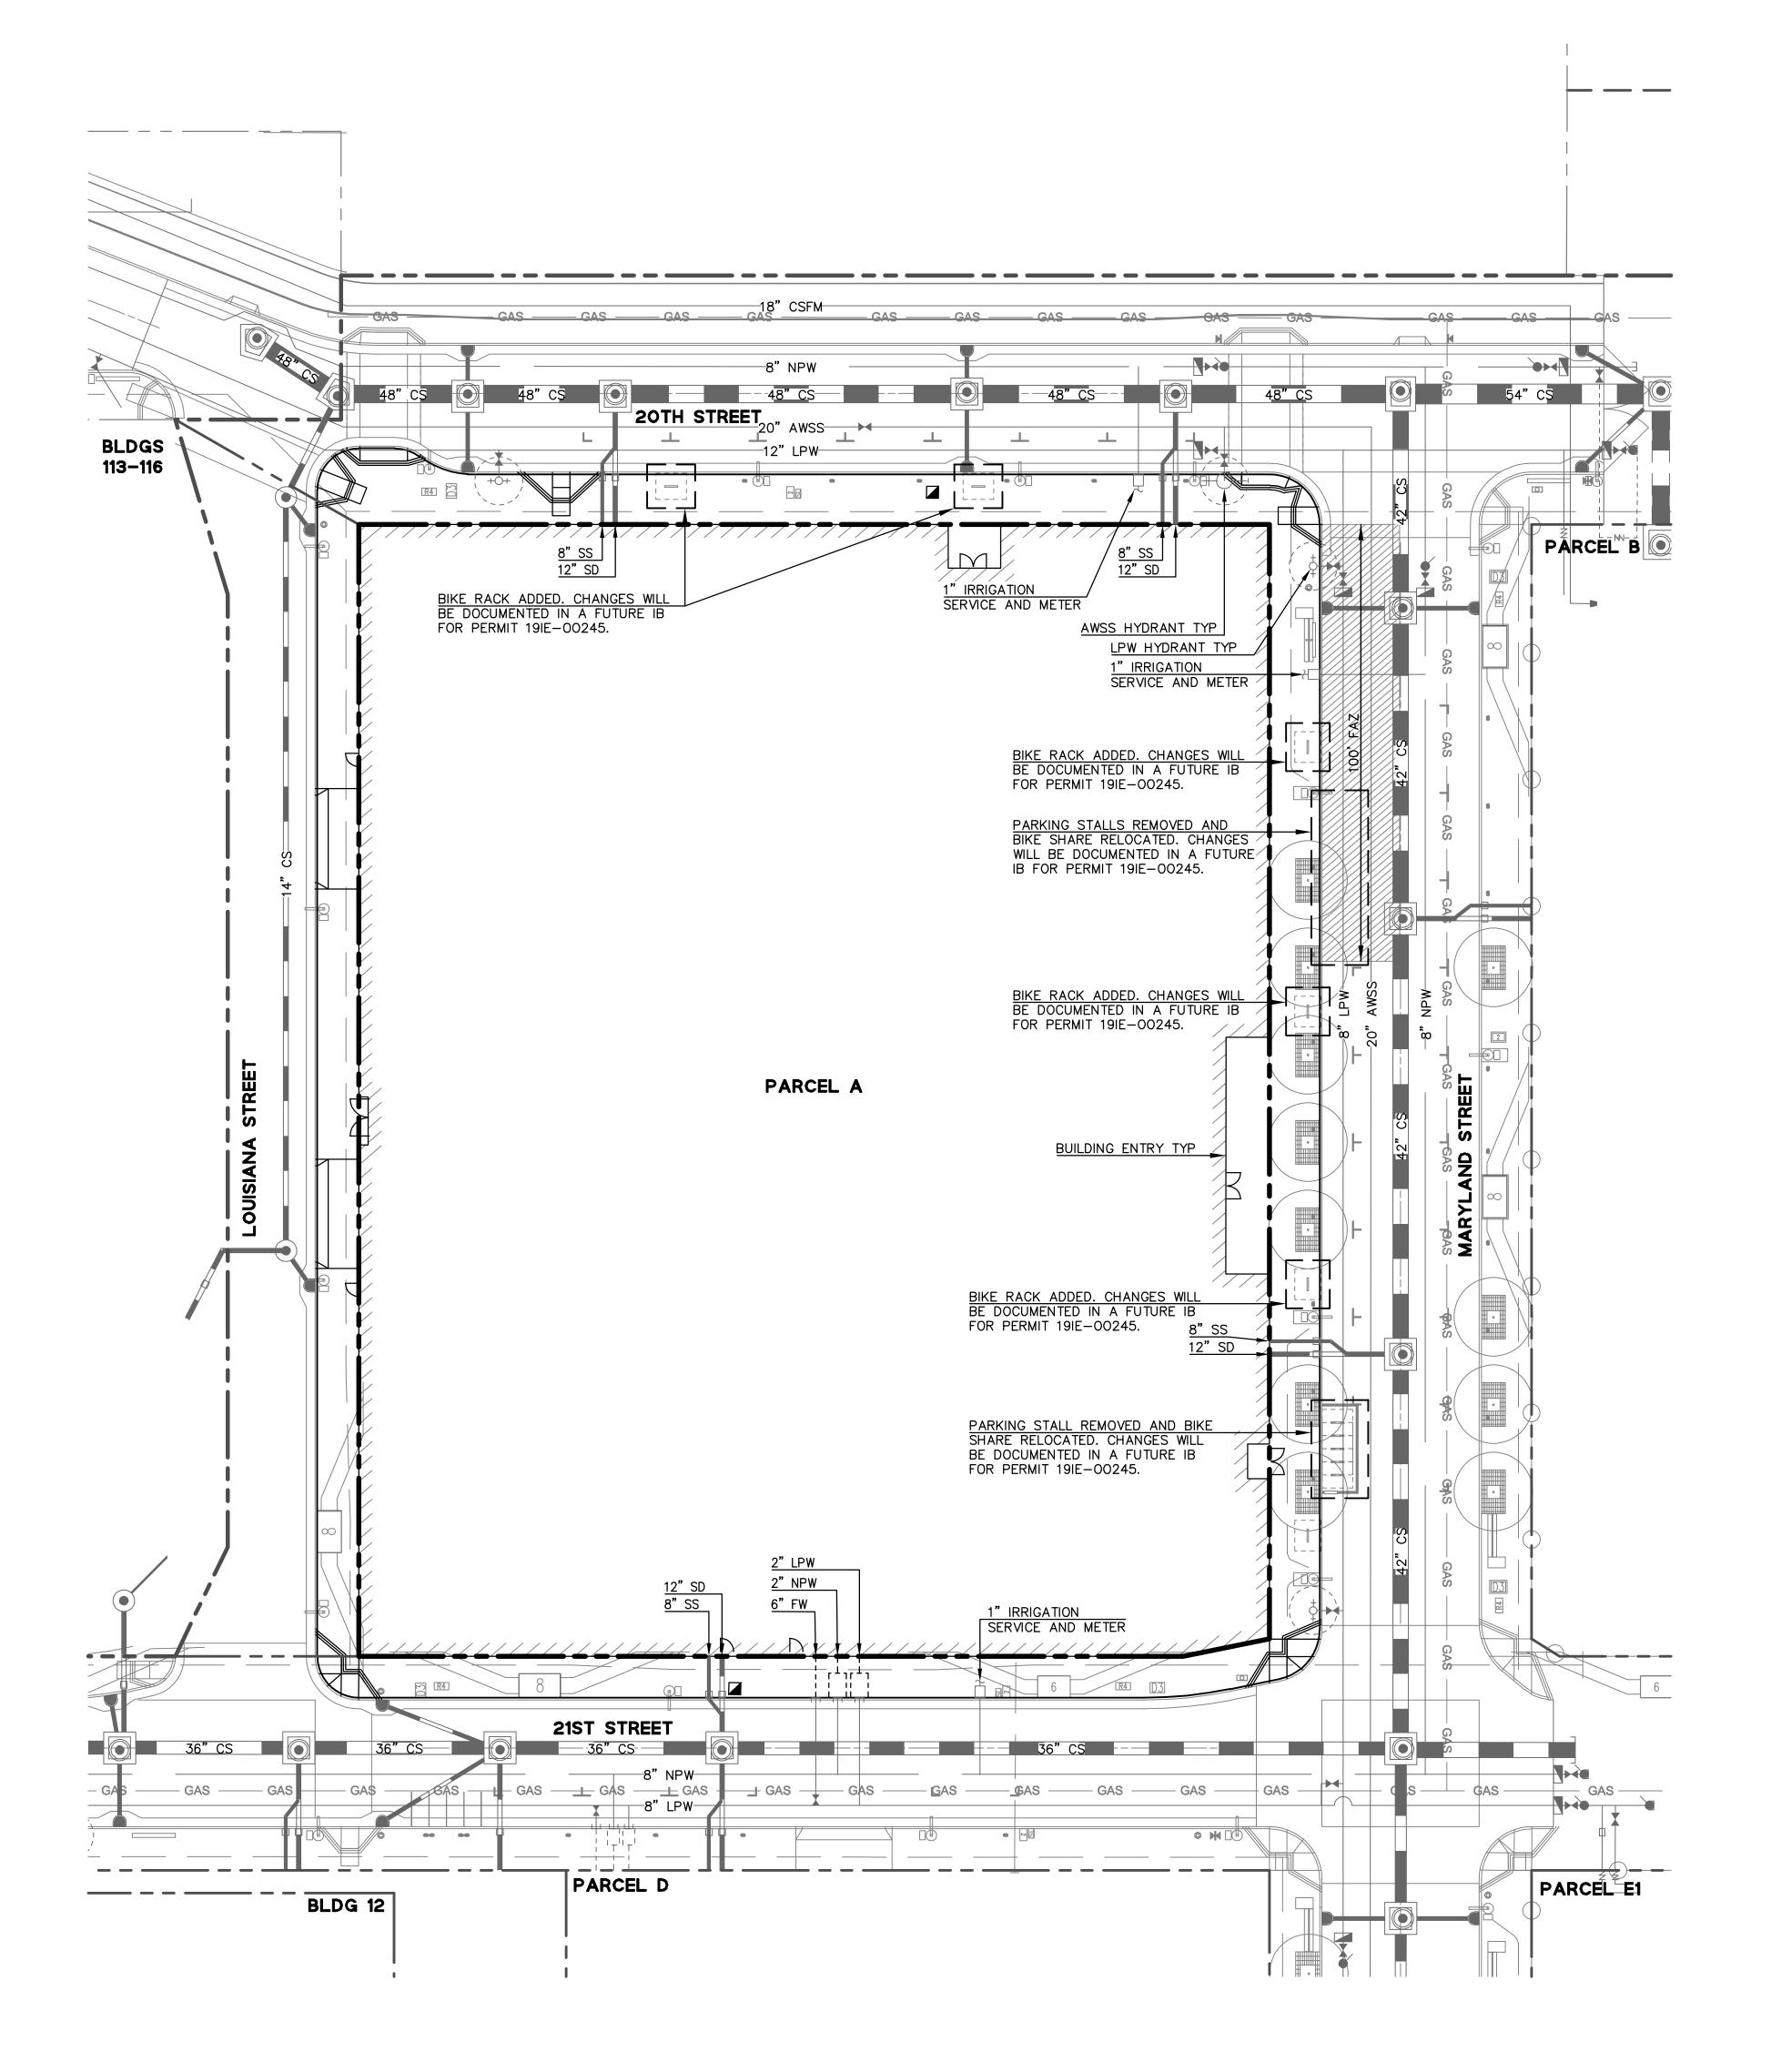

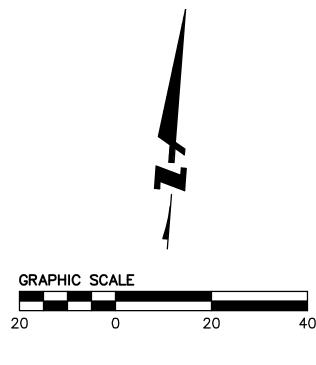

ARCHITECTS

HACKER

733 SW Oak, Portland, OR 97205

QA

639 FRONT ST, SAN FRANCISCO, CA 94111

CONSULTANT

ENGINEERS . SURVEYORS . PLANNERS

150 CALIFORNIA STREET,
SUITE 600
SAN FRANCISCO, CA 94111
(415) 930-7900
www.bkf.com

STAMP

NOT FOR CONSTRUCTION

REVISION NO.

KEY PLAN - (NTS)

TRUE PLAN NORTH

Project Name

BrookfieldProperties

BROOKFIELD PROPERTIES PIER 70 PARCEL A


50% SD SET
PROJECT NUMBER
20170209

ISSUANCE

20170209 ClientProjectNo.

SCALE 1" = 20'

DRAWING TITLE
UTILITY PLAN

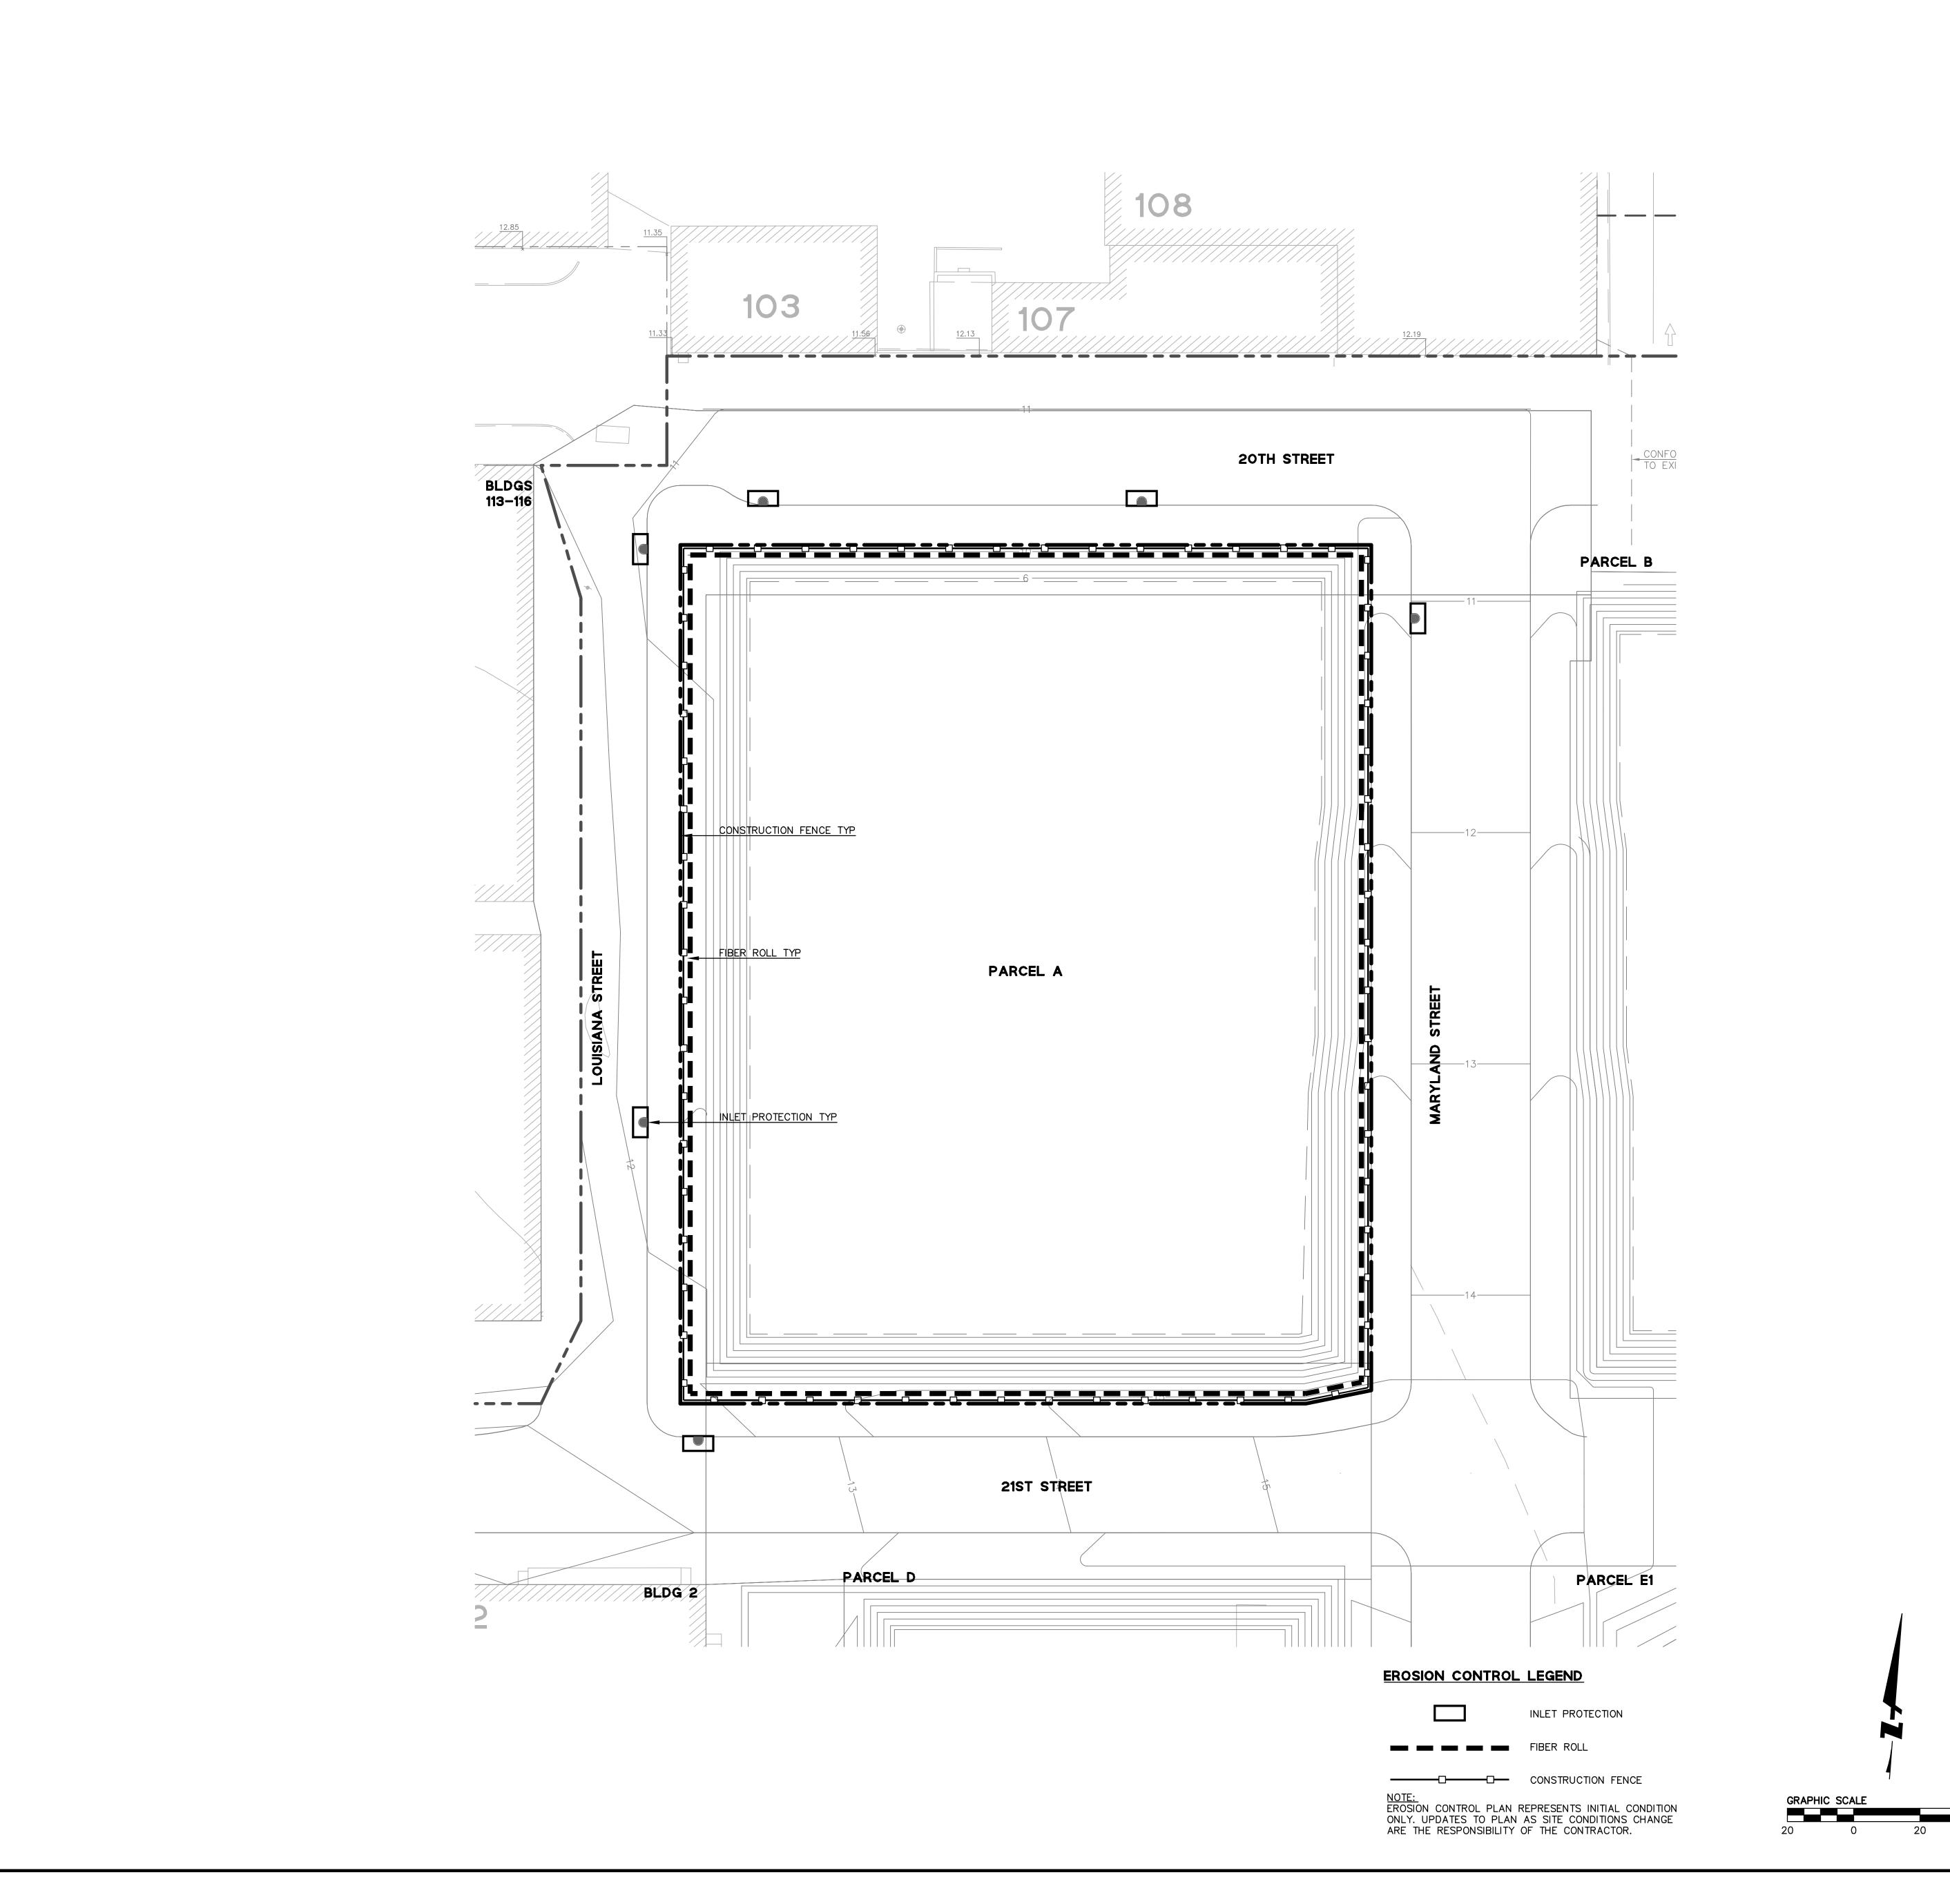

HACKER

733 SW Oak, Portland, OR 97205

QA

639 FRONT ST, SAN FRANCISCO, CA 94111

339 FRUNI

ENGINEERS . SURVEYORS . PLANNERS
150 CALIFORNIA STREET,
SUITE 600
SAN FRANCISCO, CA 94111
(415) 930-7900
www.bkf.com

STAMP

NOT FOR CONSTRUCTION

EVISION NO.

KEY PLAN - (NTS)

TRUE PLAN NORTH

Project Name

BrookfieldProperties

BROOKFIELD PROPERTIES PIER 70 PARCEL A

ISSUANCE
50% SD SET

PROJECT NUMBER
20170209 ClientProjectNo.

SCALE 1" = 20'

DRAWING TITLE
EROSION CONTROL PLAN

ABBREVIATIONS

@	at	CHNL	channel	ELEV	elevation	GA	gauge	LC	lighting controls			RND	round	т	tread	w	west
&	and	CIP	cast-in-place	EMER	emergency	GALV	galvanized	LF	linear foot or feet	PADB	power actuated door button	RO	rough opening	ТВ	top of beam	W/	with
		CL	center line	ENCL	enclosure	GB	grab bar	LIB	library	PAF	powder actuated fastener	RS	roller shade	TC	traffic coating	WC	water closet
AB	anchor bolt	CLG	ceiling	ENGR	engineer	GBD	gypsum board	LIN	linoleum	PAV	paving or pavers	RV	roof vent	TCB	tackboard	WD	wood
ABV	above	CLR	clear	EO	electrical outlet	GC	general contractor	LS	light switch	PC	precast			TCS	tack strip	WDB	wood base
AC	air conditioning	CLK	clock	EP	electrical panel	GL	glass	LVR	louver	PCF	pounds per cubic foot	S	south	TEMP	temporary	WDW	window
ACOUST	acoustical	COND PT	conduit penetration	EPY	ероху	GND	ground			PEN	penetration	SB	splash block	TEMP GL	tempered glass	WGL	wire glass
ACP	acoustical ceiling panel	CMU	concrete masonry unit	EQ	equal	GYP	gypsum	M	metric	PERF	perforated	SBD	sliding barn door	TERM	termination	WHTBD	wheatboard
ACT	acoustical ceiling tile	CNTR	counter (flashing)	EQUIP	equipment			MACH	machine	PH	panic hardware	SCR	screen	T&G	tounge & groove	WID	width
A/C	asphaltic concrete	CJ	control joint	ESC	escutcheon	НВ	hose bibb	MAS	masonry	P/L	property line	SC	solid core	THERM	thermostat	W/O	without
AD	area drain	COL	column	EXH	exhaust	HC	handicap	MATL	material	PL	plate	SCHED	schedule	ТНК	thick	WOM	walk off mat
ADA	automatic door actuator	COMP	composite	EXP	expansion	HD	hair dryer/hand dryer	MAX	maximum	PLAM	plastic laminate	SD	soap dispenser	THRSH	threshold	WP	waterproofing
ADD	addendum	CONC	concrete	EXT	exterior	HDR	header	MB	marker board	PLAS	plaster	SECR	security card reader	THRU	through	WPNL	hdwd veneer wood panelin
ADJ	adjustable	CONT	continuous			HDW	hardware	MCP	metal ceiling panel	PLUMB	plumbing	SECT	section	TLT	toilet	WPS	wood plank system
AFF	above finish floor	CORR	corridor	FA	fire alarm - ref elec for type	HDWD	hardwood	MDF	medium density fiberboard	PLYWD	plywood	SF	square foot	то	top of	WR	waste receptacle
AFG	above finish grade	СР	cement plaster	FACP	fire alarm system control panel	HELP	help buzzer	MECH	mechanical	PNL	panel	SFTY	safety	TOC	top of concrete or curb	WRB	weather resistive barrier
AHU	air handling unit	СРТ	carpet	FAST	fastener	HGT	height	MEMB	membrane	PNT	paint	SFRM	spray fire-resistive material	тот	total	WSCT	wainscot
ALT	alternate	CR	card reader	FARA	fire alarm remote annunciator	HLB	horizontal louver blind	MFR	manufacturer	PP	push plate for ada operator	SH	shelf / shelving	TP	toilet partition	WT	weight
AL	aluminum	CS	channel screed	FA-V	fire alarm - visual	НМ	hollow metal	MH	manhole	PREFAB	prefabricated	SHD	window shade	TPD	toilet paper dispenser	WTR	water
ALK	autolock	СТ	ceramic tile	FA-VA	fire alarm - visual & audio	HNDRL	handrail	МНО	magnetic hold open	PRELIM	preliminary	SHTHG	sheathing	TPNG	topping	W/W	wall to wall
ALUM	aluminum	CT Base	ceramic tile base	FB 	flat bar	HORIZ	horizontal	MIN	minimum	PREMANUF	premanufactured	SHT	sheet	TRV	transition strip	WWF	welded wire fabric
AMT	amount 	CTR	center	FD	floor drain	HP	high performance	MISC	miscellaneous	PRJCTR	projector	SIM	similar	TS	thermal resistance valve	V50140	
ANOD	anodized	CUH	cabinet unit heater	FDN 	foundation	HR ·	hour	MO	masonry opening	PRM	primer	SLNT	sealant	TSD	toilet seat cover dispenser	XFRMR	transformer
APPROX	approximate	COORD	coordinate	FE	fire extinguisher	HT	height or heavy timber	MPH	mop holder	PROJ	projection	SLR	sealer	TWP	tackable wall panel		
ARCH	architect(ural)	CVR	cover	FEC	fire extinguisher cabinet	HTG	heating	MPS	manual pull station	PRVD	provided 	SMK CUR	smoke curtain	TYP	typical	YD	yard
ASSIST	assisted	CVR PL	cover plate	FF	finish floor	HTR	heater	MR	mirror	PSC	projection screen	SN	signage, ref	12	terrazzo		
AUTO	automatic		d.a.	FIN	finish(ed)	HVAC	heating, ventilating & air	MS	mop sink	PLIFT	projection lift	SND	sanitary napkin disposal	TZB	terrazzo base		
AWP	acoustical wall panel	D	data	FLG	flange		conditioning	MTD	mounted	PSI	pounds per cubic inch	SNV	sanitary napkin vendor	LINIFINI	finials and		
AV	audio visual	DBL	double	FLASH	flashing	ICOL	integral color	MTL MWP	metal	PTD	paper towel dispenser	SOG	slab on grade	UNFIN	unfinished		
AVC	audio visual cabinet	DET DF	detail drinking fountain	FLR FLUOR	floor fluorescent	ICOL	integral color inside diameter/dimension	IVIVVP	metal wall panel	PTN	partition	SPEC SPK	specification speaker outlet	UNI UNO	unisex unless noted otherwise		
		DIA	diameter	FLOOR	floor mat	ID IN	inch	(N)	now	ОТ	guarry tila	SPKR	speaker	UR	urinal		
P.C	bottom of curb	DIM	dimension	FOC	face of concrete	INCL	include(d)	(IV)	new	QTR	quarry tile	SPNK	sprinkler	UK	urmar		
BCD	barrel clearing device	DIM PT	dimension point	FOF	face of contrete	INFO	information	NΔ	north not applicable	QIK	quarter	SO	square	V	voltage		
BCS	baby changing station	DISP	disposal	FOM	face of masonry	INSUL	insulation	NIC	not in contract	D	riser	SS	stainless steel	V VB	voltage vapor barrier		
BC3	board	DN	down	FOS	face of masonity	INT	interior	NO.	number	RΔ	return air	SST	stainless steel trim	VEG	vegetated		
BFF	below finish floor	DO	data outlet	FR	flush frame with reveal	INV	invert	NOM	nominal	RAD	radius	ST	street	VENT	ventilation		
BLDG	building	DO	delayed egress operator	FPRF	fireproofing	IRGBD	impact-resistant gypsum board	NTS	not to scale	RAG	return air grill	STC	sound transmission class	VERT	vertical		
BLK	block	DOS	door operation sensor	FRAP	firefighter's remote annunciation pnl.	III ODD	impact resistant gypsam board	1415	not to scale	RB	rubber base	STC	acoustical door, see door sched	VEST	vestibule		
BLKG	blocking	DR	door	FRP	fiberglass reinforced panel	JB	junction box	OA	outside air	RCP	reflected ceiling plan	STD	standard	VIF	verify in field		
BM	beam or bench mark	DRN	drain	FRT	fire retardant treated	JST	joist	OC	on center	RD	roof drain	STL	steel	VNR	veneer		
BOD	bottom of deck	DS	downspout	FS	fire sprinkler or floor sink	JT	joint	OD	outside diameter/dimension	REC	recessed	STLB	steel base	VP	veneer plaster		
BOR	bottom of reveal	DT	data/telecommunication	FSA	fire alarm system annunciator	JC	janitors closet	ODS	overflow downspout	RECEPT	receptacle	STN	stain	VPB	Vehicle Processing Building		
вот	bottom	DWG	drawing	FSH	folding shelf		•	OFCI	owner furnished-contractor installed	REF	reference	STOR	storage				
BRG	bearing		Ü	FSN	fasten (mechanically)	КО	knockout	OFOI	owner furnished-owner installed	REINF	reinforced	STR	structural				
BRK	brick	(E)	existing	FSS	folding shower seat	KP	kick plate	ОН	opposite hand	REQD	required	STRUC	underside of structure above				
BSMT	basement	Ē	east	FT	foot or feet	KYPD	keypad	OPNG	opening	RESIL	resilient	SURF	surface				
		EA	each	FTG	footing			OPP	opposite	REV	revision	SUSP	suspended/suspension				
CA	camera	EAN	elevator annunciator	FTR	finned tube radiator, ref mech	L	length	OPT	optional	RF	roof	SV	sheet vinyl				
САВ	cabinetry	EB	expansion bolt	FURN	furniture - not in contract	LAM	laminate	ORIG	original	RFG	roofing	SVC	sound, video, communication				
СВ	ceramic base	ECS	elevator call station			LAND	landscape	OVHD	overhead	RFL	reflected	SYM	symmetrical				
CTCH BSN	catch basin	EDO	electrical and data outlet			LDG	landing	OPER	operable	RFLR	raised floor system	SYS	system				
CKBD	chalkboard	EF	existing finish			LAV	lavatory	OPP HD	opposite hand	RH	robe hook						
CEM	cement	EJ	expansion joint			LB	pound or lag bolt			RM	room						

SYMBOLS


GENERAL - LEGEND




elevation electrical

corner guard coat hook

ENLARGED BUILDING ■ SHEET NUMBER WALL SECTION

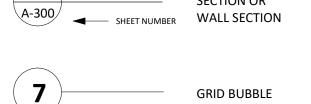

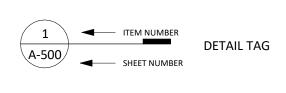


1 KEY NOTE **ELEVATION** 22

FLOOR PLANS - LEGEND

X":FT SLOPE

X":FT \
SLOPE

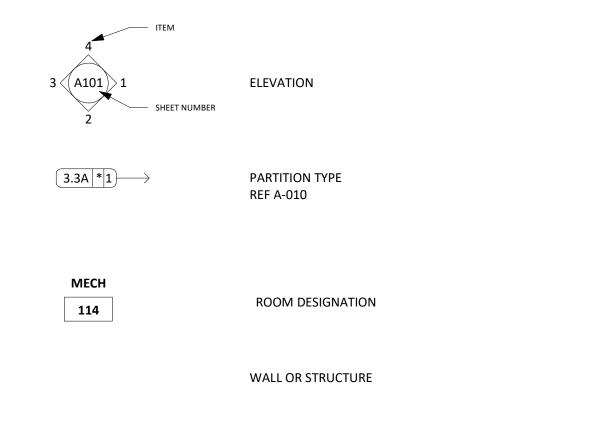

FLOOR DRAIN, REF PLUMBING

CRICKET SLOPE

STRUCTURAL SLOPE

REVISIONS

FIXTURES HVAC SUPPLY & RETURN ACCESS PANEL SPEAKER, REF TECHNOLOGY Р PROJECTOR MOUNT, REF TECHNOLOGY ES EXIT SIGN, REF ELEC CAMERA, REF SECURITY **RATED ASSEMBLIES** 1 HOUR FIRE RATED SEPARATION 2 HOUR FIRE RATED SEPARATION MAX PATH OF EGRESS (MAXIMUM DISTANCE INDICATED)

ELEVATIONS AND SECTIONS - LEGEND

CEILING PLAN - LEGEND

TAGS

MATERIALS

C1G1

1'-0"

OTS

EXTERIOR FRAME TYPE

INTERIOR FRAME TYPE

OPEN TO STRUCTURE

DECKING. REF STR

(ACT-1, UNO)

MTL PNL SYS 1

GYPSUM BOARD SYS 1

MAX COMMON PATH OF TRAVEL

(MAXIMUM DISTANCE INDICATED)

ACOUSTICAL CEILING TILE

DETAIL KEY


GLASS TYPE, REF FRAME TYPE DRAWINGS


CEILING HEIGHT ABOVE FINISH FLOOR

PAINTED EXPOSED STRUCTURE AND METAL

MATERIALS DETAILS - LEGEND


CONCRETE
GBD
INSUL 1A
EARTH

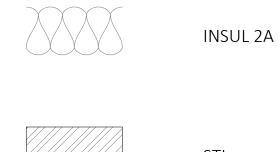

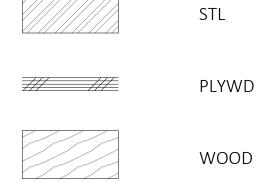


DIMENSIONING


- 1. IN MANY OF THE INTERIOR SPACES THE ACTUAL DIMENSIONS MAY BE LESS IMPORTANT THAN IF THE TWO ELEMENTS IN THE BUILDING WERE TO BE EQUAL. IN THESE CASES, THE WORD "EQ" IS USED IN LIEU OF THE ACTUAL
- 2. WHEN A ROOM CENTERLINE IS INDICATED ONLY ONE SIDE OF THE ROOMS ELEMENTS MAY BE DIMENSIONED.
- 3. COLUMN IDENTIFICATION: DETAILS WILL GOVERN ALL DIMENSIONS NOT SHOWN ON SMALL SCALE PLANS.

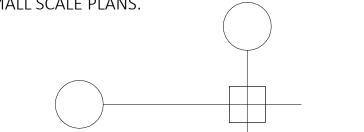


4. WALL (STUD) CENTERED ON COLUMN OR GRID LINES WILL NOT BE DIMENSIONED ON SMALL SCALE PLANS BUT WILL BE DRAWN ACCORDINGLY.

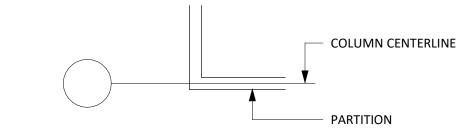

5. WALL WITH A FINISHED FACE FLUSH WITH FINISH FACE OF COLUMN WILL NOT BE DIMENSIONED ON SMALL SCALE PLANS BUT WILL BE DRAWN ACCORDINGLY.

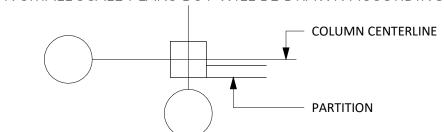

6. WALL FINISH FACE ON COLUMN OR GRID LINE WILL NOT BE DIMENSIONED ON SMALL SCALE PLANS BUT WILL BE DRAWN ACCORDINGLY.

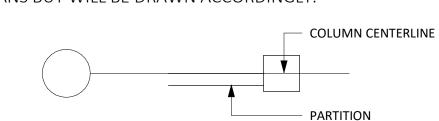


7. OPENINGS OCCURRING IN WALLS.

- A. WHEN A JAMB OCCURS AT A COLUMN OR GRID LINE, DIMENSIONS WILL NOT BE SHOWN ON THE SMALL SCALE PLANS. THE OPENING WIDTH WILL BE GOVERNED BY THE DOOR SCHEDULE.
- B. WHEN A JAMB OCCURS AT NEITHER A COLUMN LINE NOR A GRID LINE AND DOES NOT FOLLOW TYPICAL OFFSETS, THEN THE JAMB WILL BE DIMENSIONED.

8. DOOR LOCATION.

DOORS ARE LOCATED BY ONE OF THE FOLLOWING:

A. ONE JAMB FACE LOCATED BY A WALL AT RIGHT ANGLE. TYPICAL UNLESS INDICATED IN PLAN.

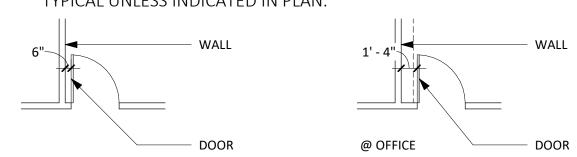

B. AS DIMENSIONED.

9. CONCRETE AND MASONRY WALLS ARE DIMENSIONED TO FACE OF BRICK VENEER OR FACE OF CONCRETE UNLESS NOTED OTHERWISE.

10. DIMENSIONS ARE INDICATED IN THE DOCUMENTS. THE DRAWINGS SHALL NOT BE SCALED FOR DIMENSIONS.

HACKER

733 SW Oak, Portland, OR 97205

QA

639 FRONT ST, SAN FRANCISCO, CA 94111

Mayor ED 17-02 Priority permit

REVISION NO.

NOT FOR CONSTRUCTION

DATE

KEY PLAN - (NTS)

TRUE PLAN NORTH

PIER 70


Brookfield Properties

BROOKFIELD PROPERTIES PIER 70 PARCEL A

ISSUANCE DESIGN REVIEW PACKAGE PROJECT NUMBER 1830

JULY 12, 2019 SCALE As indicated

DRAWING TITLE ARCHITECTURAL SYMBOLS AND ABBREVIATIONS

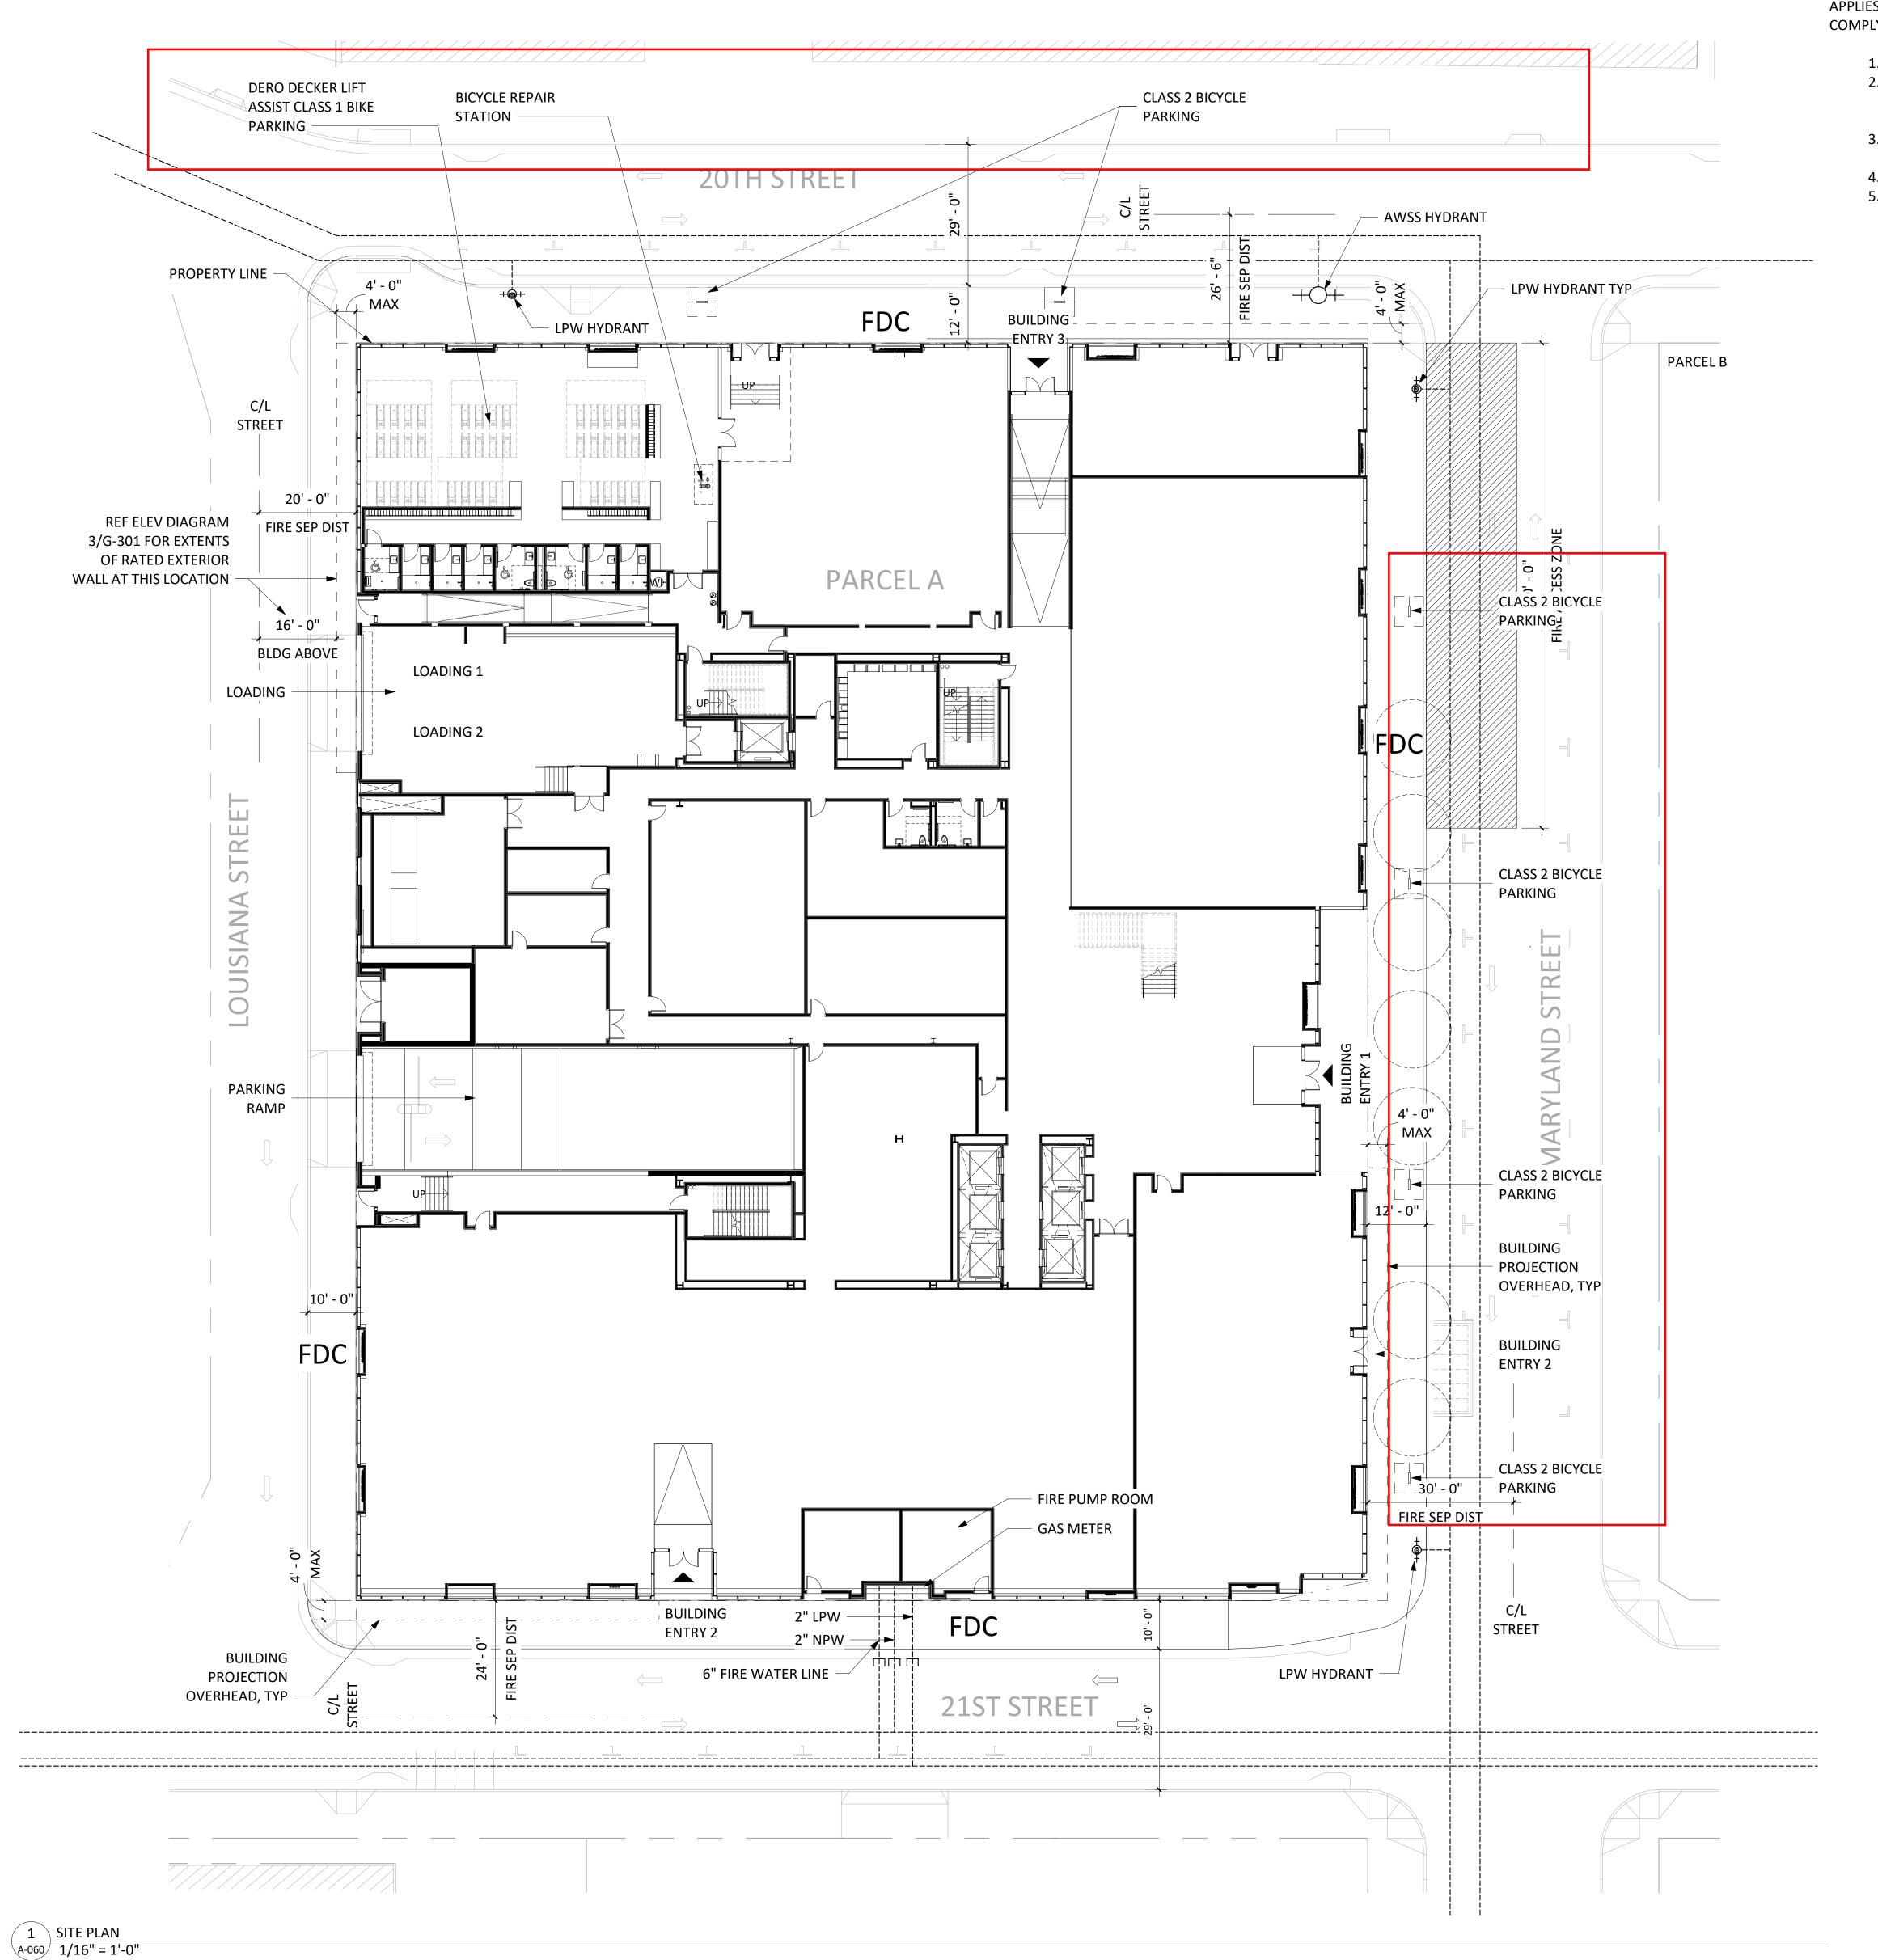

PORT OF SAN FRANCISCO

PIER 70 RISK MANAGEMENT PLAN (RMP)

THE PORT OF SAN FRANCISCO PIER 70 RISK MANAGEMENT PLAN (RMP) APPLIES TO THIS PROJECT SITE. IT IS THE CONTRACTOR'S RESPONSIBILITY TO COMPLY THIS PLAN, INCLUDING THE FOLLOWING AS APPLICABLE:

- 1. CITY AND COUNTY OF SAN FRANCISCO HEALTH CODE ARTICLE 22A 2. ENVIRONMENTAL HEALTH AND SAFETY PLAN (EHSP), IF APPLICABLE,
- OR STATE REQUIREMENT OF SITE-SPECIFIC EHSP PREPARED BY A CERTIFIED INDUSTRIAL HYGIENIST
- 3. DUST CONTROL PLAN FOR PIER 70 MASTER PLAN AREA, IF APPLICABLE
- 5. SOIL IMPORT PLAN, IF APPLICABLE
- 4. ASBESTOS DUST MITIGATION PLAN (ADMP), IF APPLICABLE

733 SW Oak, Portland, OR 97205

HACKER

QA

ARCHITECTS

639 FRONT ST, SAN FRANCISCO, CA 94111 CONSULTANT

Mayor ED 17-02 Priority permit

SITE PERMIT

THIS APPLICATION SUBMITTED FOR BE STARTED UNTIL CONSTRUCTION PLANS HAVE BEEN APPROVED.



DATE

REVISION NO.

KEY PLAN - (NTS)

TRUE PLAN NORTH

PIER 70

Brookfield Properties


BROOKFIELD PROPERTIES PIER 70 PARCEL A

ISSUANCE SITE PERMIT PROJECT NUMBER 1830

SEPTEMBER 04, 2019

As indicated DRAWING TITLE

SITE PLAN

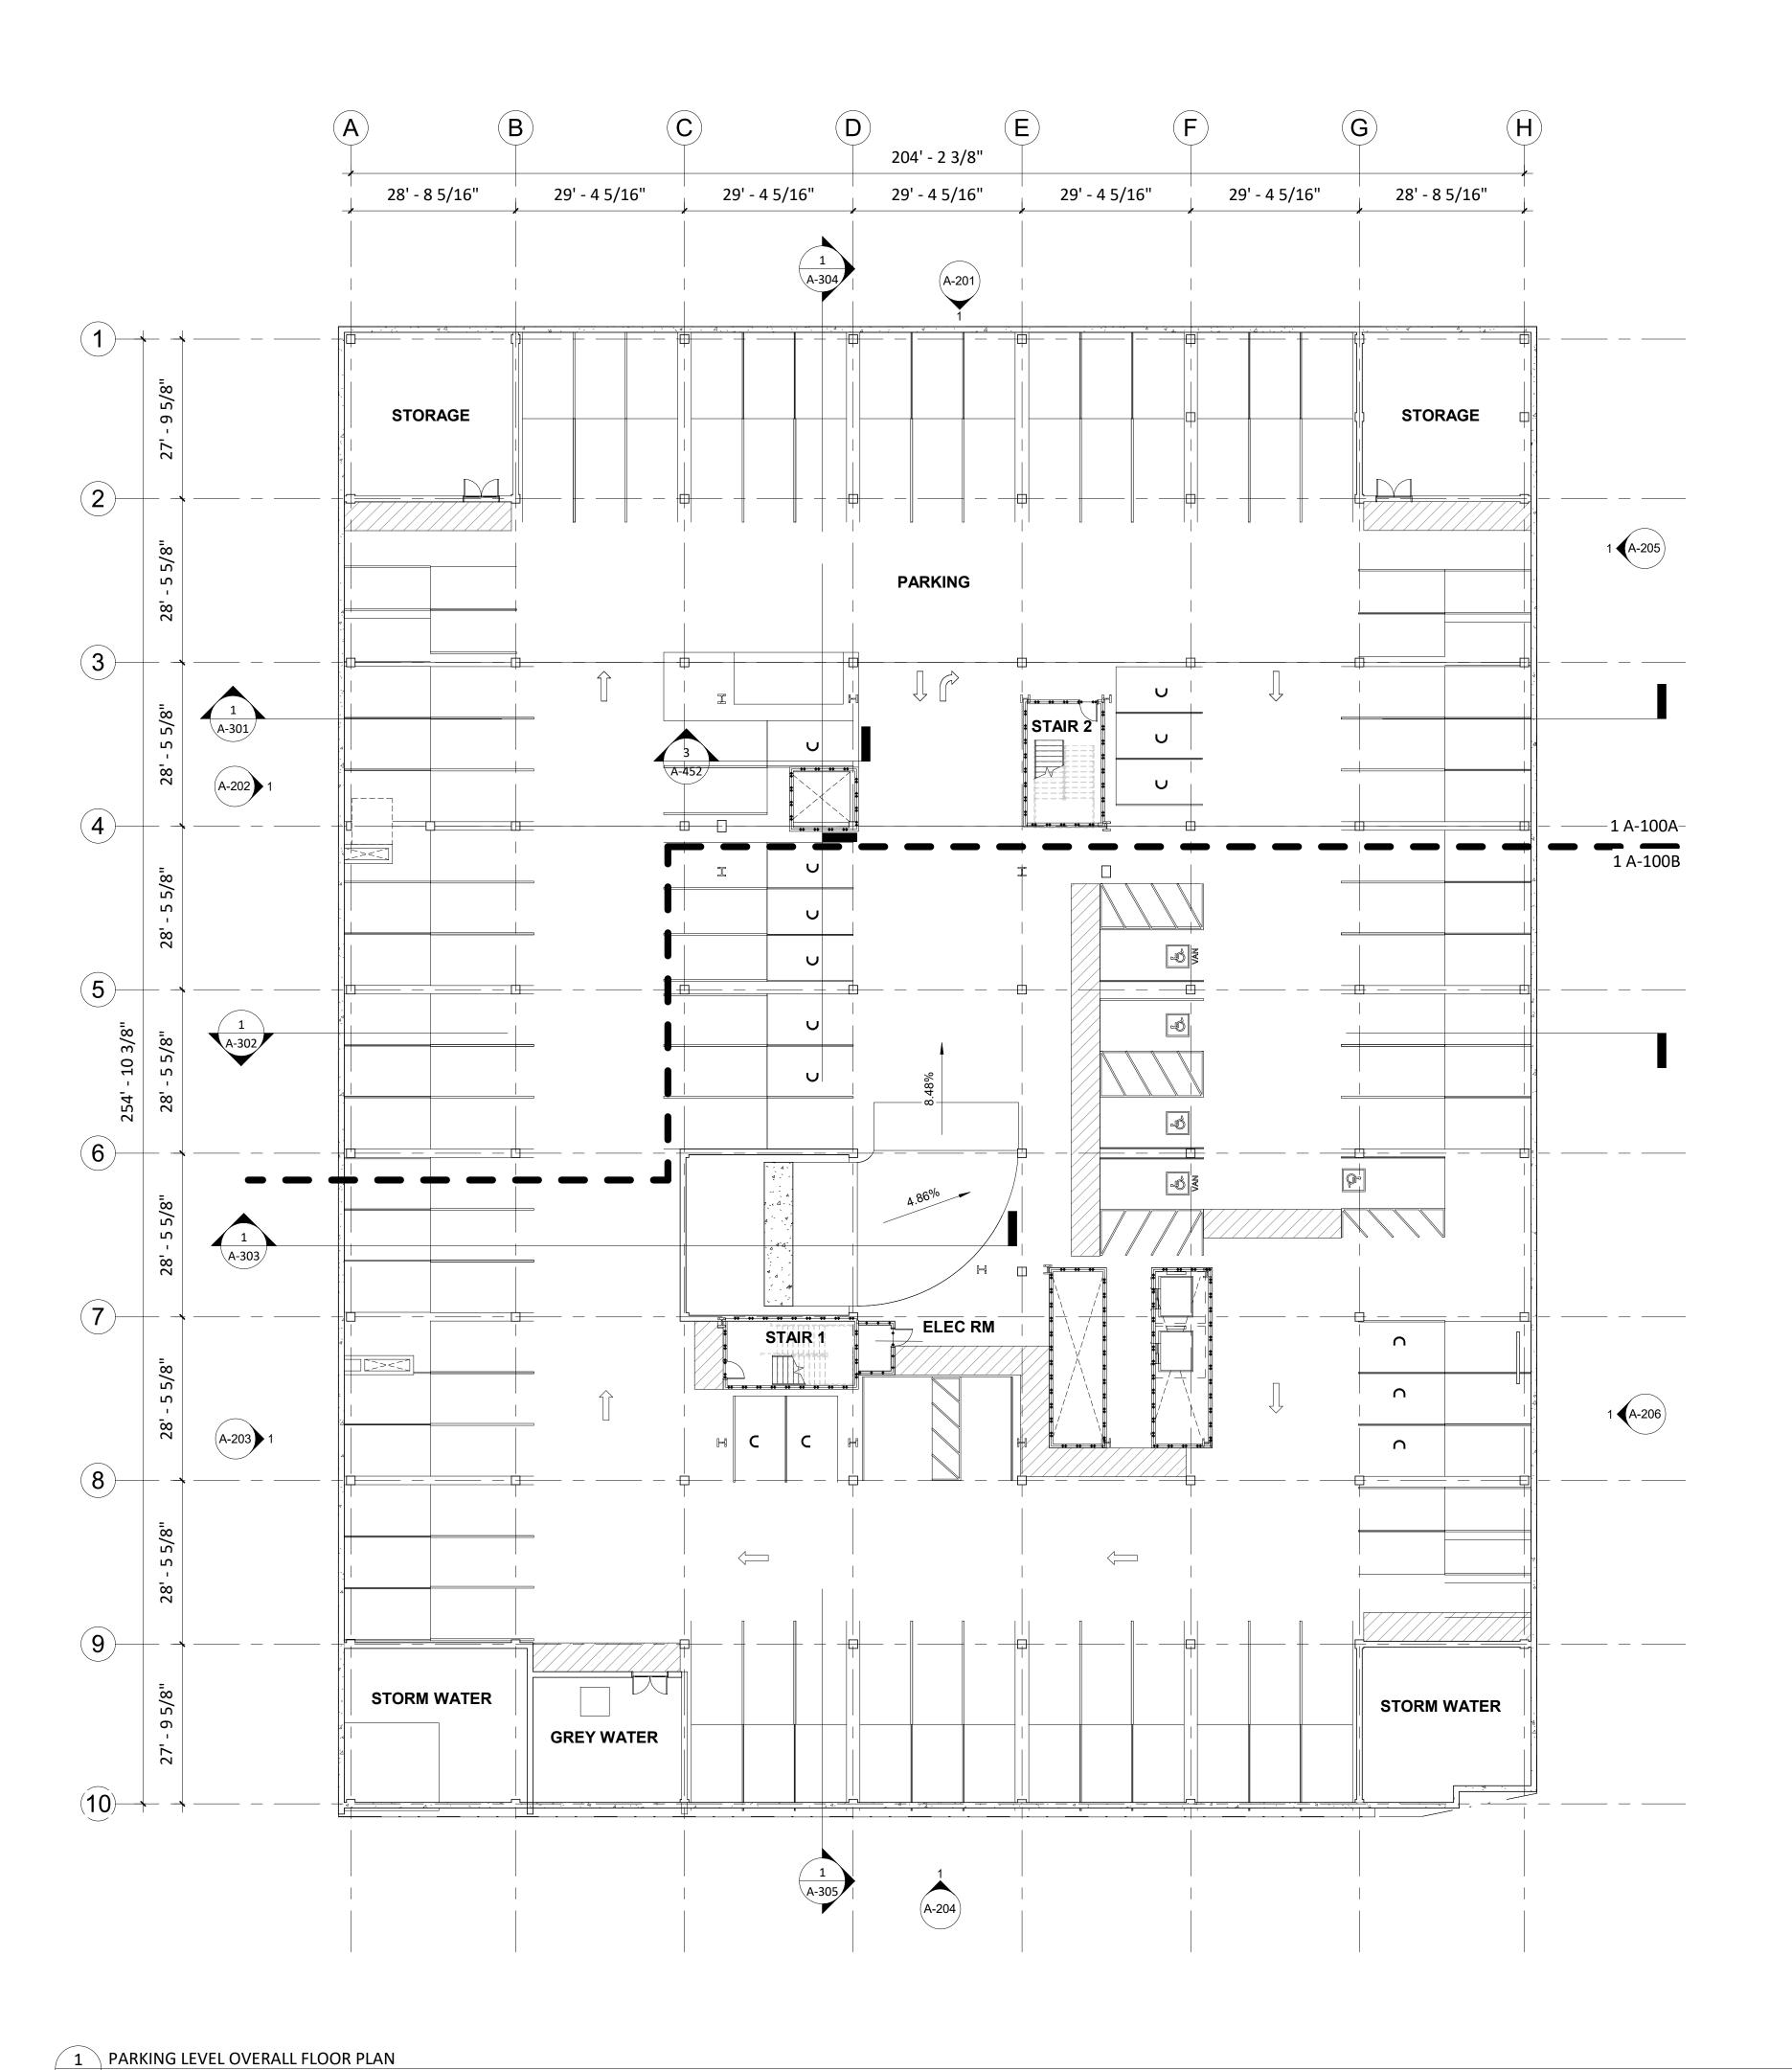

A-100 1/16" = 1'-0"

GENERAL NOTES - PLAN

- A. REFERENCE CIVIL DRAWINGS FOR GRADING AND HORIZONTAL CONTROL DRAWINGS.
- B. REF LANDSCAPE DRAWINGS FOR ALL SITE MATERIALS, LAYOUT, AND ACCESS COMPLIANCE SITE/PATH OF TRAVEL DRAWINGS.
- C. REFERENCE A-001 FOR ABBREVIATIONS, SYMBOLS AND GENERAL DIMENSIONING NOTES.
- D. REF A-010 SERIES DRAWINGS FOR ALL WALL TYPE DETAILS AND FIRE-RATED ASSEMBLIES. IF WALL TYPE IS NOT NOTED IN THE PLAN THEN THE WALL TYPE SHALL BE
- E. REF A-017 SERIES DRAWINGS FOR TYPICAL METAL STUD FRAMING DETAILS AND GUIDELINES.
- F. REF G-100 SERIES DRAWINGS FOR CODE SUMMARIES AND EXTENT OF FIRE-RATED CONSTRUCTION.
- G. REF A-600 DRAWINGS FOR EXTERIOR FRAME TYPES.
- H. REF A-620 DRAWINGS FOR INTERIOR FRAME TYPES.

	Parking Schedule	
Family	Туре	Count
Parking Space - ADA	9' x 18' (5' Aisle)	1
9' x 18' (5' Aisle): 1		1
Parking Space - ADA	9' x 18' (8' Aisle)	3
9' x 18' (8' Aisle): 3		3
Tandum Parking Stall	Compact 7'6" x 15' (without symbol0	7
Compact 7'6" x 15' (without symbol0: 7		7
Tandum Parking Stall	Compact 8' x 15'	7
Compact 8' x 15': 7		7
Tandum Parking Stall	Compact 9' x 15'	7
Compact 9' x 15': 7		7
Parking Space - ADA	EV-A 9' x 18' (5' Aisle)	1
EV-A 9' x 18' (5' Aisle): 1		1
HA_32_ Parking Stall	EV-VA 12' x 18'	1
EV-VA 12' x 18': 1		1
Parking Space	Full 8' x 18'	5
Full 8' x 18': 5		5
Parking Space	Full 9' x 18'	59
Full 9' x 18': 59		59
Tandum Parking Stall	Tandum 9' x 15' without symbol	62
Tandum 9' x 15' without sy	mbol: 62	62
Grand total		153

SHEET NOTES:

SEE G-002 FOR PARKING REQUIREMENTS

PER D4D TABLE 5.4.1, MAXIMUM PARKING PERMITTED:

A. OFFICE - 1 SPACE PER 1,500 SF OF GROSS FLOOR AREA
(242,300 GSF/1,500 SF = 162 MAXIMUM SPACES ALLOWED)

ARCHITECTS

HACKER

733 SW Oak, Portland, OR 97205

QA

639 FRONT ST, SAN FRANCISCO, CA 94111

CONSULTANT

Mayor ED 17-02 Priority permit

SITE PERMIT


THIS APPLICATION SUBMITTED FOR SITE PERMIT ONLY. NO WORK MAY BE STARTED UNTIL CONSTRUCTION PLANS HAVE BEEN APPROVED.



DATE

REVISION NO.

KEY PLAN - (NTS)

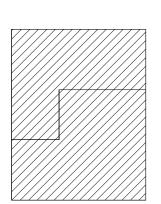

TRUE PLAN NORTH PIER 70

Brookfield Properties

BROOKFIELD PROPERTIES PIER 70 PARCEL A

ISSUANCE SITE PERMIT


PROJECT NUMBER

DATE
SEPTEMBER 04, 2019

SCALE As indicated DRAWING TITLE

PARKING LEVEL OVERALL **FLOOR PLAN**

SHEET NUMBER

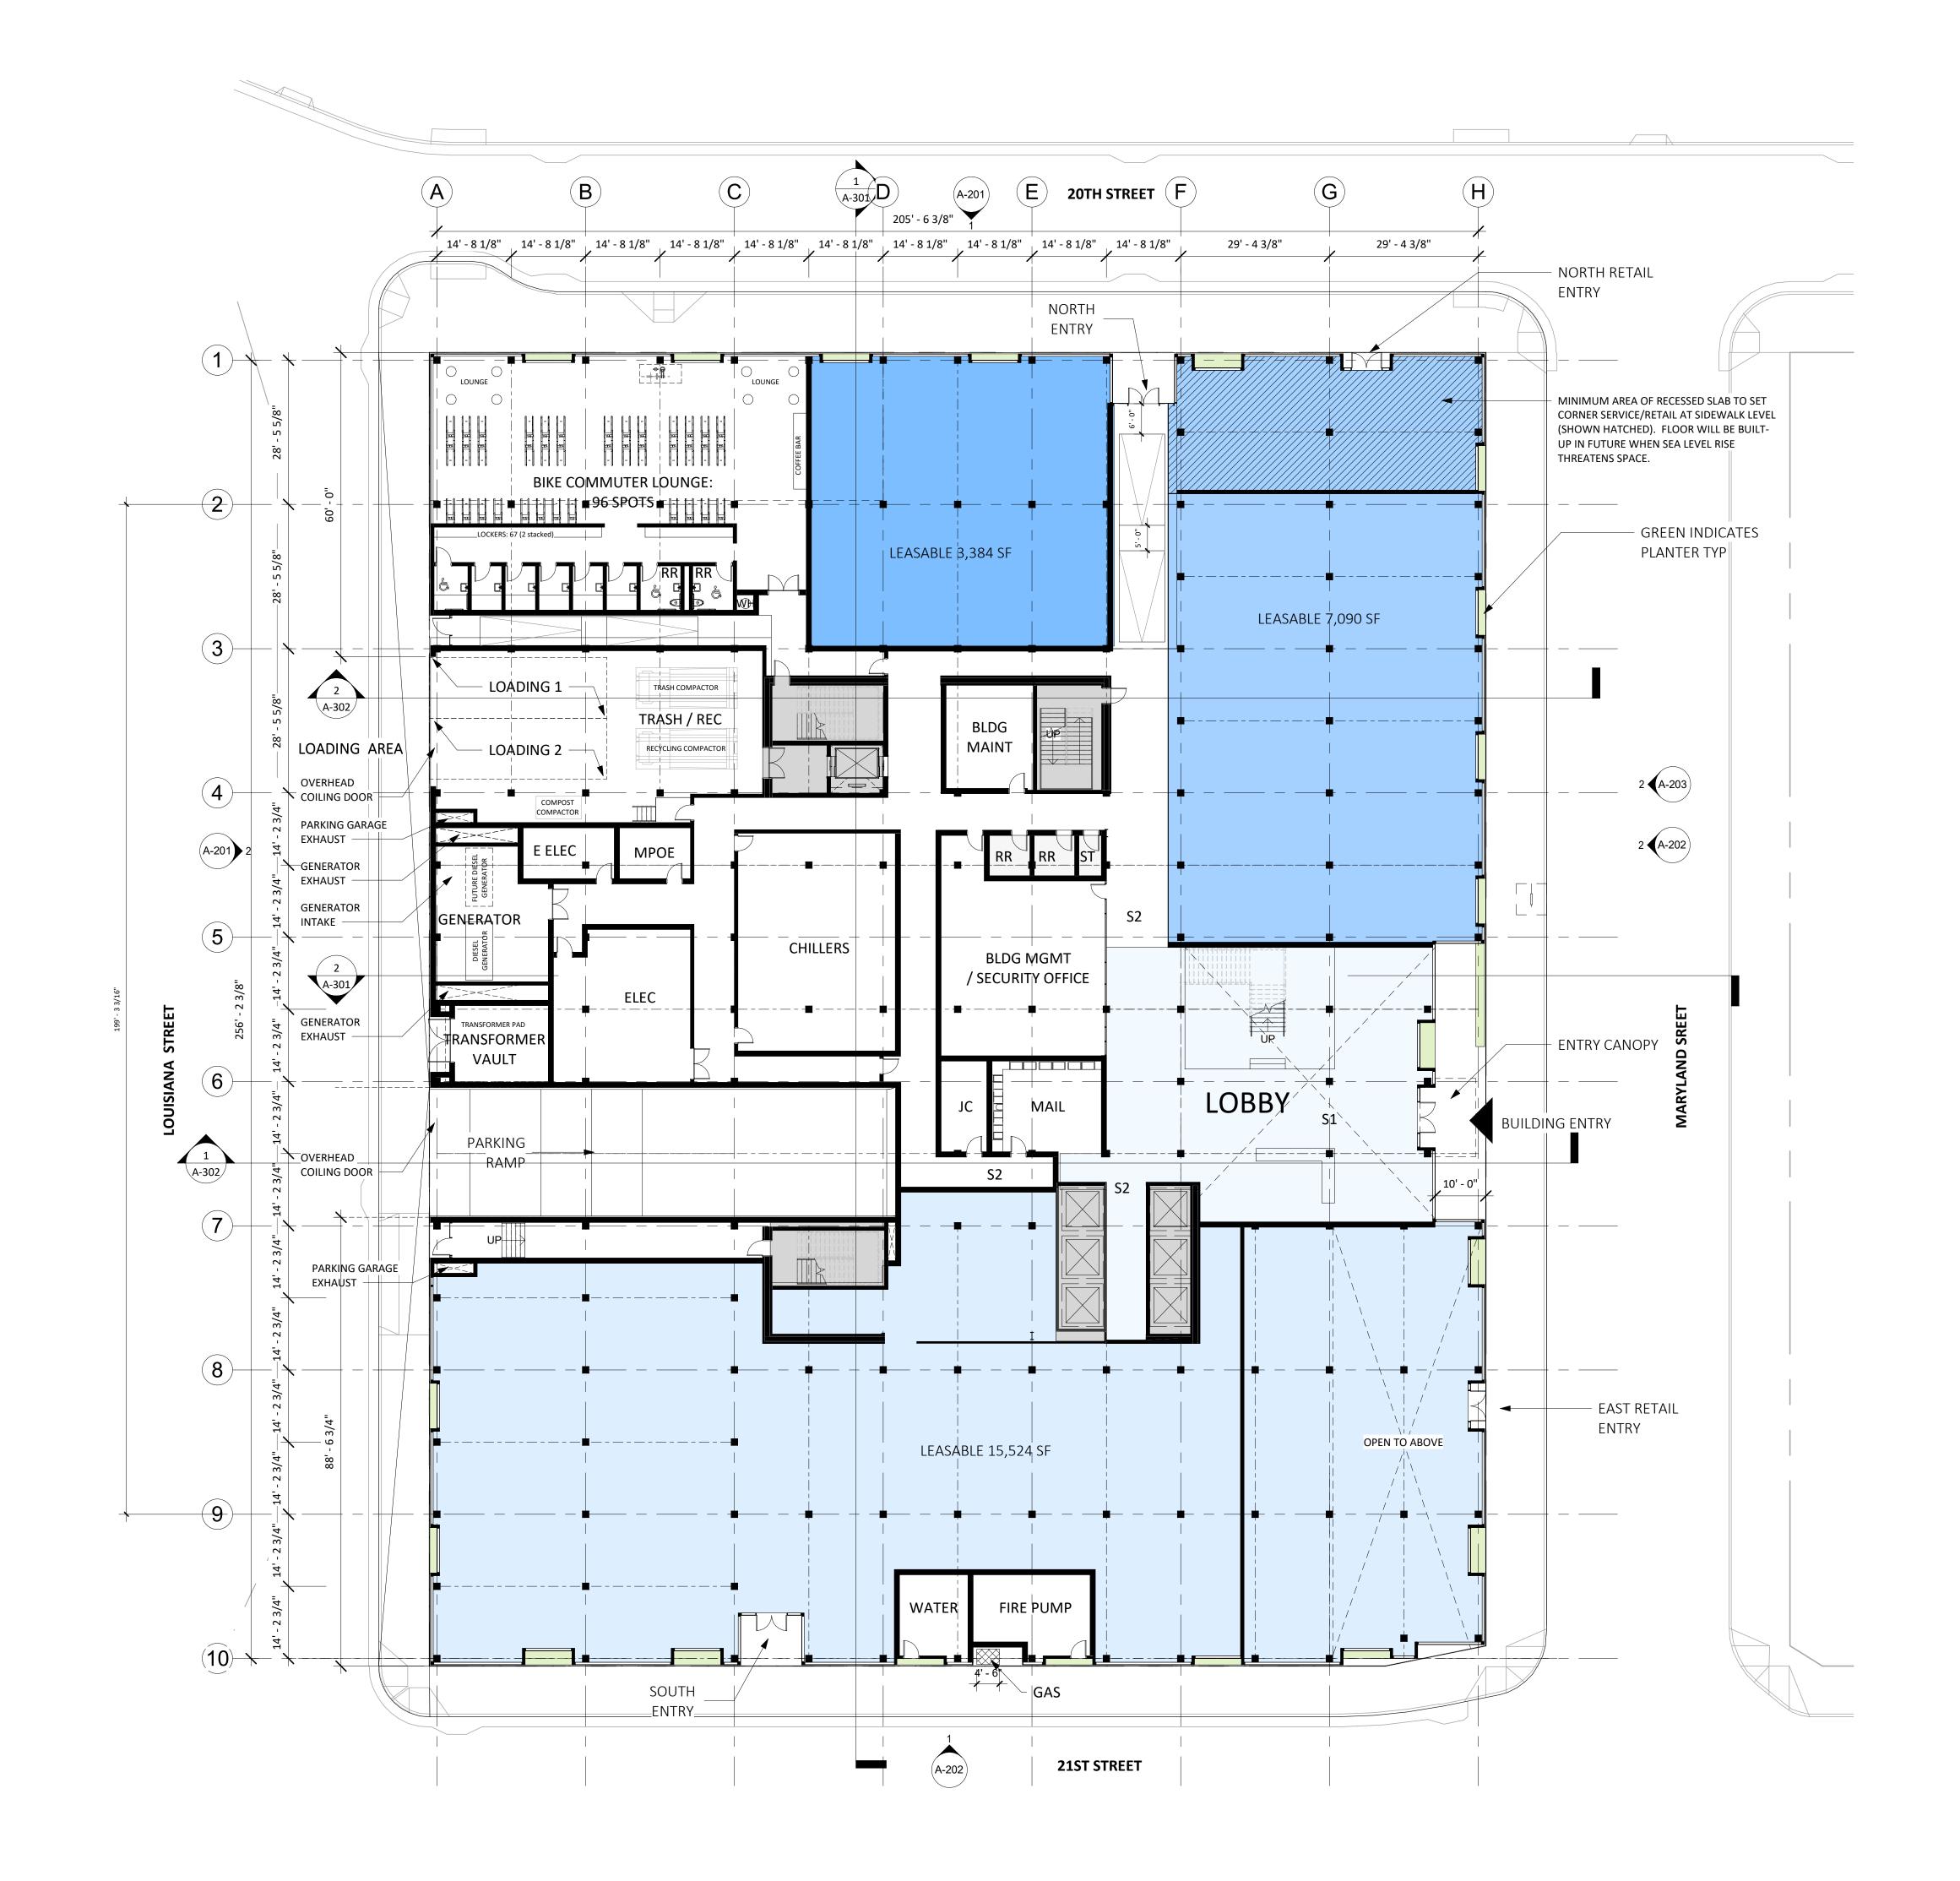

1 1ST FLOOR A-101 1/16" = 1'-0" ARCHITECTS

HACKER

733 SW Oak, Portland, OR 97205

QA

639 FRONT ST, SAN FRANCISCO, CA 94111

CONSULTANT

Mayor ED 17-02 Priority permit

STAMP

NOT FOR CONSTRUCTION

DATE

REVISION NO.

KEY PLAN - (NTS)

TRUE PLAN NORTH

PIER 70

BrookfieldProperties

BROOKFIELD PROPERTIES PIER 70 PARCEL A

DESIGN REVIEW PACKAGE
PROJECT NUMBER
1830

DATE JULY 12, 2019


ISSUANCE

SCALE
1/16" = 1'-0"

DRAWING TITLE

LEVEL 1 FLOOR PLAN

SHEET NUMBER

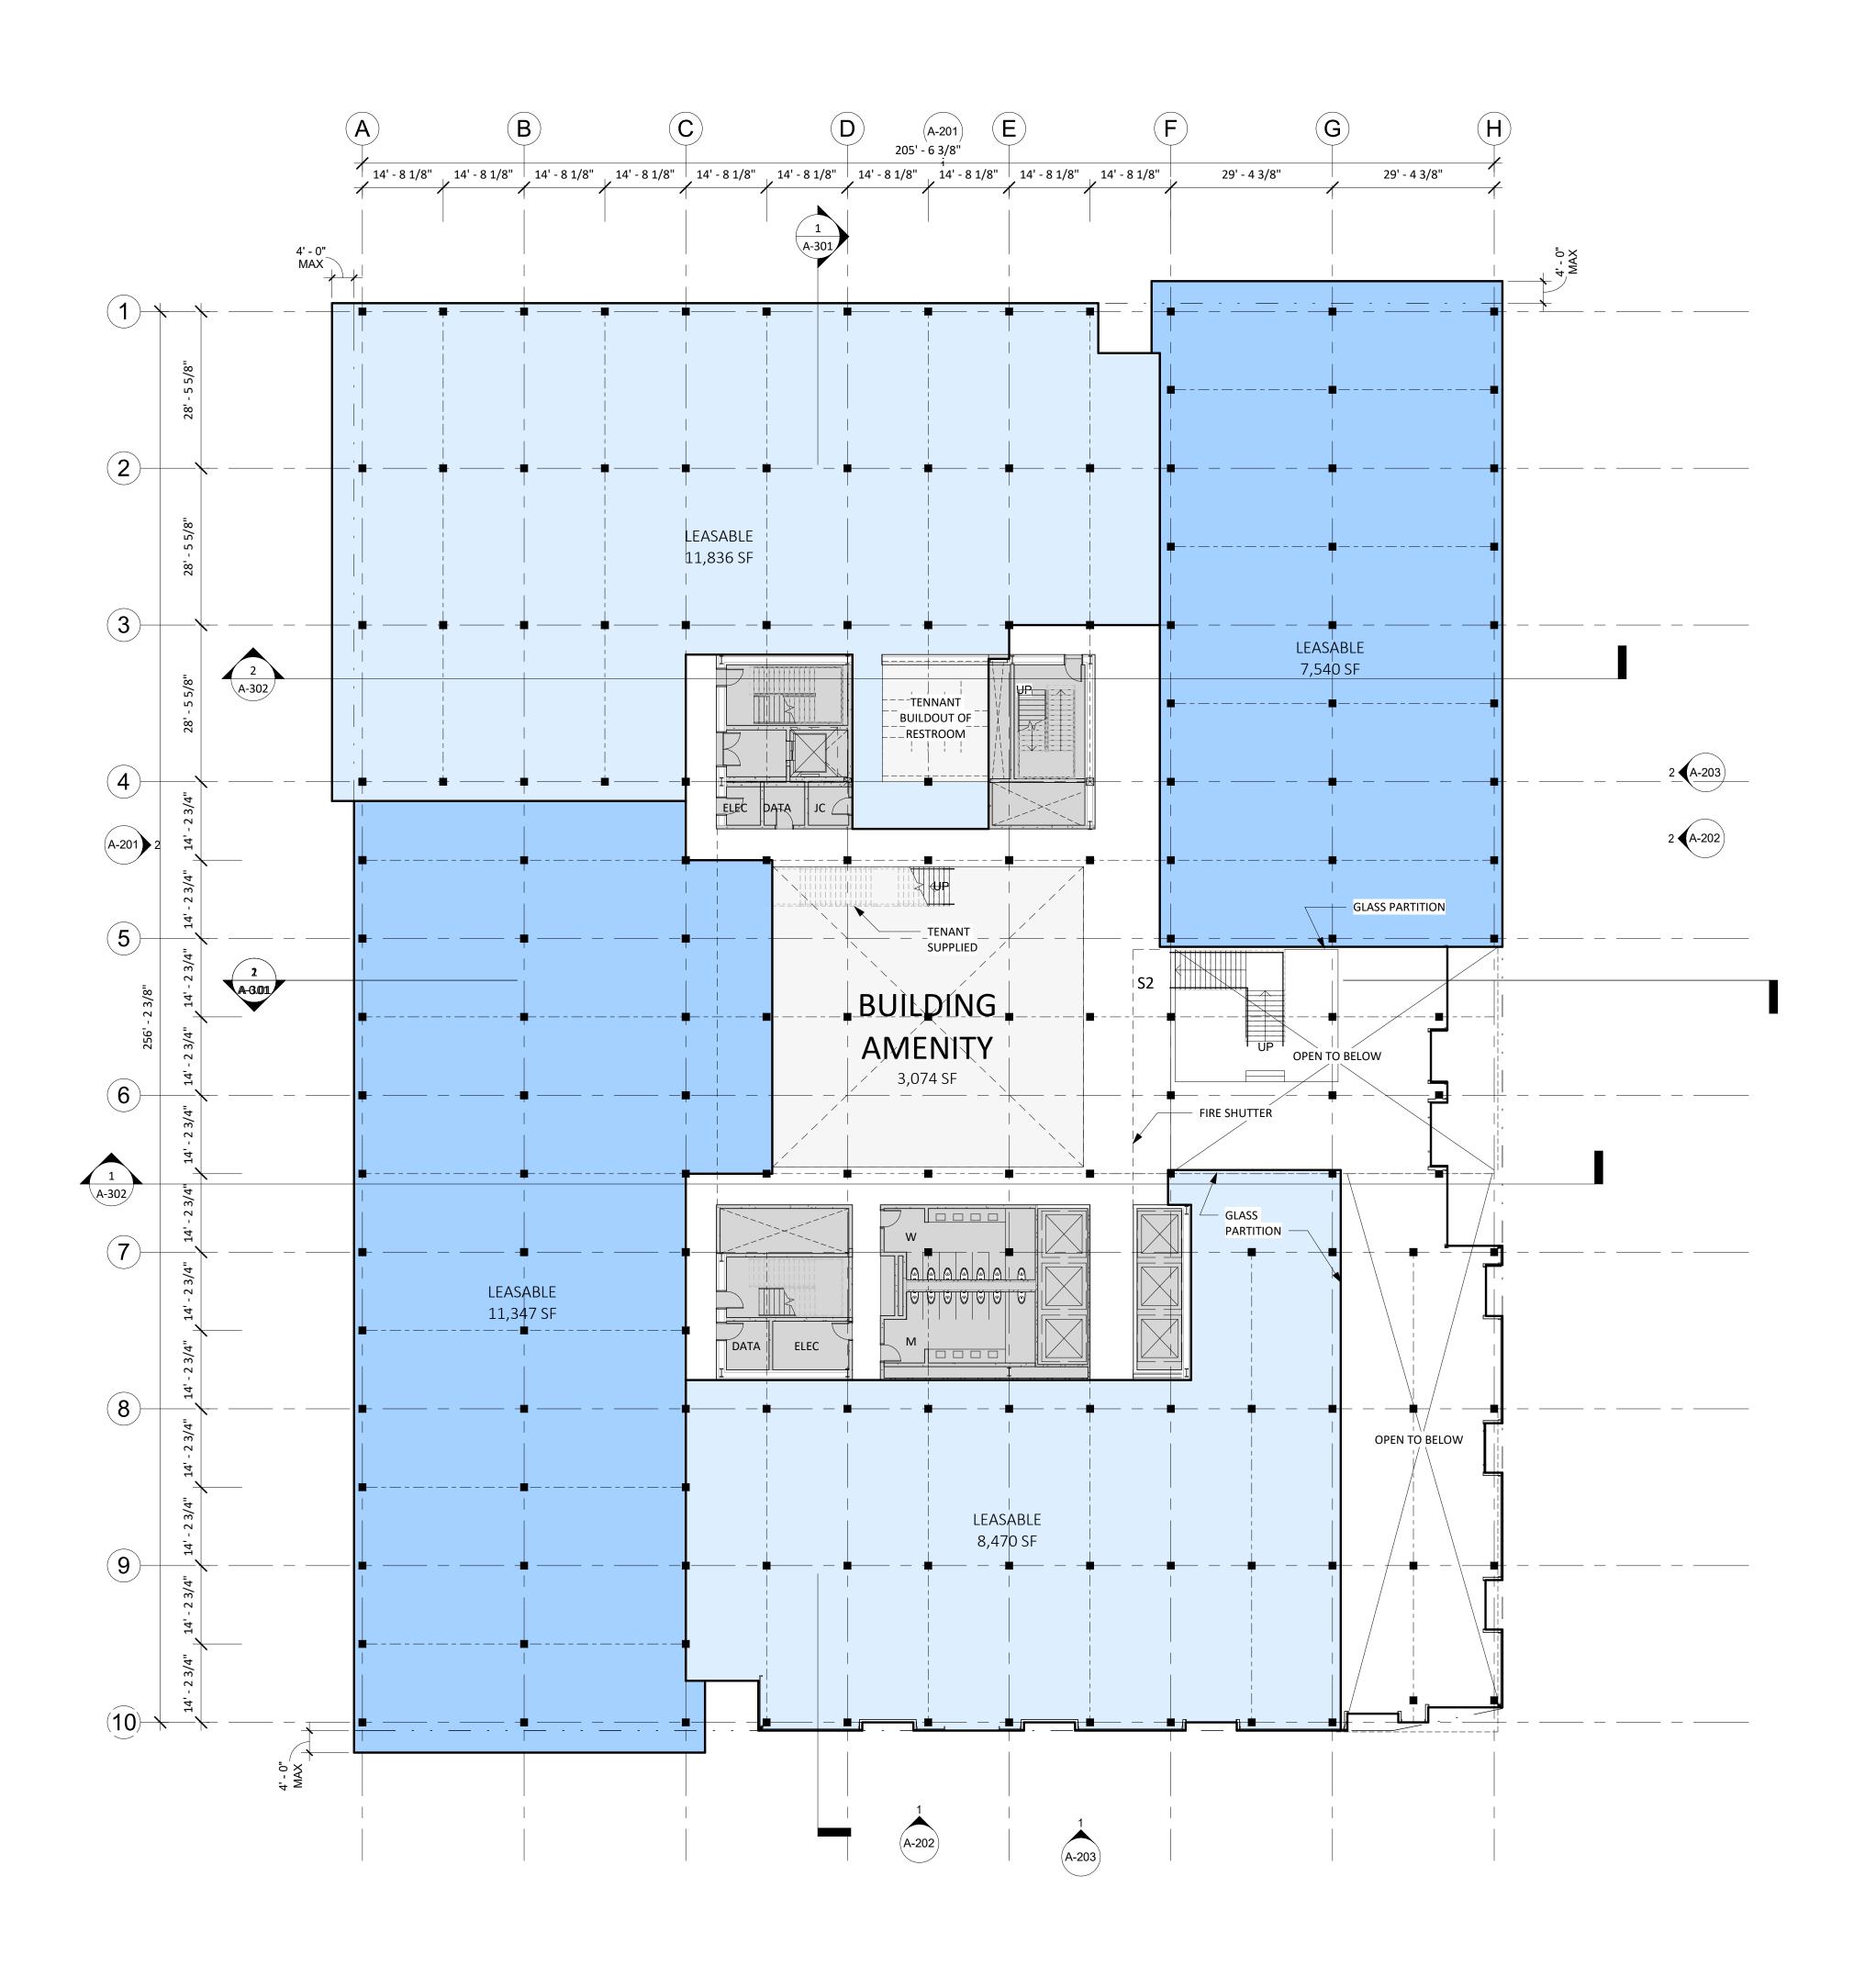

1 2ND FLOOR A-102 1/16" = 1'-0"

HACKER

733 SW Oak, Portland, OR 97205

QA

639 FRONT ST, SAN FRANCISCO, CA 94111

CONSULTANT

Mayor ED 17-02 Priority permit

NOT FOR CONSTRUCTION

DATE

REVISION NO.

KEY PLAN - (NTS)

TRUE PLAN NORTH

PIER 70

Brookfield Properties

BROOKFIELD PROPERTIES PIER 70 PARCEL A


ISSUANCE
DESIGN REVIEW PACKAGE PROJECT NUMBER 1830

DATE JULY 12, 2019 SCALE 1/16" = 1'-0"

DRAWING TITLE

LEVEL 2 FLOOR PLAN

SHEET NUMBER

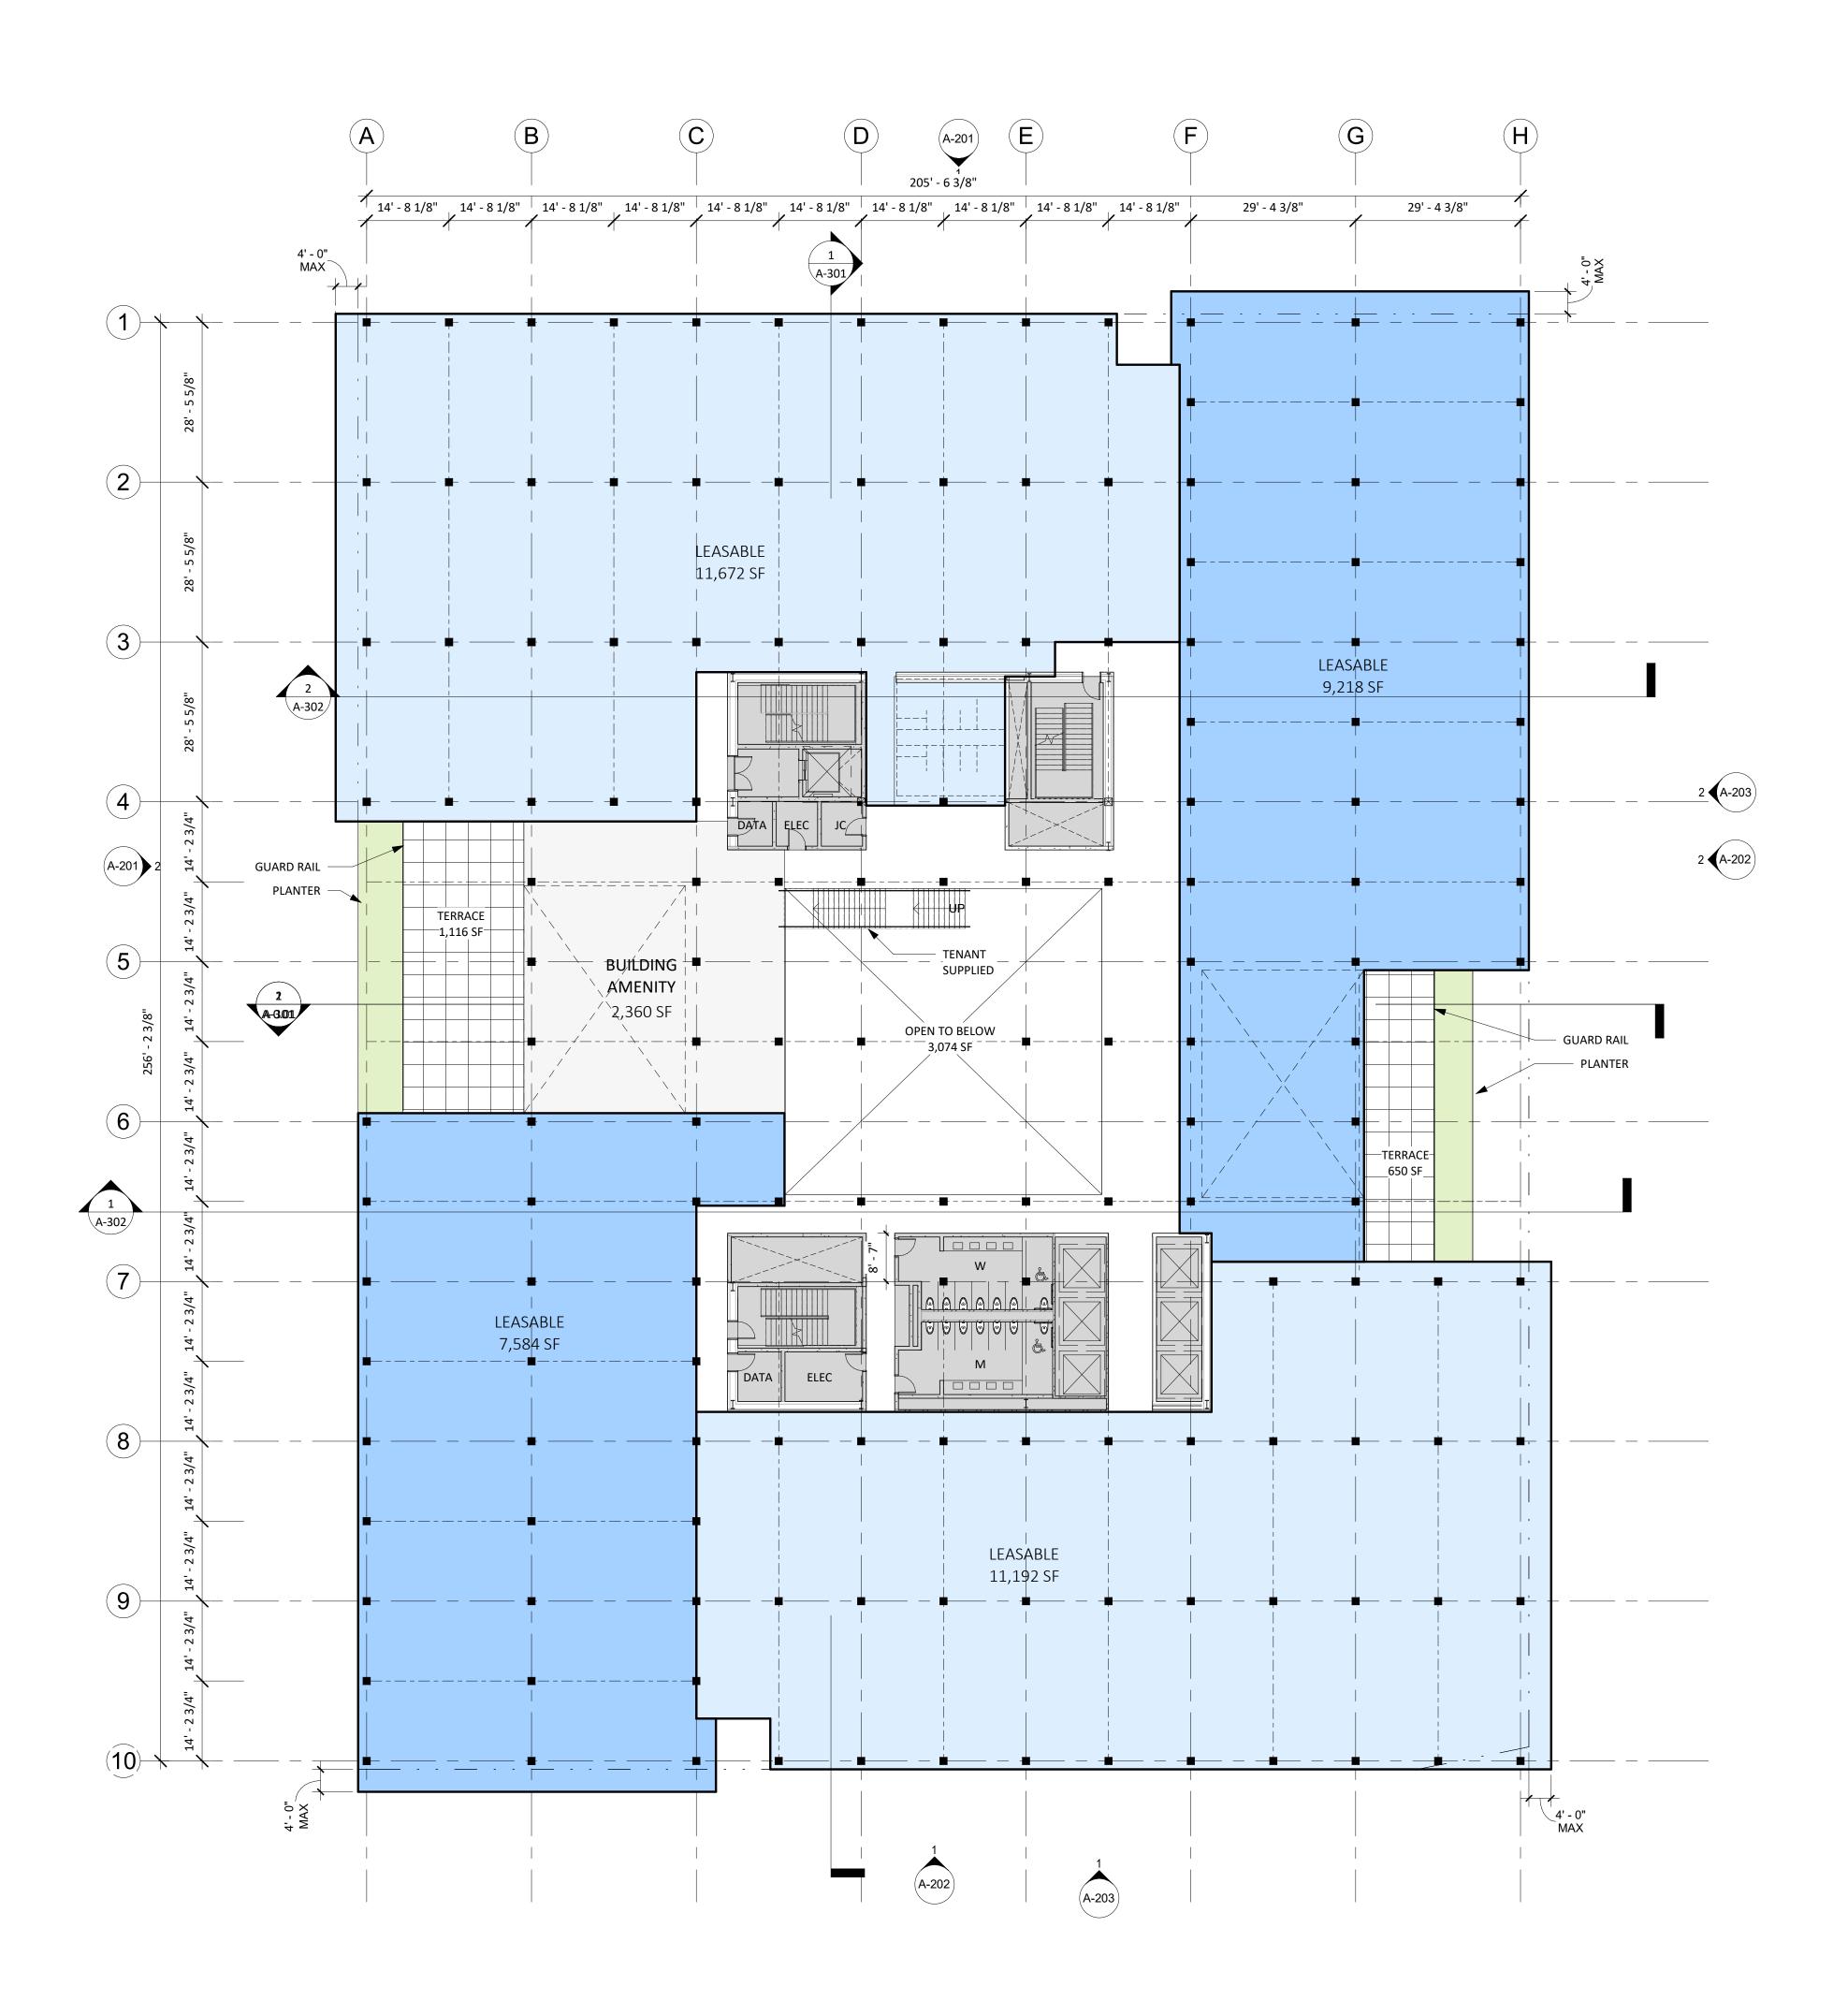

1 3RD FLOOR A-103 1/16" = 1'-0"

HACKER

733 SW Oak, Portland, OR 97205

QA

639 FRONT ST, SAN FRANCISCO, CA 94111

CONSULTANT

Mayor ED 17-02 Priority permit

NOT FOR CONSTRUCTION

DATE

REVISION NO.

KEY PLAN - (NTS)

TRUE PLAN NORTH

PIER 70

Brookfield Properties

BROOKFIELD PROPERTIES PIER 70 PARCEL A

ISSUANCE
DESIGN REVIEW PACKAGE


PROJECT NUMBER 1830

DATE JULY 12, 2019

SCALE 1/16" = 1'-0"

DRAWING TITLE LEVEL 3 FLOOR PLAN

SHEET NUMBER

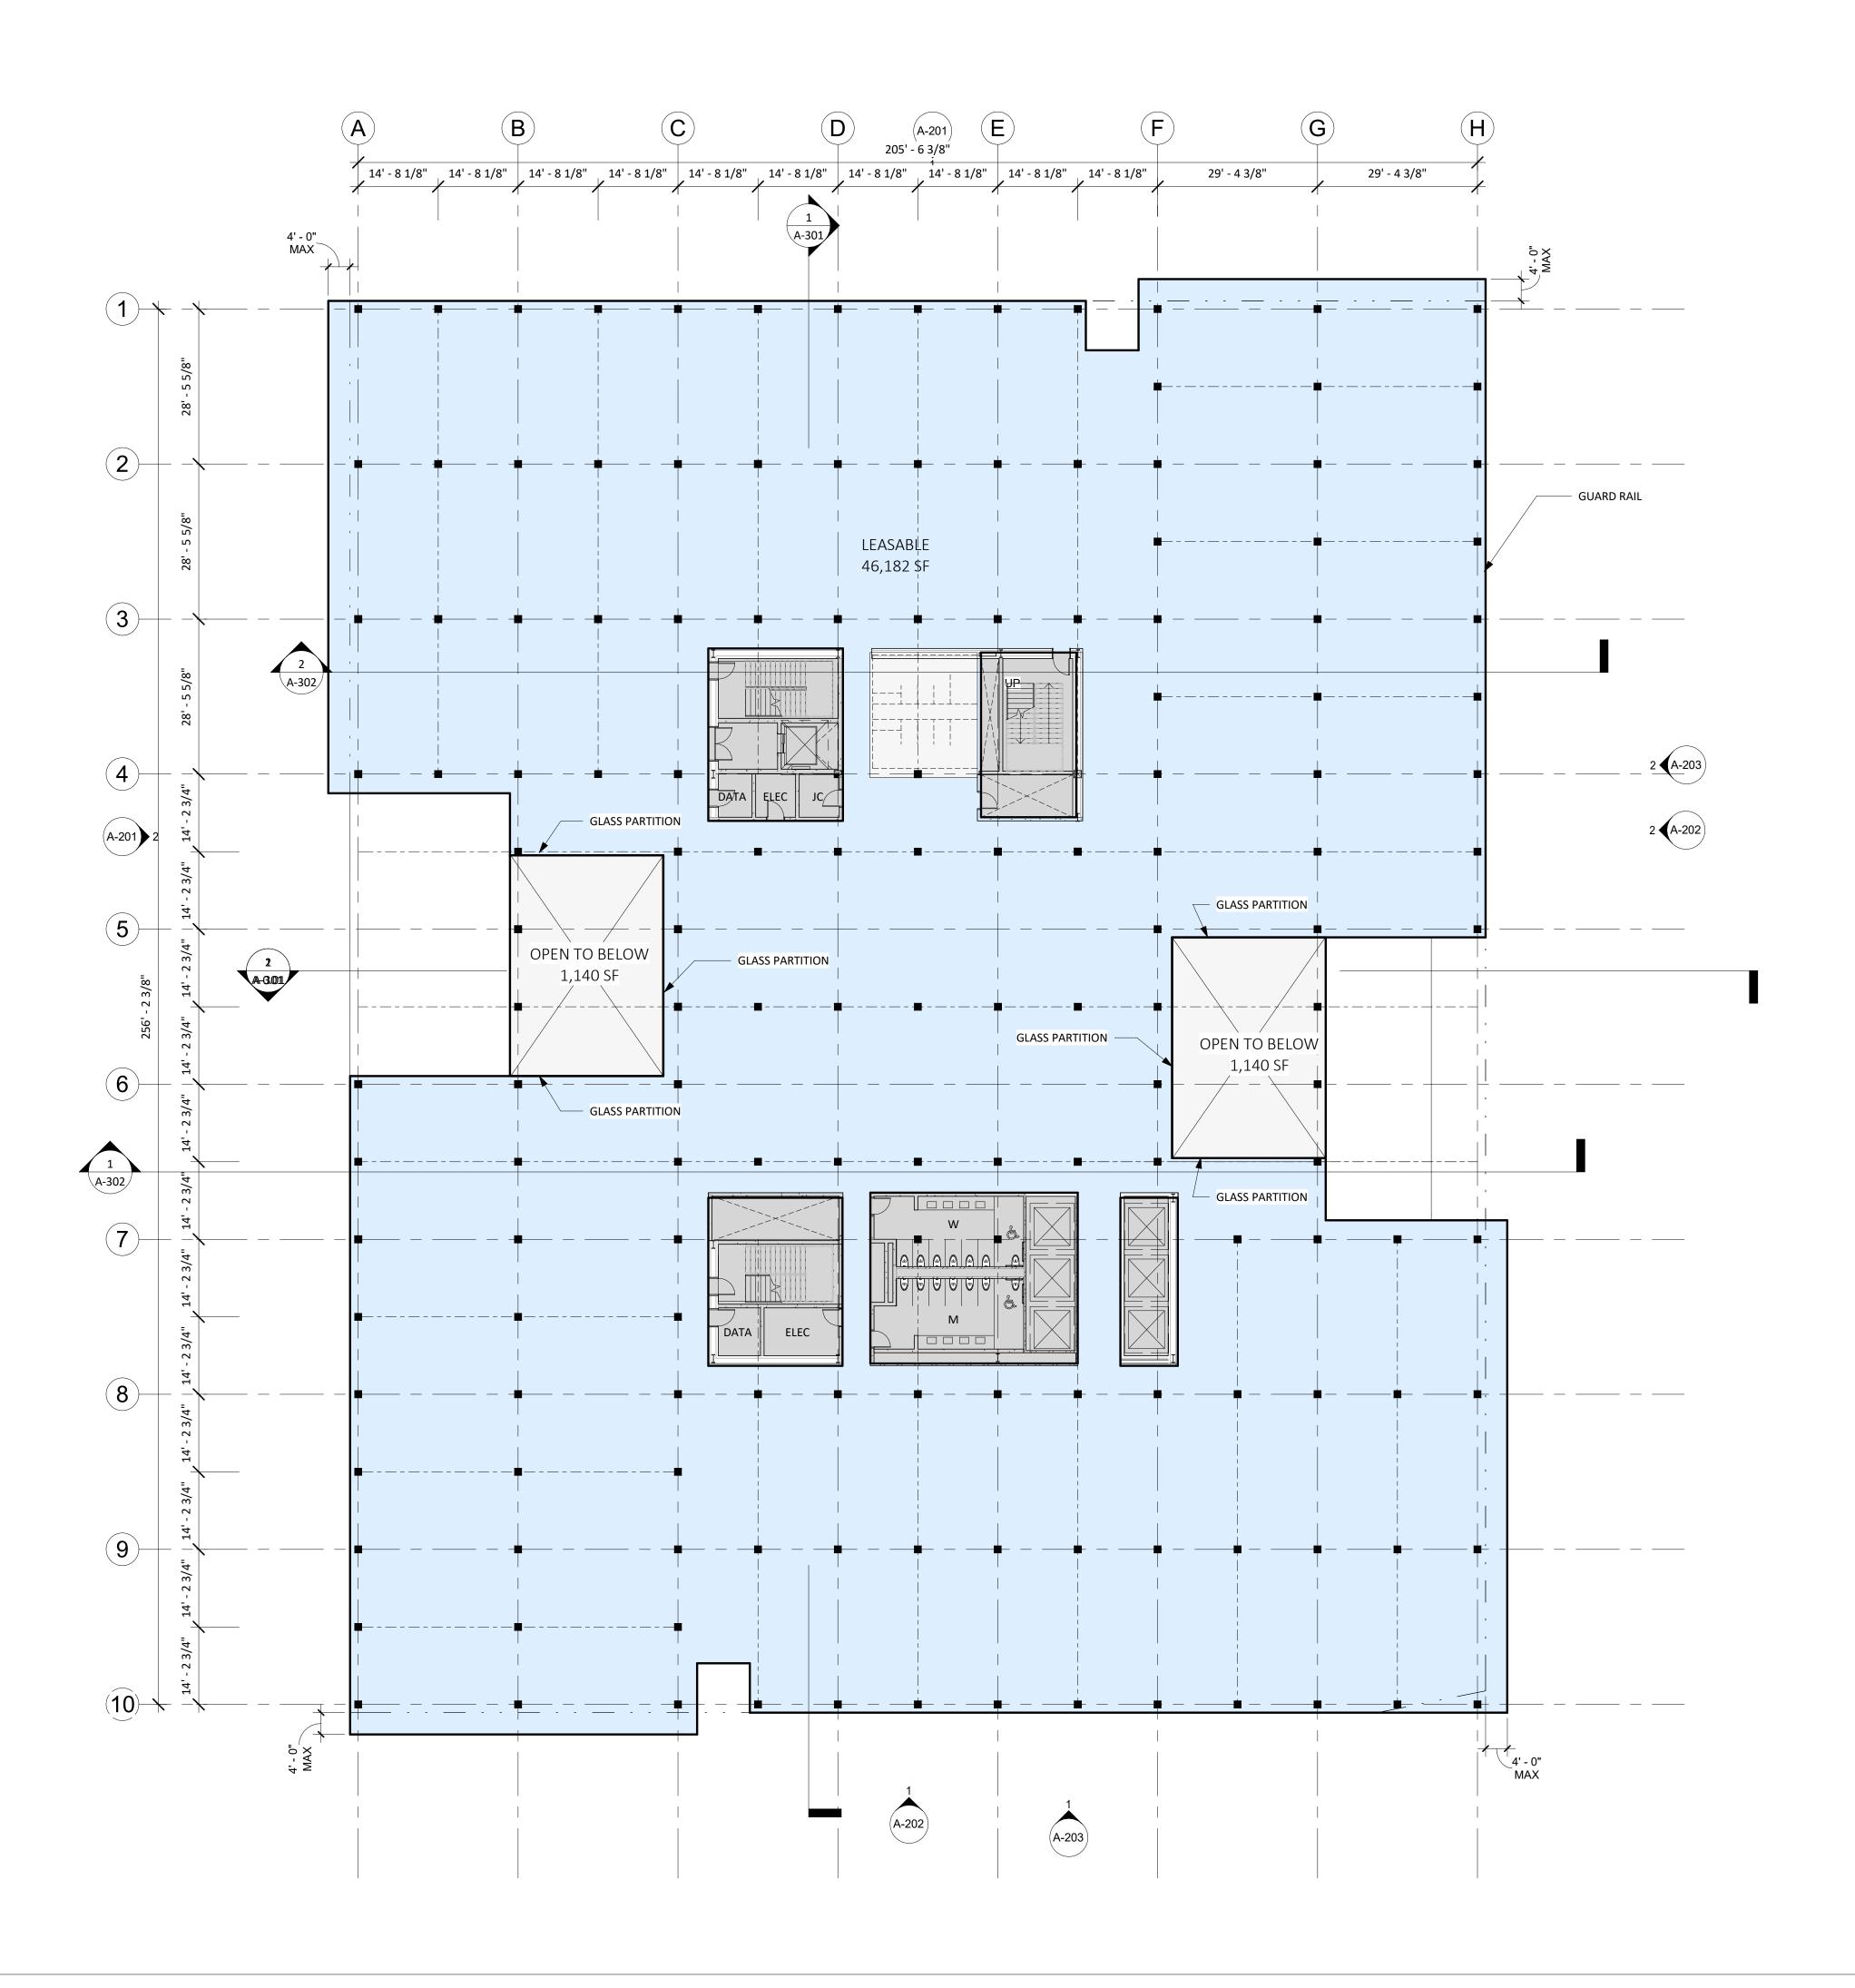

1 4TH FLOOR A-104 1/16" = 1'-0" ARCHITECTS

HACKER

733 SW Oak, Portland, OR 97205

QA

639 FRONT ST, SAN FRANCISCO, CA 94111

CONSULTANT

Mayor ED 17-02 Priority permit

STAMP

NOT FOR CONSTRUCTION

DATE

REVISION NO.

KEY PLAN - (NTS)

TRUE PLAN NORTH

PIER 70

Brookfield

Properties

BROOKFIELD PROPERTIES PIER 70 PARCEL A

ISSUANCE
DESIGN REVIEW PACKAGE
PROJECT NUMBER
1830


DATE
JULY 12, 2019

SCALE 1/16" = 1'-0"

DRAWING TITLE

LEVEL 4 FLOOR PLAN

SHEET NUMBER

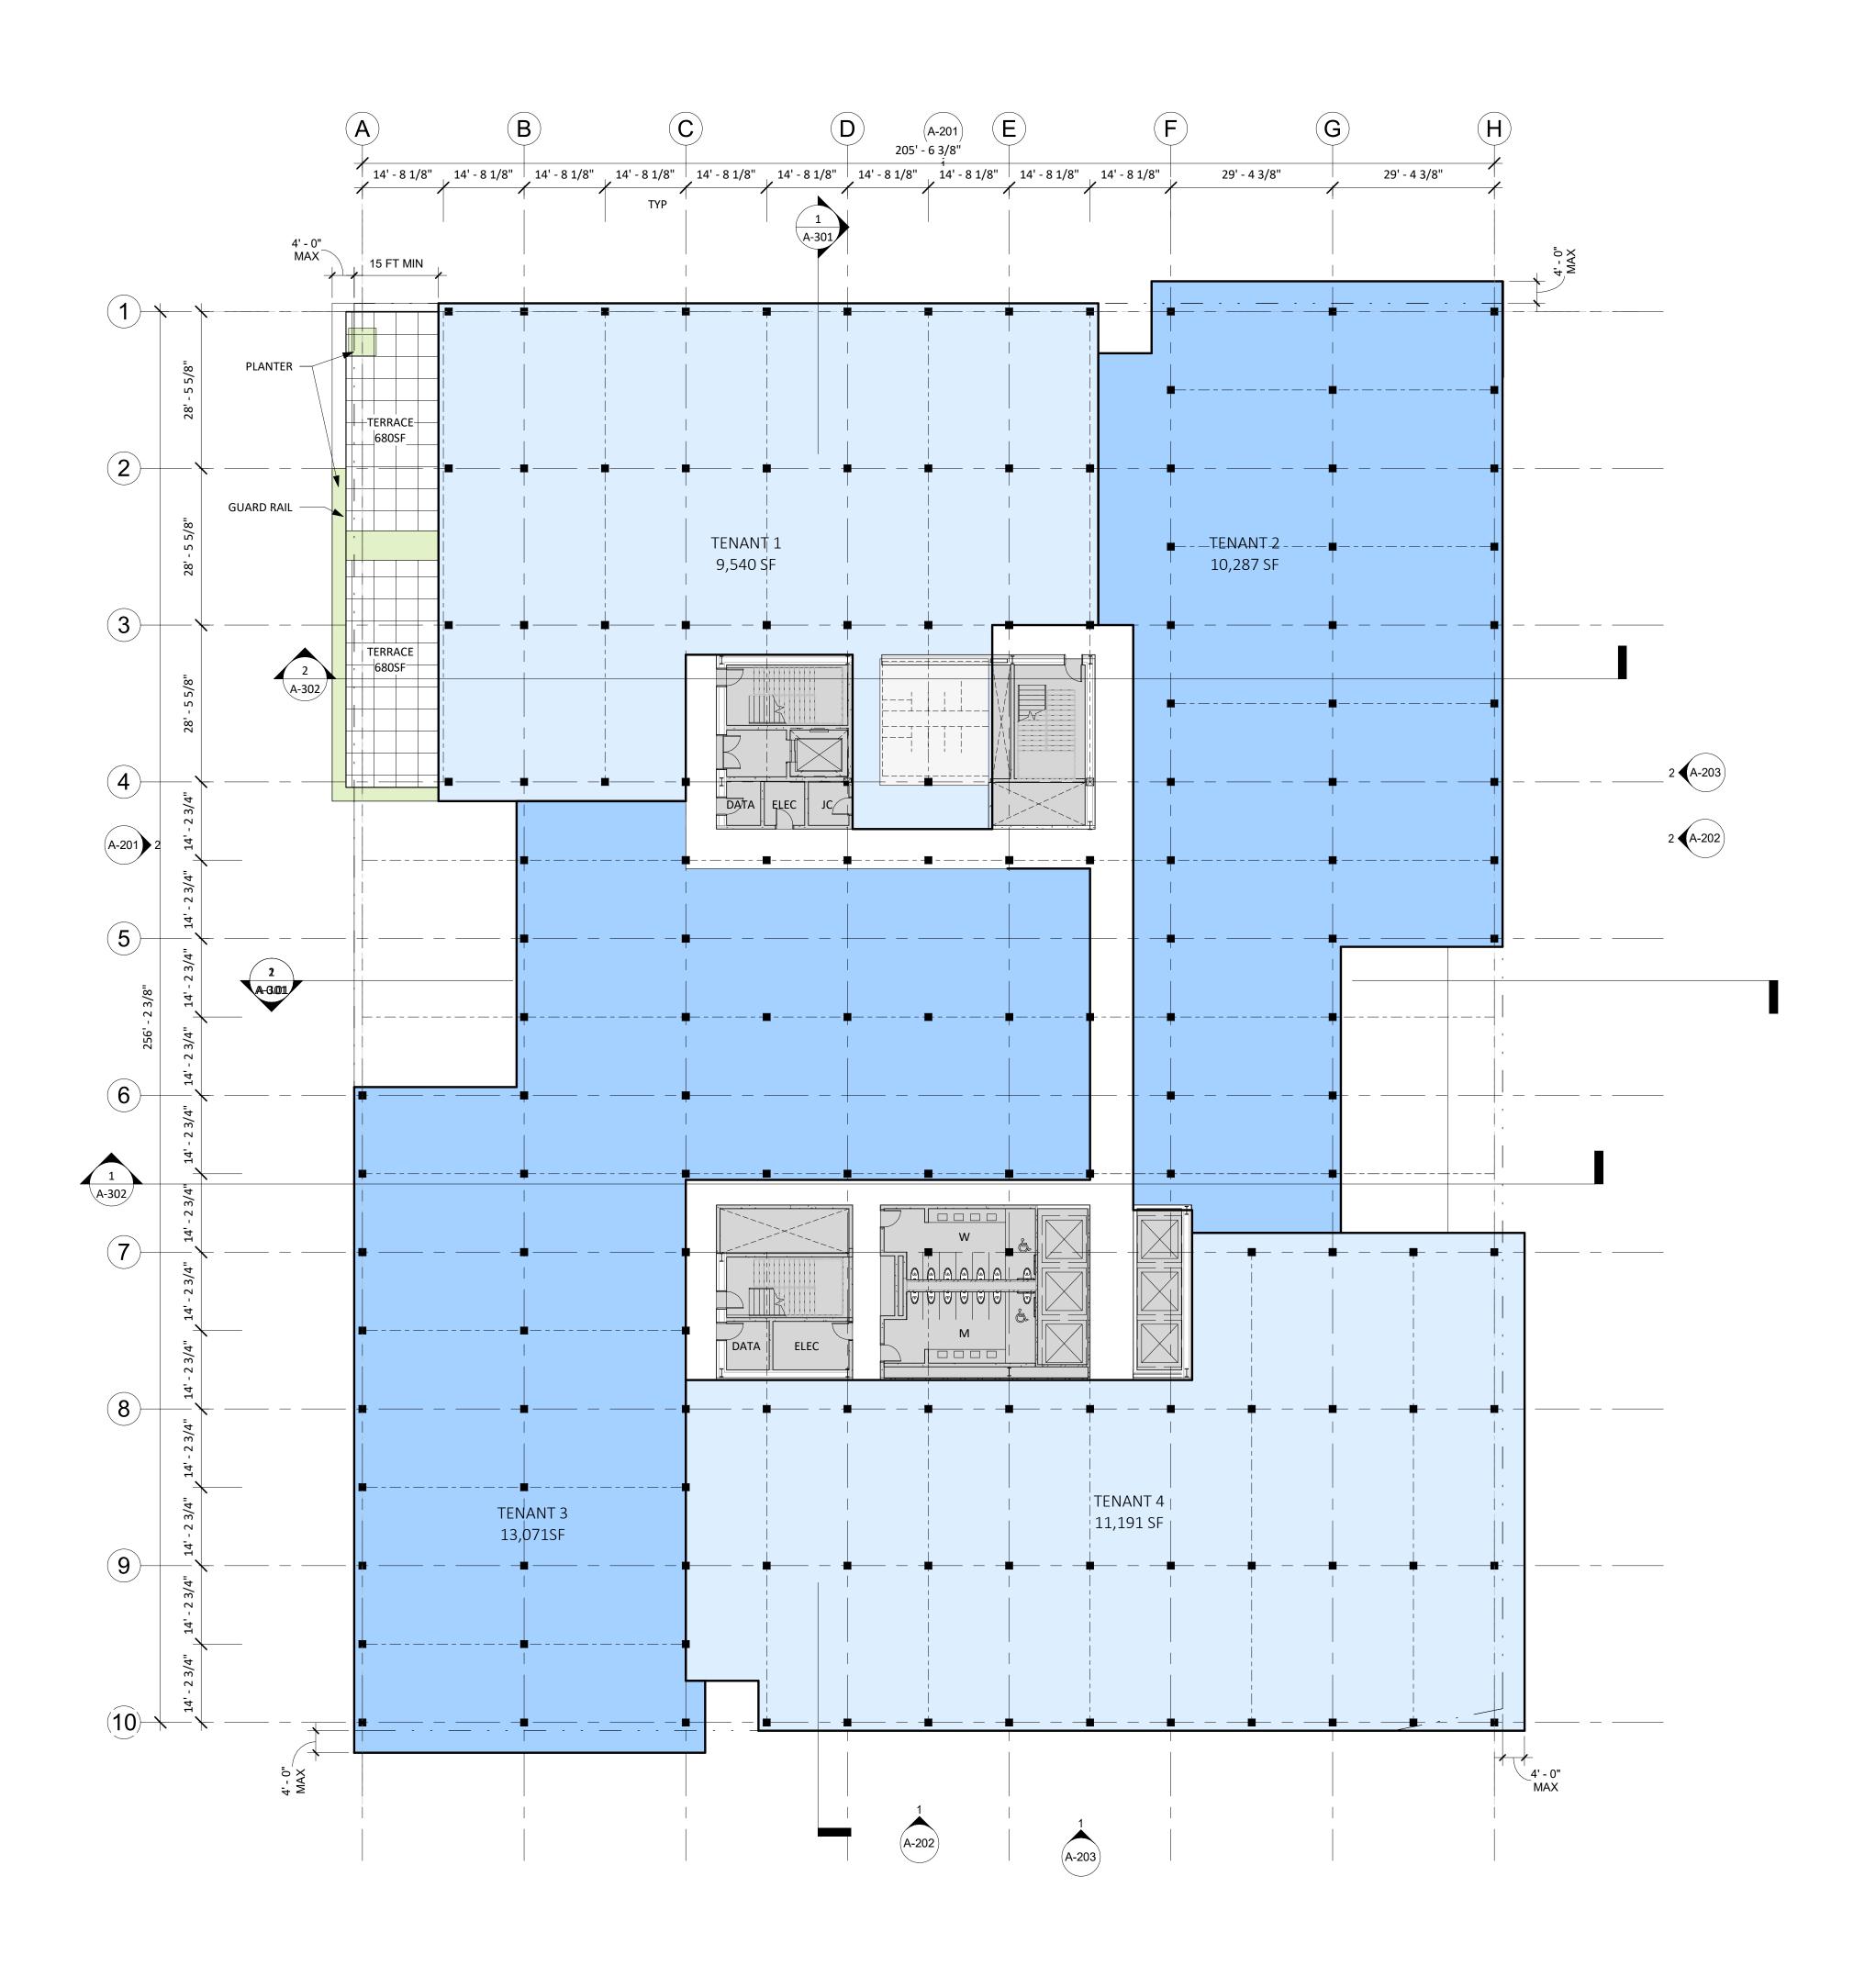

1 5TH FLOOR A-105 1/16" = 1'-0"

HACKER

733 SW Oak, Portland, OR 97205

QA

639 FRONT ST, SAN FRANCISCO, CA 94111

CONSULTANT

Mayor ED 17-02 Priority permit

NOT FOR CONSTRUCTION

DATE

REVISION NO.

KEY PLAN - (NTS)

TRUE PLAN NORTH PIER 70

Brookfield Properties

BROOKFIELD PROPERTIES PIER 70 PARCEL A


ISSUANCE
DESIGN REVIEW PACKAGE PROJECT NUMBER 1830

DATE
JULY 12, 2019

SCALE
1/16" = 1'-0" DRAWING TITLE

LEVEL 5 FLOOR PLAN

SHEET NUMBER

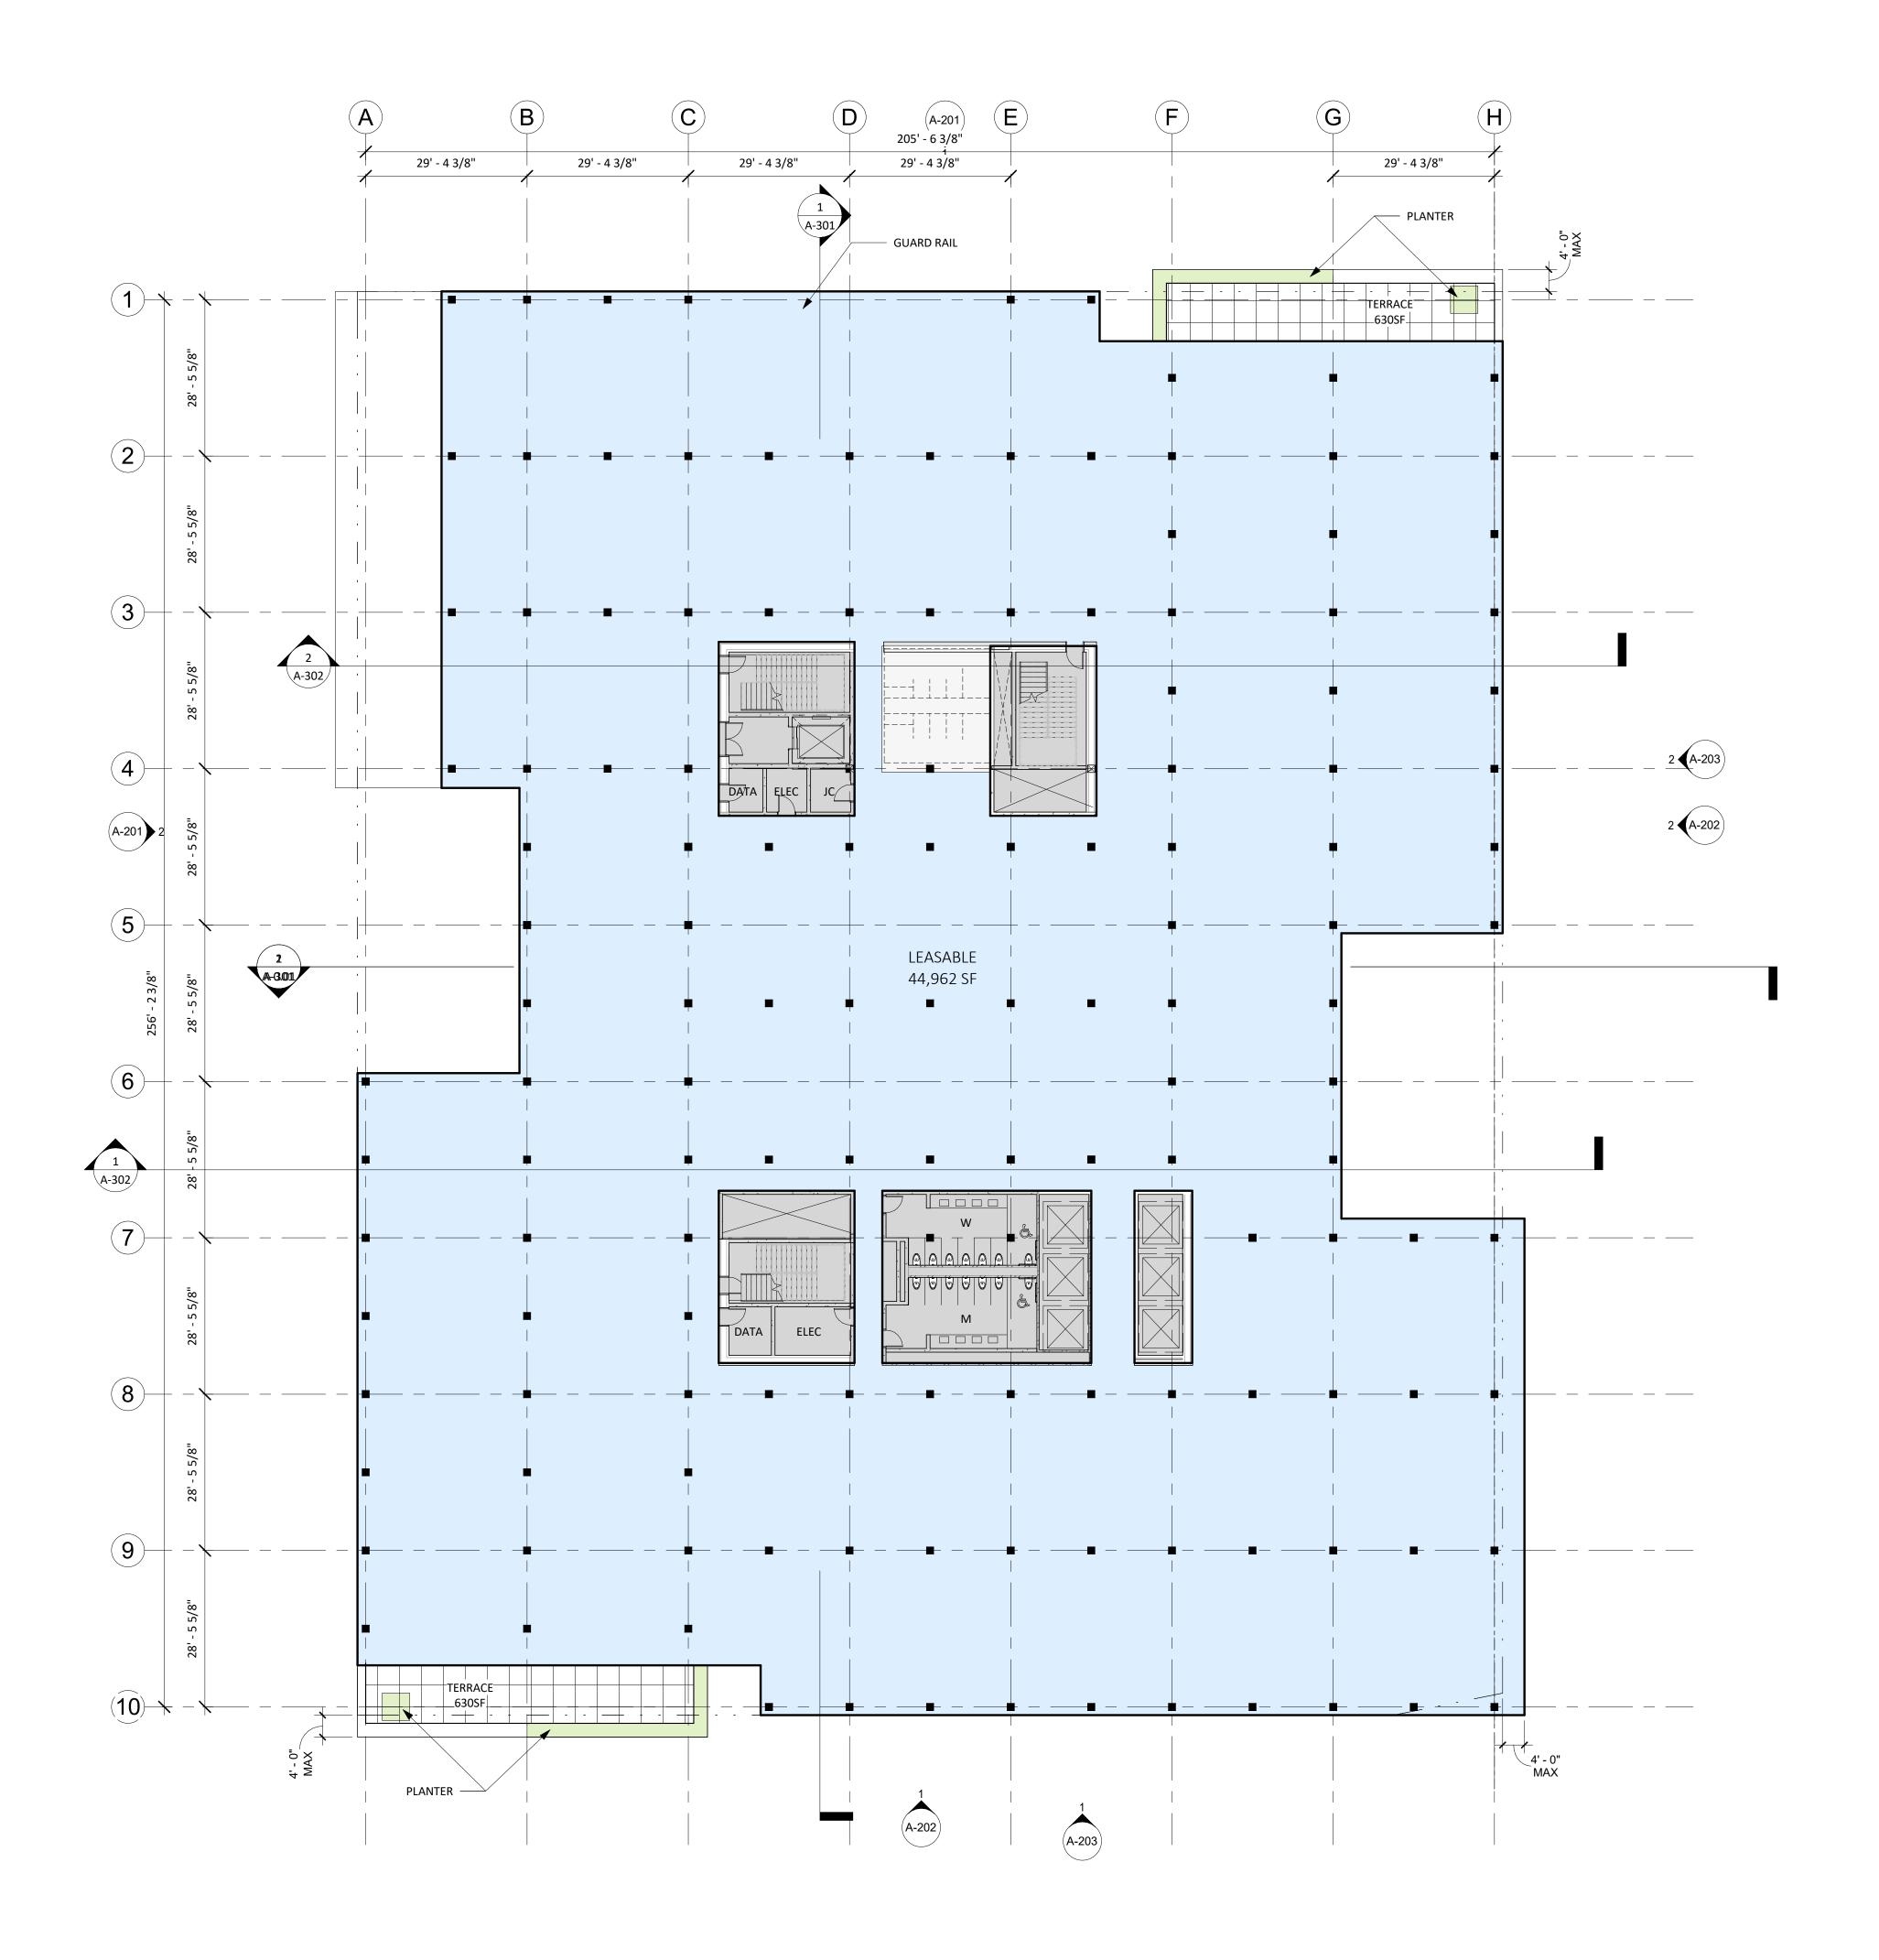

1 6TH FLOOR A-106 1/16" = 1'-0"

HACKER

733 SW Oak, Portland, OR 97205

QA

639 FRONT ST, SAN FRANCISCO, CA 94111

CONSULTANT

Mayor ED 17-02 Priority permit

NOT FOR CONSTRUCTION

DATE

REVISION NO.

KEY PLAN - (NTS)

TRUE PLAN NORTH

PIER 70

Brookfield Properties

BROOKFIELD PROPERTIES PIER 70 PARCEL A


ISSUANCE
DESIGN REVIEW PACKAGE PROJECT NUMBER 1830

DATE
JULY 12, 2019

SCALE
1/16" = 1'-0"

DRAWING TITLE

LEVEL 6 FLOOR PLAN

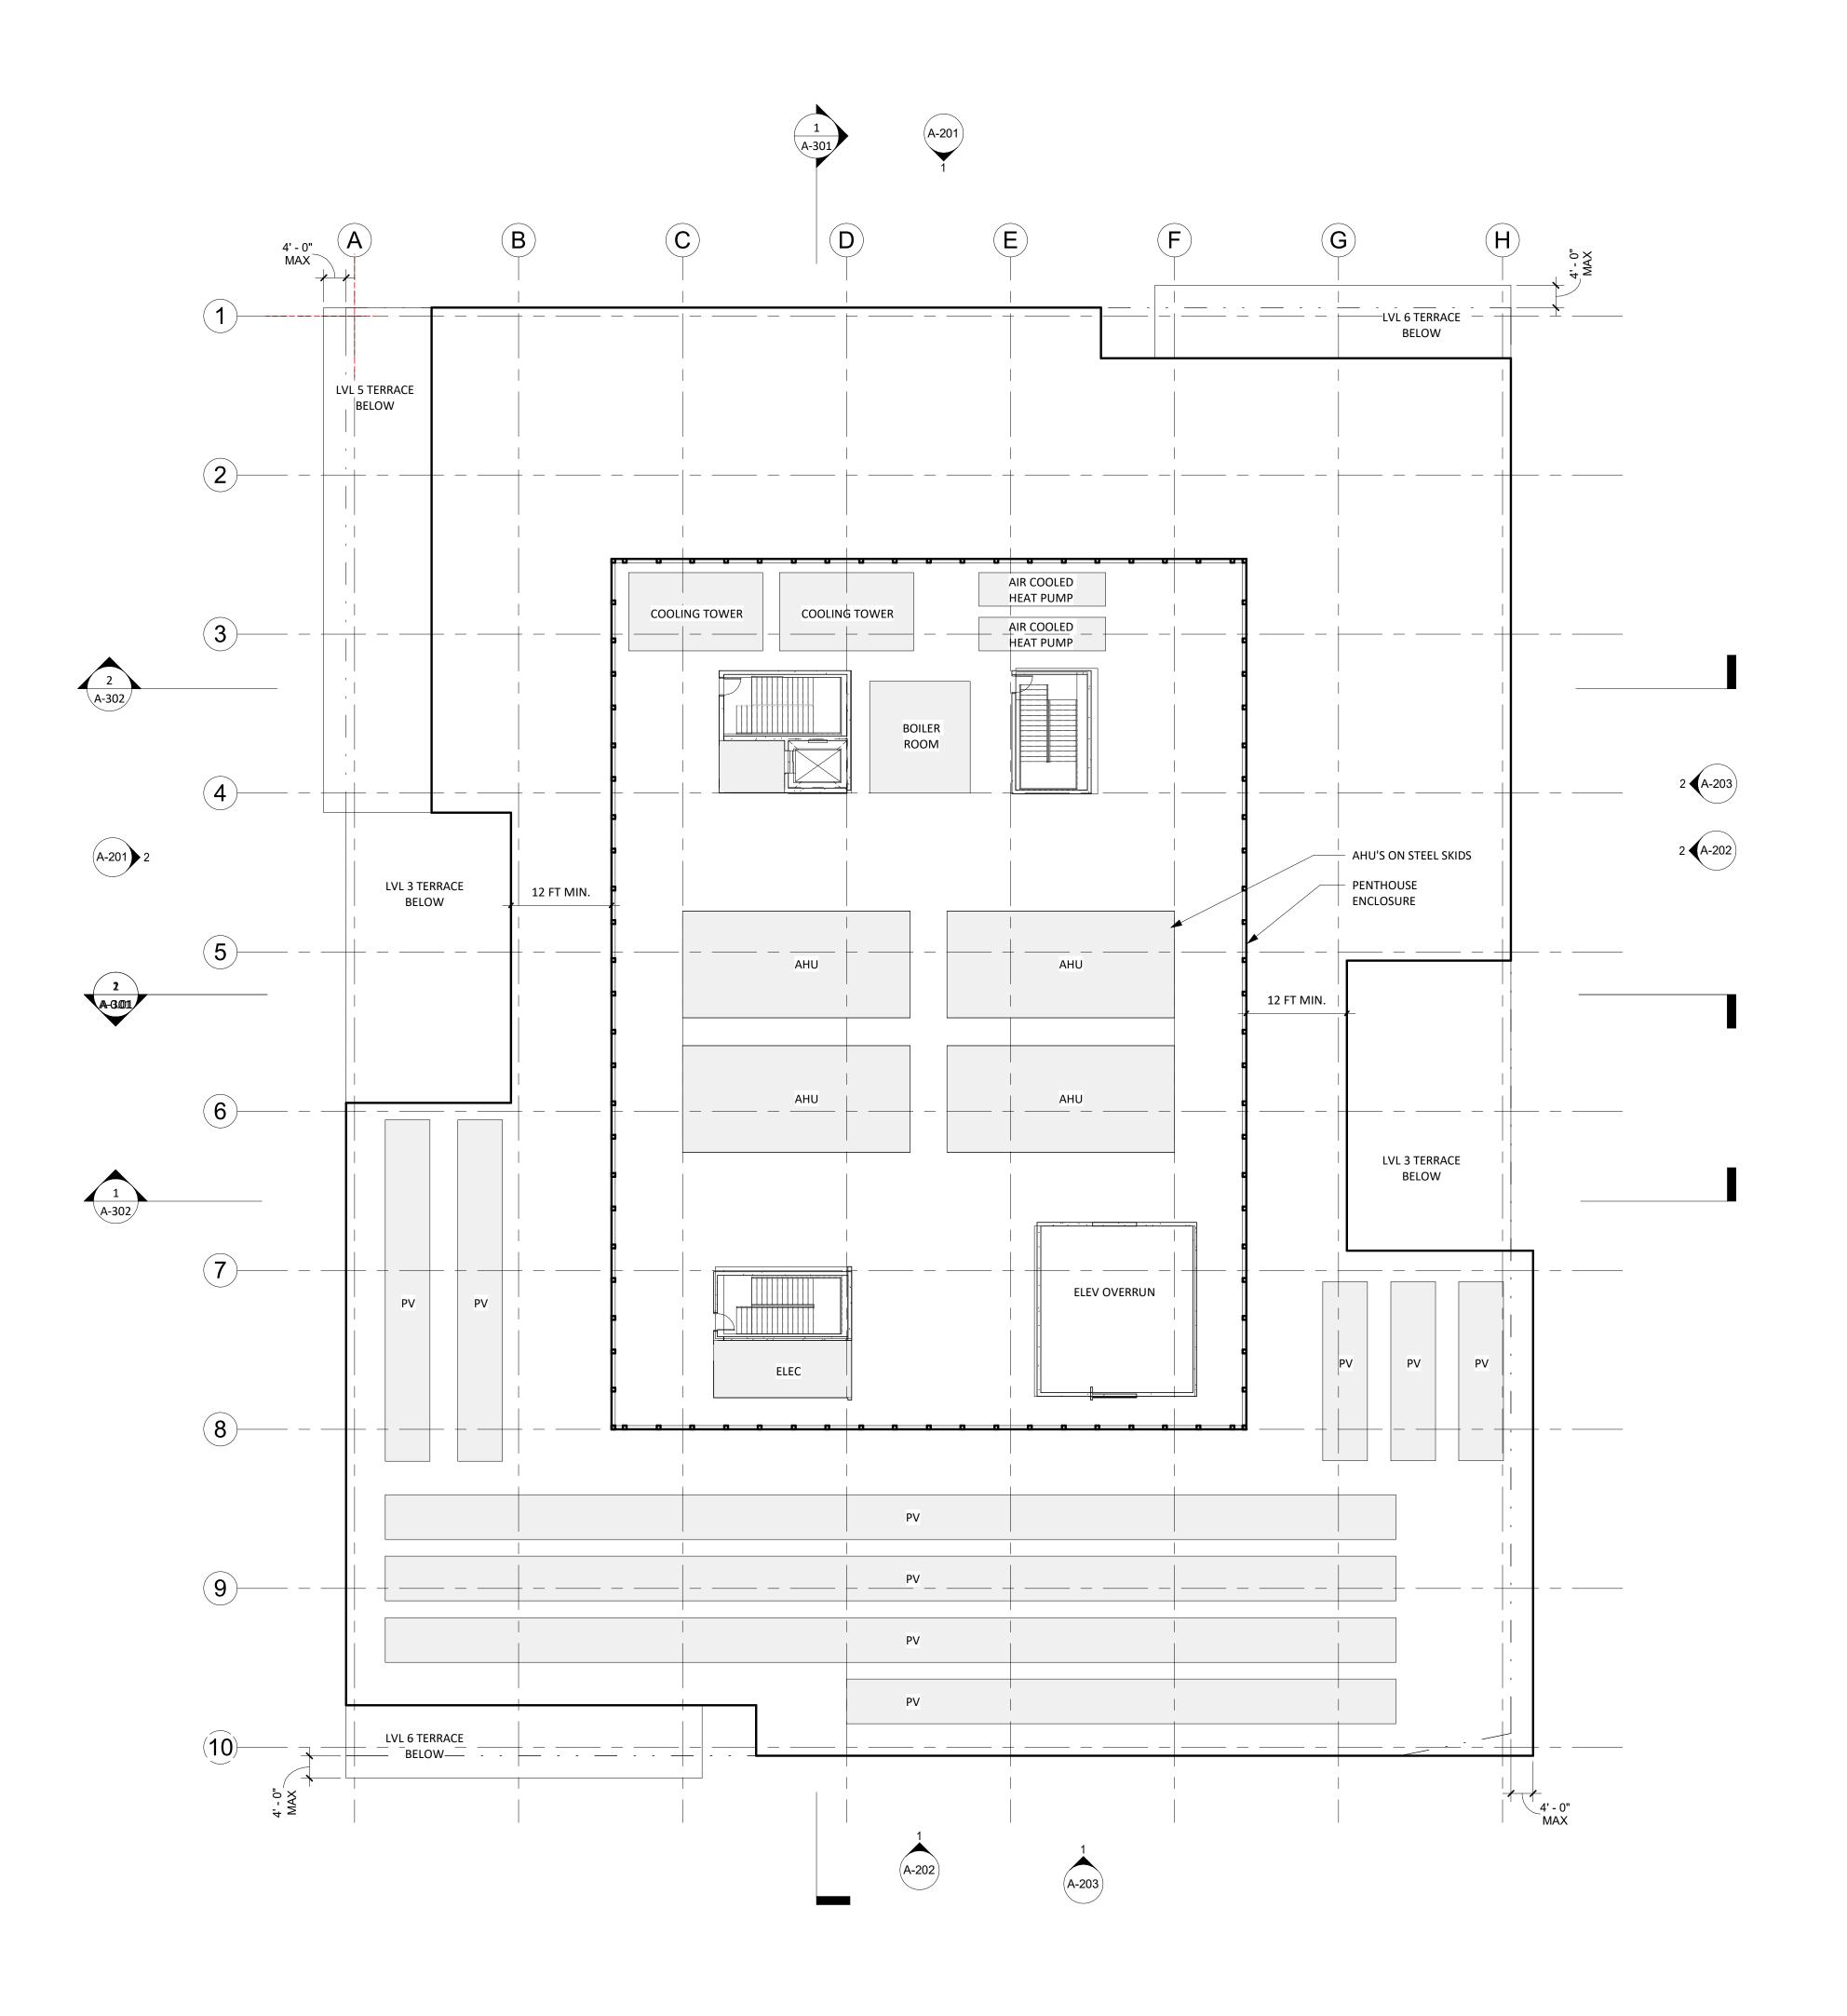

1 ROOF A-107 1/16" = 1'-0"

HACKER

733 SW Oak, Portland, OR 97205

QA

639 FRONT ST, SAN FRANCISCO, CA 94111

CONSULTANT

Mayor ED 17-02 Priority permit

NOT FOR CONSTRUCTION

REVISION NO. DATE

KEY PLAN - (NTS)

TRUE PLAN NORTH PIER 70

Brookfield

Properties

BROOKFIELD PROPERTIES PIER 70 PARCEL A

ISSUANCE
DESIGN REVIEW PACKAGE

PROJECT NUMBER 1830

DATE
JULY 12, 2019

SCALE
1/16" = 1'-0"

DRAWING TITLE
ROOF PLAN

SHEET NUMBER



HACKER

733 SW Oak, Portland, OR 97205

QA

CONSULTANT

639 FRONT ST, SAN FRANCISCO, CA 94111

Mayor ED 17-02 Priority permit

STAMP

NOT FOR CONSTRUCTION

REVISION NO. DATE

KEY PLAN - (NTS)

PIER 70

BrookfieldProperties

BROOKFIELD PROPERTIES PIER 70 PARCEL A

DESIGN REVIEW PACKAGE

PROJECT NUMBER

1830

DATE JULY 12, 2019 SCALE 3/32" = 1'-0"

DRAWING TITLE
EXTERIOR ELEVATIONS

SHEET NUMBER





733 SW Oak, Portland, OR 97205

QA

CONSULTANT

639 FRONT ST, SAN FRANCISCO, CA 94111

Mayor ED 17-02 Priority permit

NOT FOR CONSTRUCTION

REVISION NO.

STAMP

PIER 70

KEY PLAN - (NTS)

BrookfieldProperties

BROOKFIELD PROPERTIES PIER 70 PARCEL A


DESIGN REVIEW PACKAGE
PROJECT NUMBER
1830

DATE JULY 12, 2019 SCALE 3/32" = 1'-0"

E 2" = 1'-0"

EXTERIOR ELEVATIONS

SHEET NUMBER

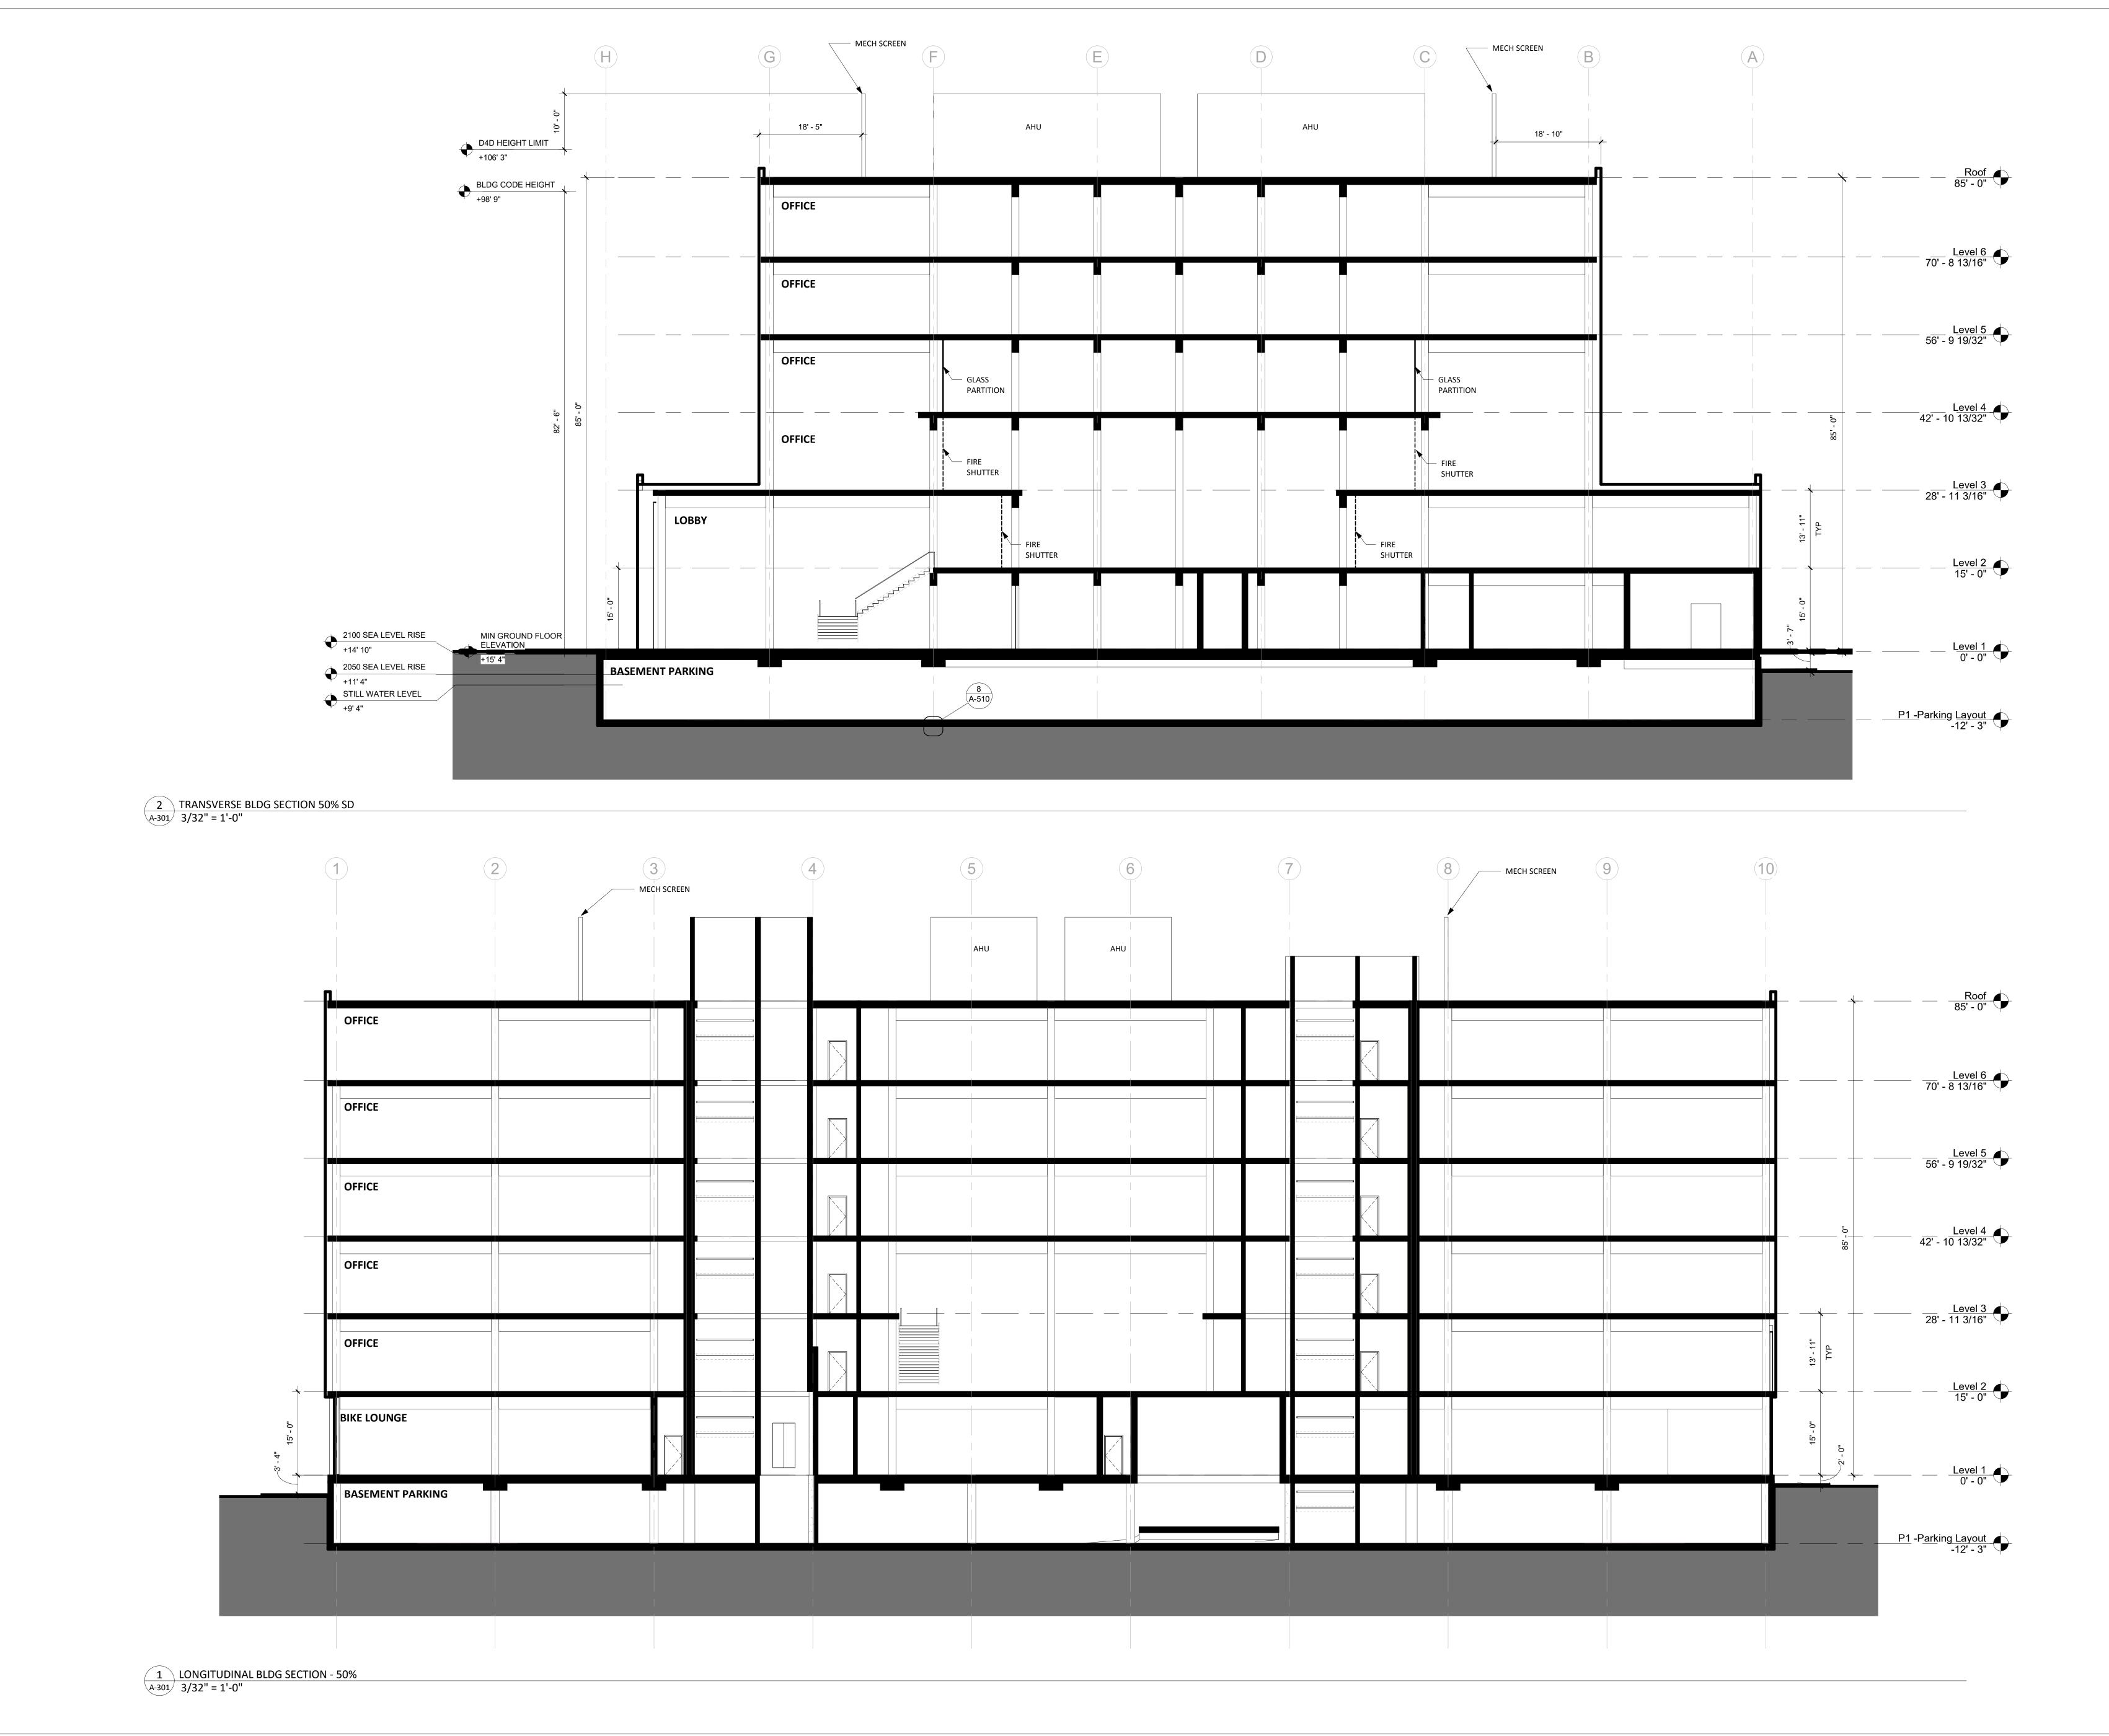

733 SW Oak, Portland, OR 97205

QA

639 FRONT ST, SAN FRANCISCO, CA 94111

CONSULTANT

Mayor ED 17-02 Priority permit

STAMP

NOT FOR CONSTRUCTION

DATE REVISION NO.

KEY PLAN - (NTS)

TRUE PLAN NORTH PIER 70

Brookfield Properties

BROOKFIELD PROPERTIES PIER 70 PARCEL A

ISSUANCE
DESIGN REVIEW PACKAGE

PROJECT NUMBER 1830 DATE JULY 12, 2019

SCALE 3/32" = 1'-0"

DRAWING TITLE

BUILDING SECTIONS

733 SW Oak, Portland, OR 97205

QA

639 FRONT ST, SAN FRANCISCO, CA 94111

CONSULTANT

Mayor ED 17-02 Priority permit

NOT FOR CONSTRUCTION

REVISION NO. DATE

KEY PLAN - (NTS)

TRUE PLAN NORTH

PIER 70 **Brookfield**

Properties

BROOKFIELD PROPERTIES PIER 70 PARCEL A

ISSUANCE
DESIGN REVIEW PACKAGE PROJECT NUMBER 1830


DATE
JULY 12, 2019

SCALE
3/32" = 1'-0"

DRAWING TITLE

BUILDING SECTIONS

SHEET NUMBER

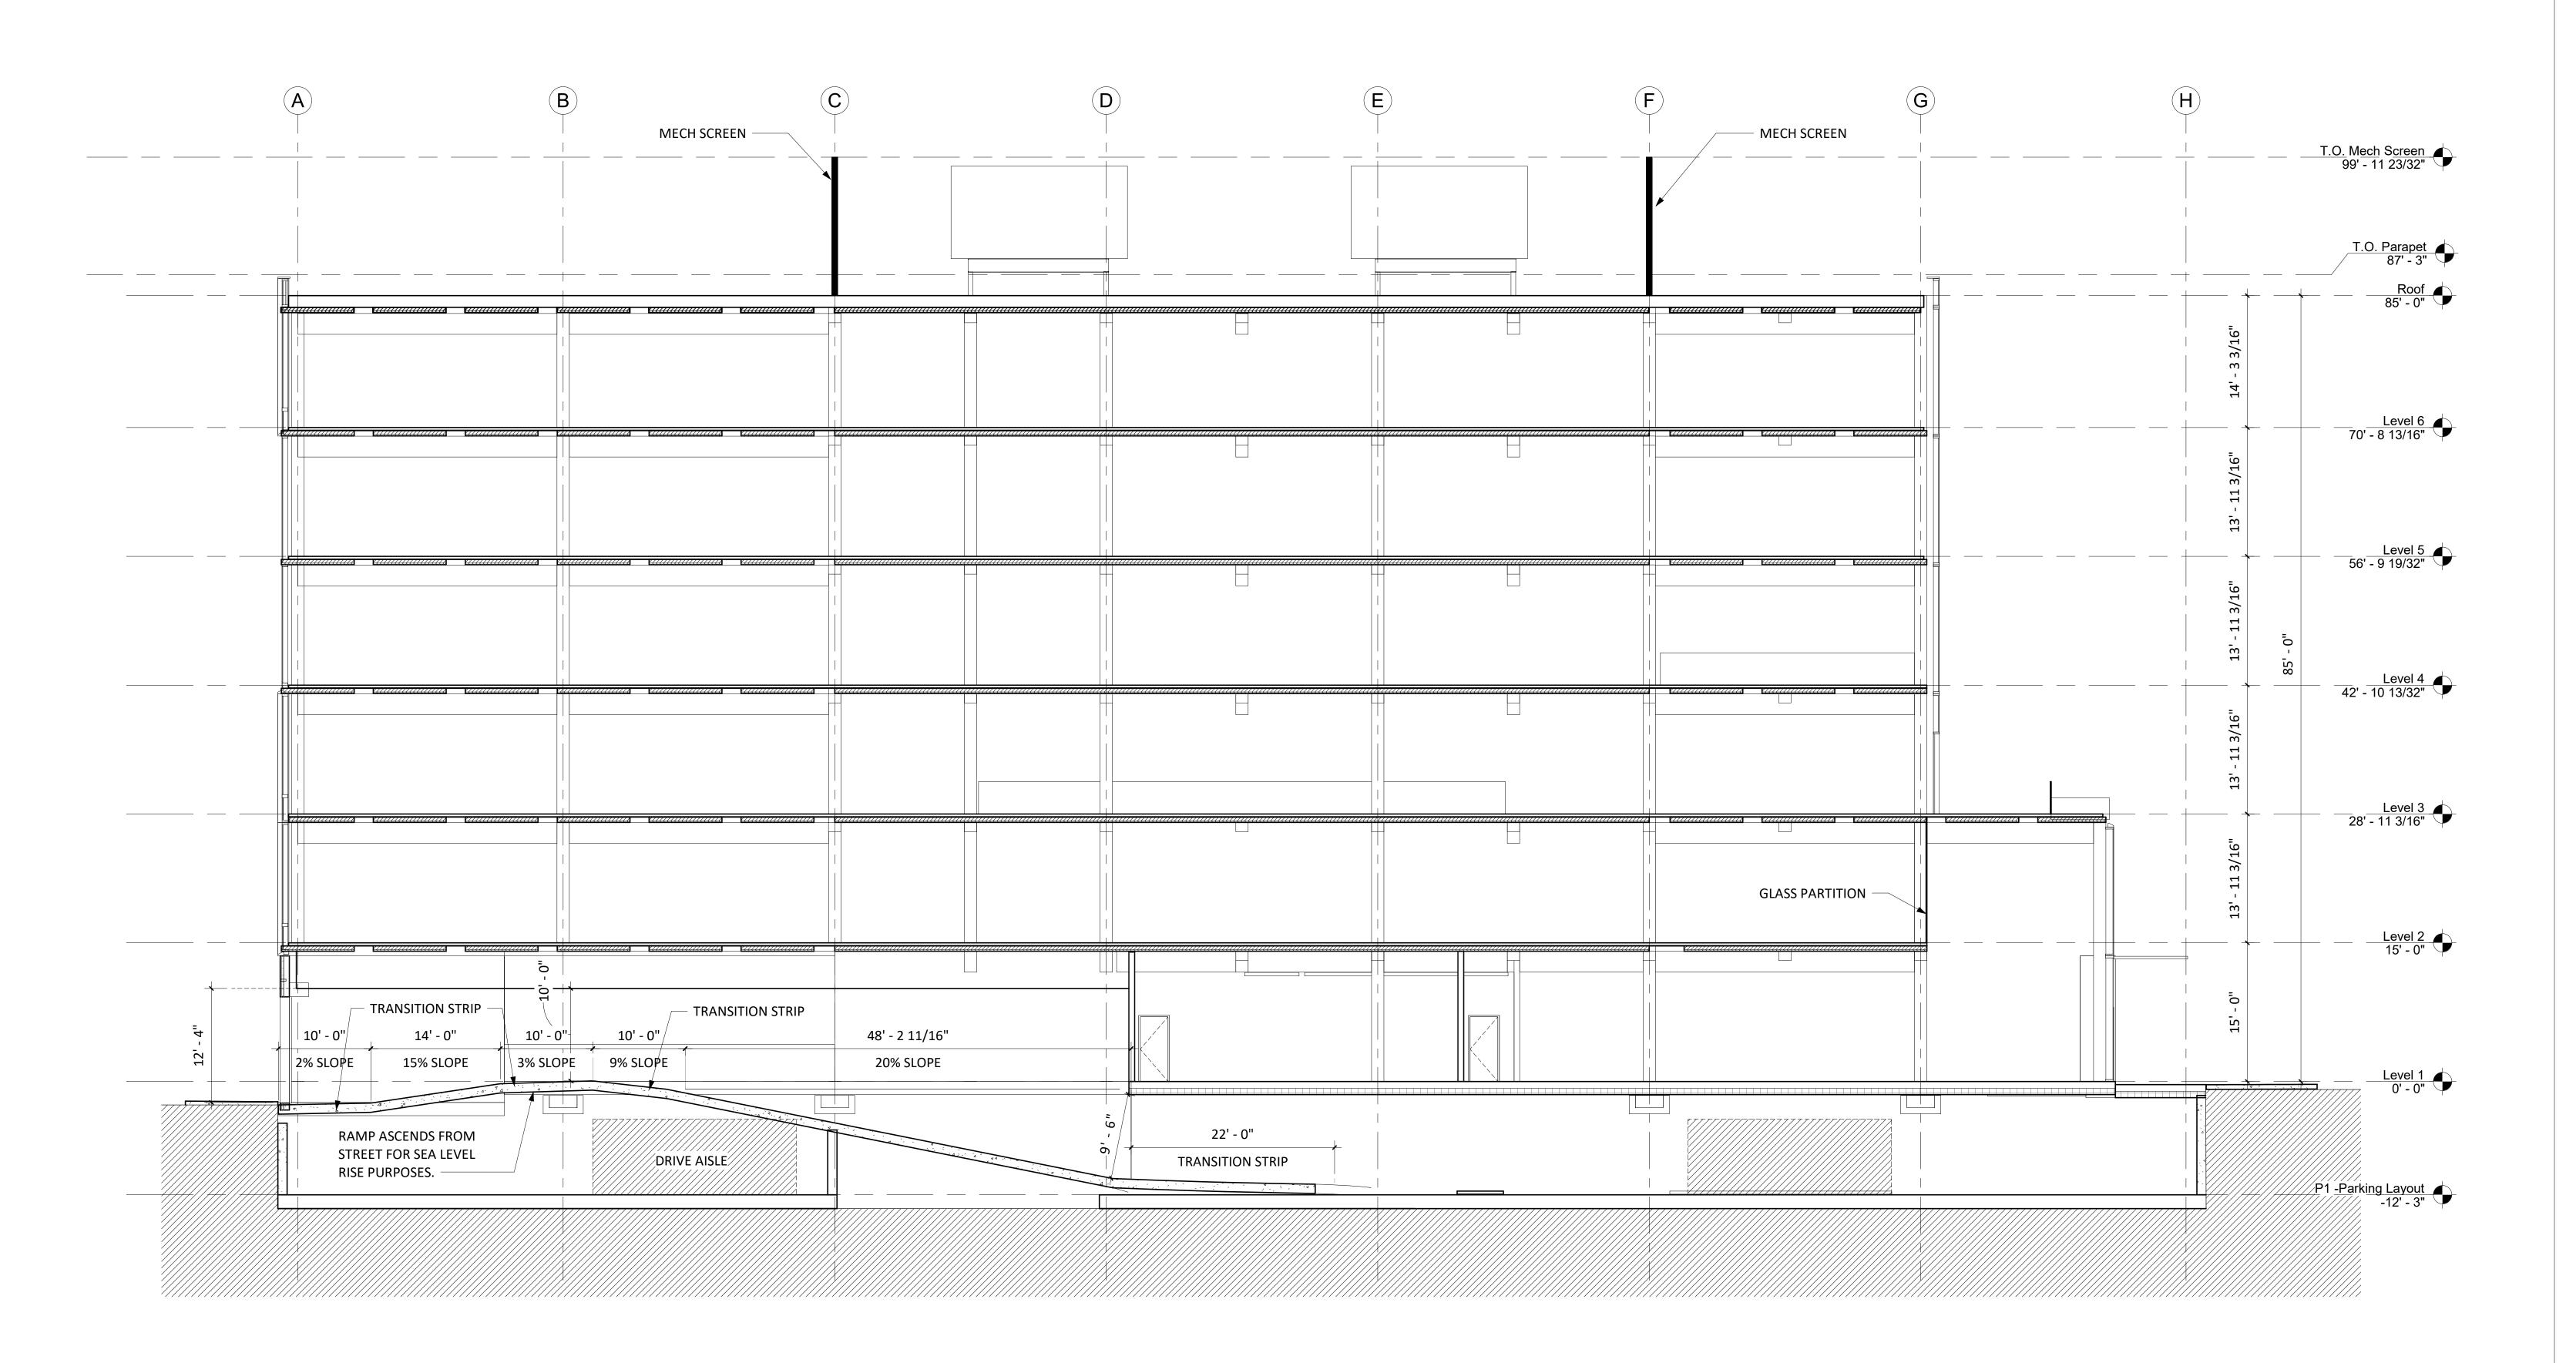

1 E-W BLDG SECTION GRID 6 1/8" = 1'-0"

HACKER

733 SW Oak, Portland, OR 97205

QA

639 FRONT ST, SAN FRANCISCO, CA 94111

CONSULTANT

Mayor ED 17-02 Priority permit

SITE PERMIT BE STARTED UNTIL CONSTRUCTION

PLANS HAVE BEEN APPROVED.



DATE

REVISION NO.

KEY PLAN - (NTS)

TRUE PLAN NORTH PIER 70

Brookfield Properties

BROOKFIELD PROPERTIES PIER 70 PARCEL A

ISSUANCE SITE PERMIT PROJECT NUMBER

DATE
SEPTEMBER 04, 2019

SCALE 1/8" = 1'-0"

DRAWING TITLE **BUILDING SECTIONS**

SHEET NUMBER



733 SW Oak, Portland, OR 97205

QA

639 FRONT ST, SAN FRANCISCO, CA 94111

CONSULTANT

Mayor ED 17-02 Priority permit

NOT FOR CONSTRUCTION

REVISION NO. DATE

KEY PLAN - (NTS)

TRUE PLAN NORTH

Brookfield

BROOKFIELD PROPERTIES PIER 70 PARCEL A

ISSUANCE DESIGN REVIEW PACKAGE

PROJECT NUMBER

DATE
JULY 12, 2019

SCALE
1/2" = 1'-0"


DRAWING TITLE

ENLARGED PLANS

SHEET NUMBER


A-310.1



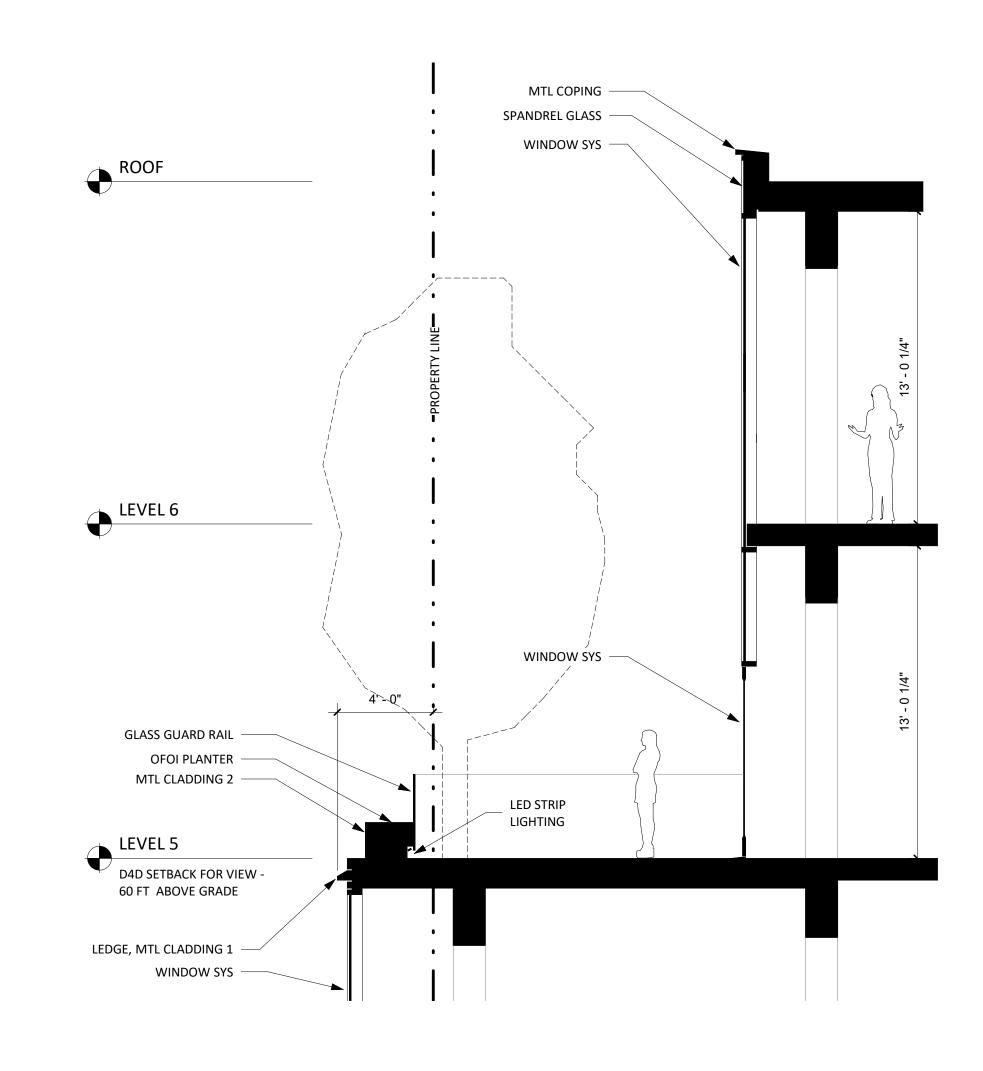

1 UPPER TERRACE - TYPICAL A-310.2 1/4" = 1'-0"



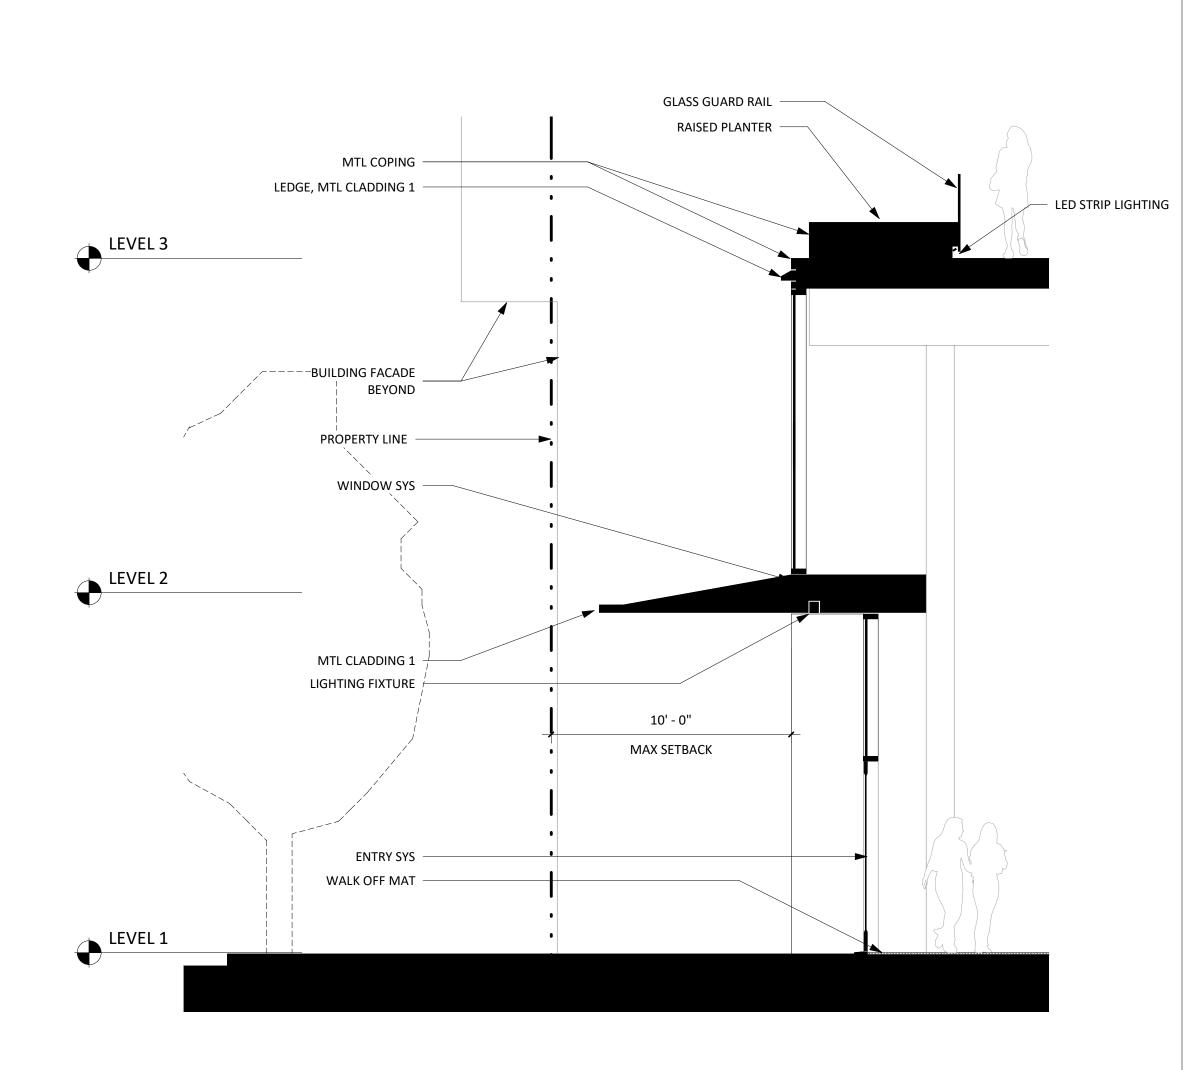

2 MARYLAND ST BUILDING ENTRY A-310.2 1/4" = 1'-0" ARCHITECTS

HACKER

733 SW Oak, Portland, OR 97205

QA

639 FRONT ST, SAN FRANCISCO, CA 94111

CONSULTANT

Mayor ED 17-02 Priority permit

STAMP

NOT FOR CONSTRUCTION

DATE

REVISION NO.

KEY PLAN - (NTS)

TRUE PLAN NORTH

PIER 70

BrookfieldProperties

BROOKFIELD PROPERTIES PIER 70 PARCEL A

ISSUANCE
DESIGN REVIEW PACKAGE
PROJECT NUMBER
1830

DATE
JULY 12, 2019

SCALE
1/4" = 1'-0"

SCALE
1/4" = 1'-0"


DRAWING TITLE


ENLARGED SECTIONS


SHEET NUMBER

A-310.2




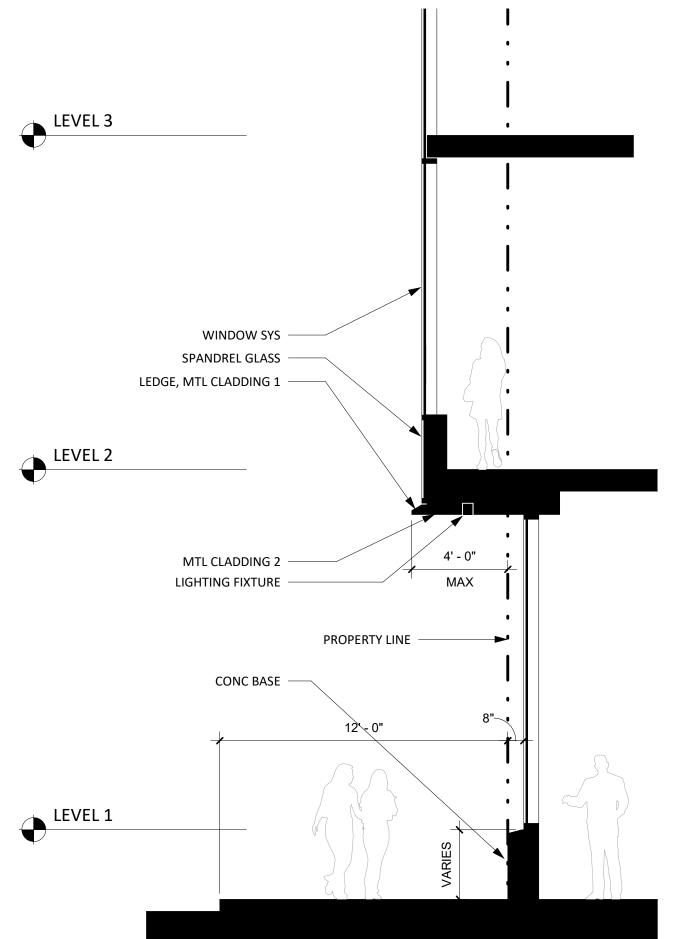


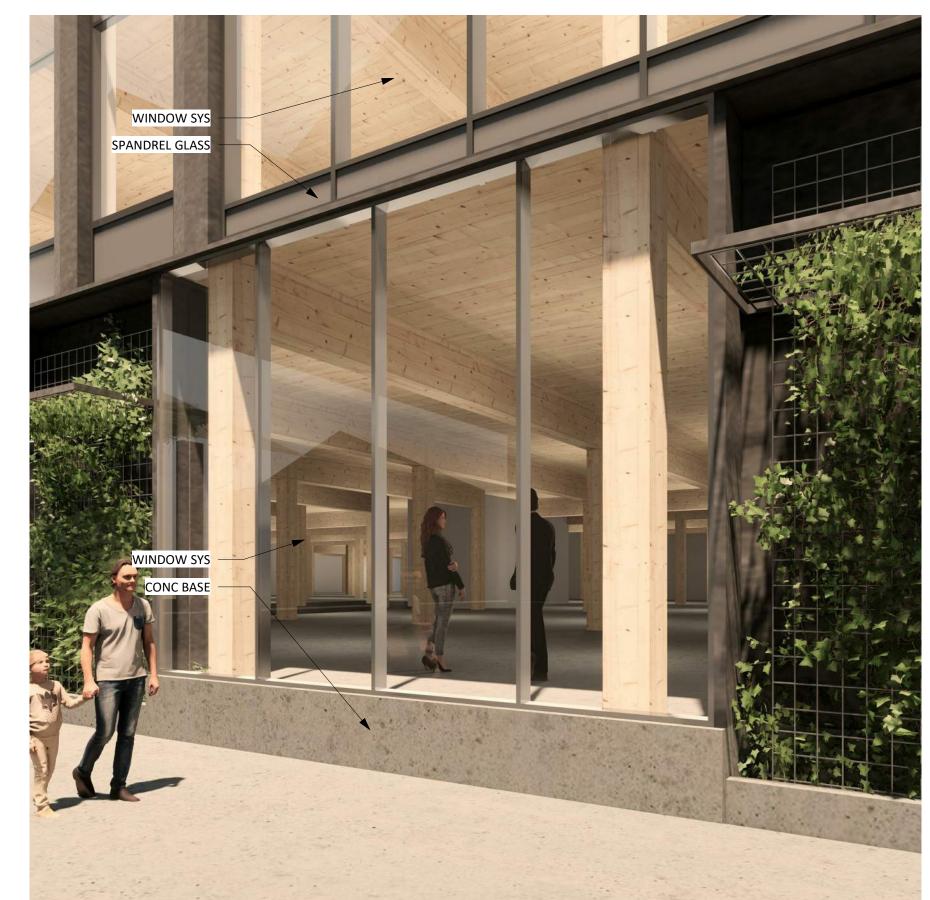


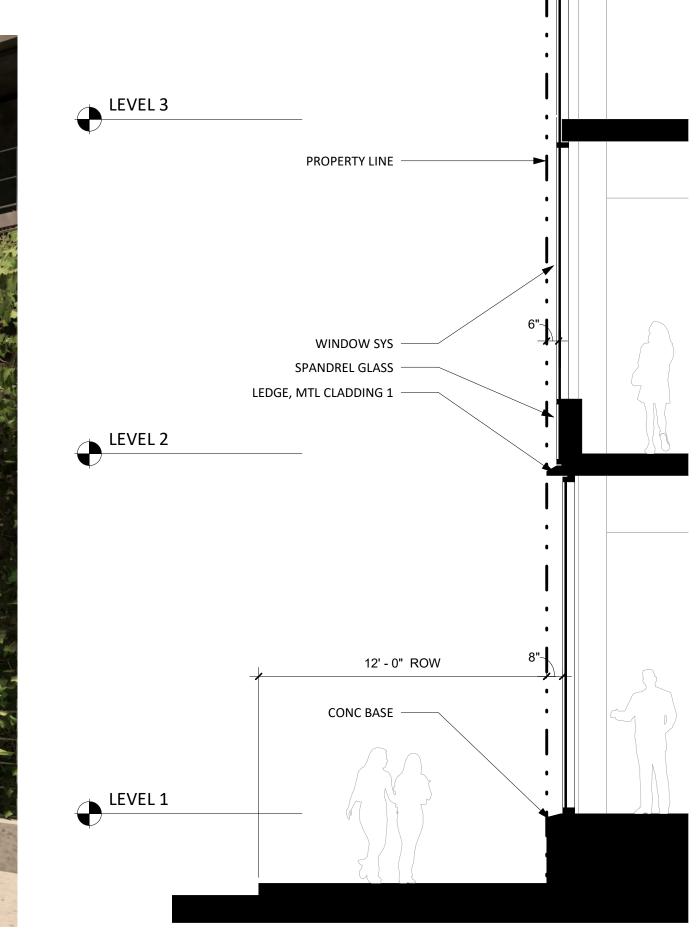



3 ROW OVERHANG GLASS - DR A-310.3 1/4" = 1'-0"

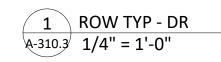

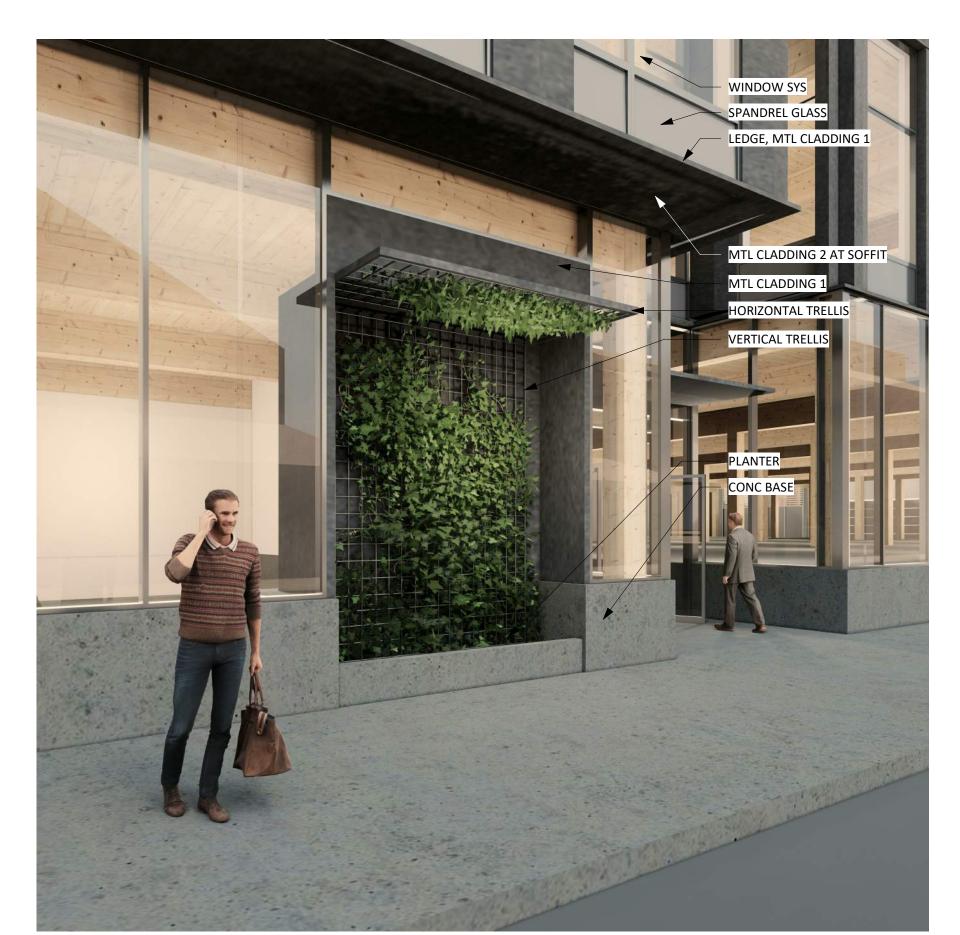

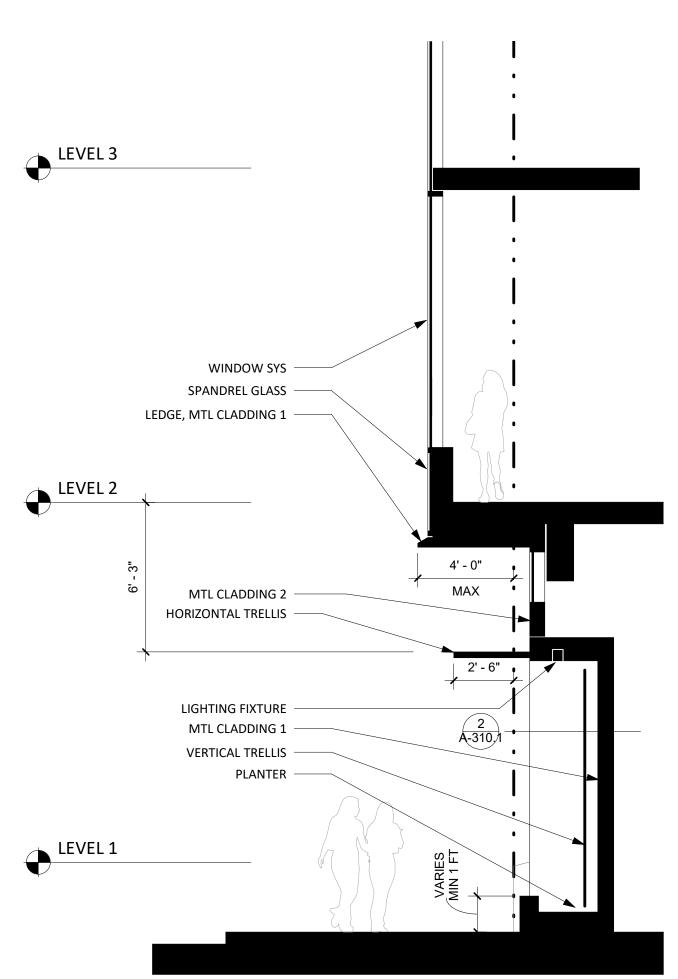

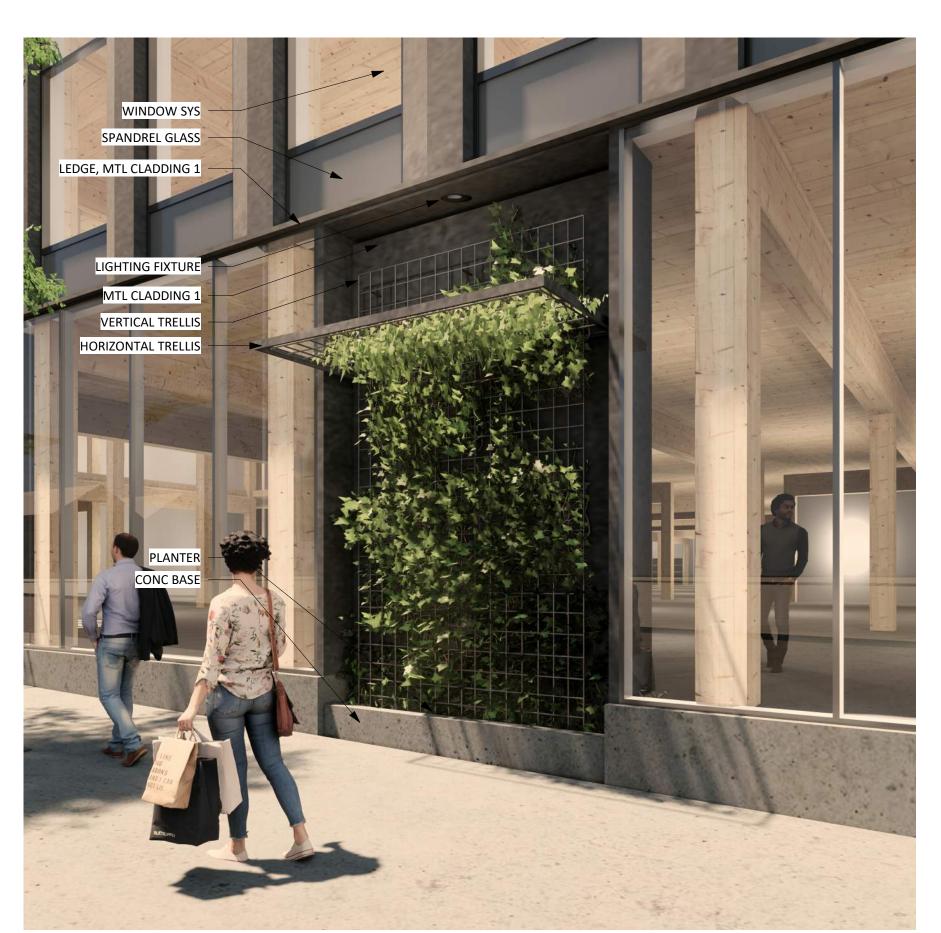

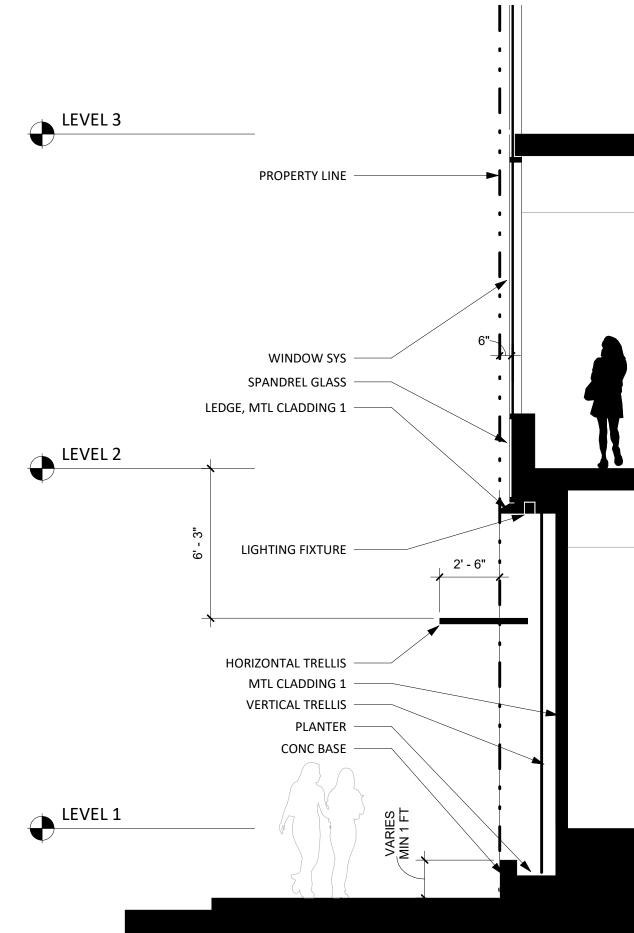

4 ROW OVERHANG BENCH - DR Copy 1
A-310.3 1/4" = 1'-0"

2 ROW PLANTER TYP - DR A-310.3 1/4" = 1'-0" ARCHITECTS

HACKER

733 SW Oak, Portland, OR 97205

QA

639 FRONT ST, SAN FRANCISCO, CA 94111

CONSULTANT

Mayor ED 17-02 Priority permit

ГАМР

NOT FOR CONSTRUCTION

REVISION NO. DATE

KEY PLAN - (NTS)

TRUE PLAN NORTH

PIER 70

BrookfieldProperties

BROOKFIELD PROPERTIES PIER 70 PARCEL A

PROJECT NUMBER
1830
DATE
JULY 12, 2019

SCALE
1/4" = 1'-0"

DRAWING TITLE

ENLARGED SECTIONS

SHEET NUMBER

A-310.3







2 VIEW FROM SE CORNER
NO SCALE

ARCHITEC

HACKER

733 SW Oak, Portland, OR 97205

QA

639 FRONT ST, SAN FRANCISCO, CA 94111

CONSULTANT

Mayor ED 17-02 Priority permit

STAMP

NOT FOR CONSTRUCTION

DATE

REVISION NO.

KEY PLAN - (NTS)

TRUE PLAN NORTH

PIER 70

Brookfield

Properties

BROOKFIELD PROPERTIES PIER 70 PARCEL A

ISSUANCE DESIGN REVIEW PACKAGE

PROJECT NUMBER

DATE JULY 12, 2019


SCALE 1" = 40'-0"

DRAWING TITLE
PERSPECTIVE VIEWS

SHEET NUMBER



4 VIEW FROM MARYLAND LOOKING NORTH
A-602 NO SCALE

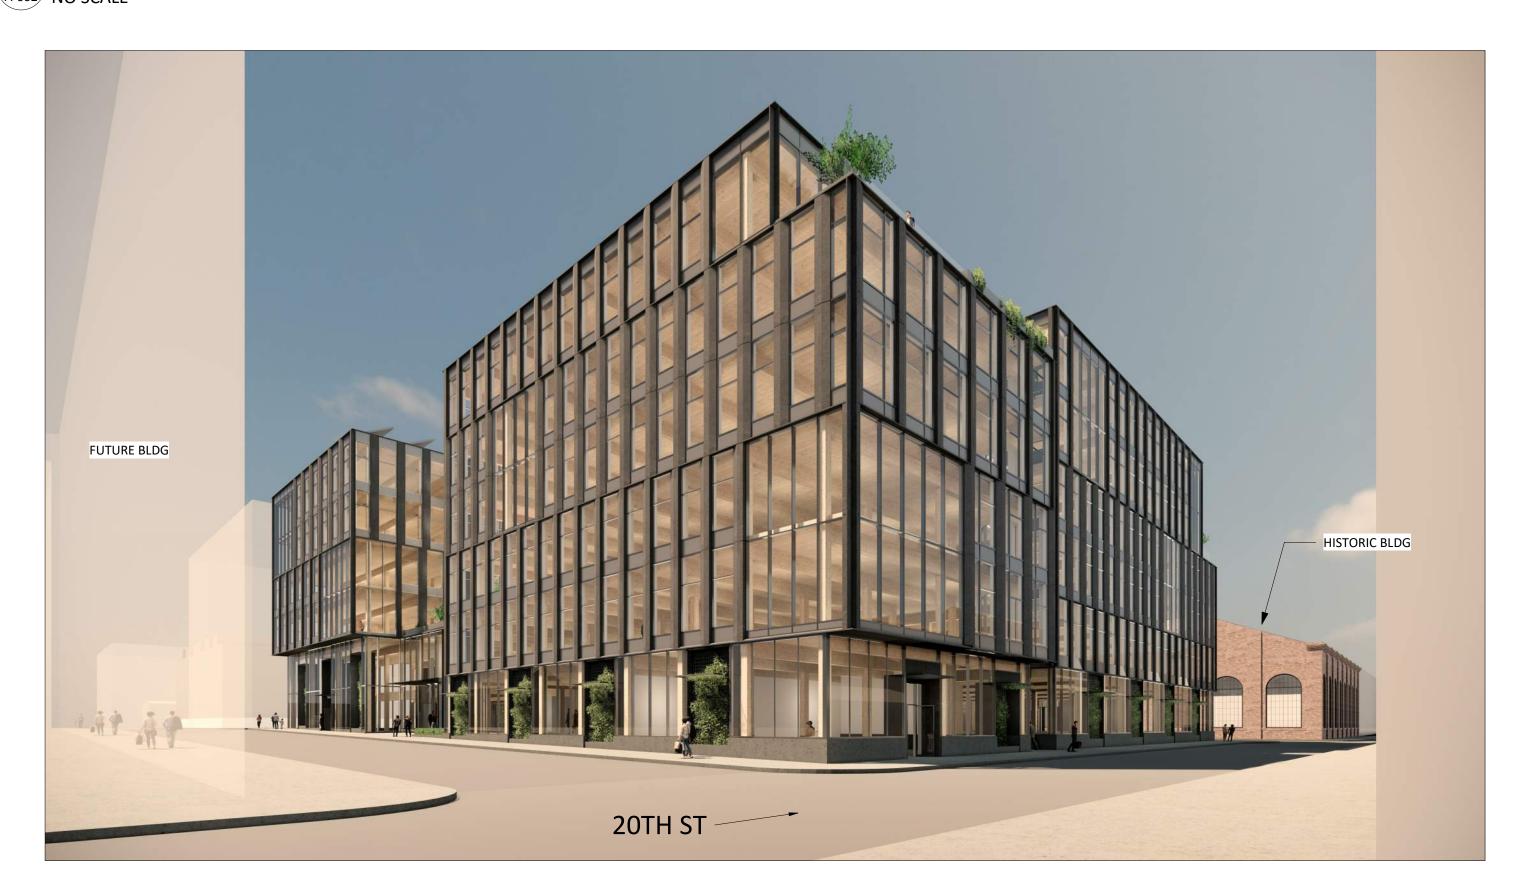

5 VIEW FROM 20TH LOOKING SOUTHWEST
A-602 NO SCALE




6 VIEW FROM 21ST LOOKING EAST A-602 NO SCALE



1 VIEW FROM 21ST LOOKING WEST NO SCALE



2 VIEW FROM LOUISIANA LOOKING SE A-602 NO SCALE

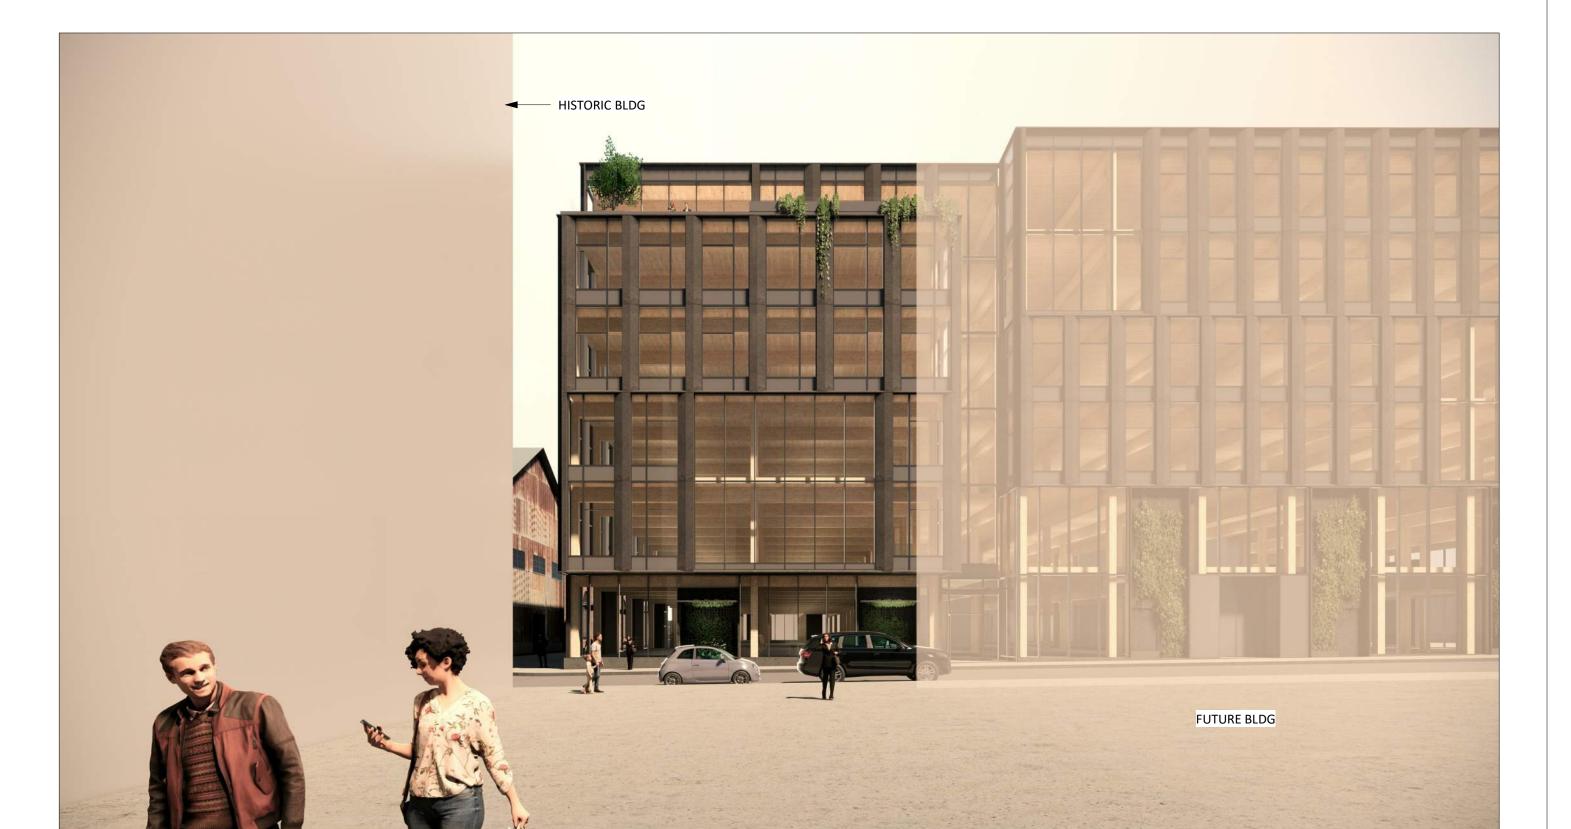

3 VIEW FROM MARKET SQUARE LOOKING NORTH TOWARD 21ST ST A-602 NO SCALE

733 SW Oak, Portland, OR 97205

QA

639 FRONT ST, SAN FRANCISCO, CA 94111

CONSULTANT

Mayor ED 17-02 Priority permit

NOT FOR CONSTRUCTION

REVISION NO.

KEY PLAN - (NTS)

TRUE PLAN NORTH

PIER 70

Brookfield Properties

BROOKFIELD PROPERTIES PIER 70 PARCEL A

DESIGN REVIEW PACKAGE

PROJECT NUMBER

DATE JULY 12, 2019 SCALE NO SCALE

DRAWING TITLE PERSPECTIVE VIEWS

SHEET NUMBER