### **Letter of Determination**

Suite 400 San Francisco, CA 94103-2479

1650 Mission St.

Reception: 415.558.6378

Planning Information:

Fax: 415.558.6409

415.558.6377

September 22, 2017

Laura Meiners SureSite Consulting Group for Sirius XM 43251 Osgood Road Fremont, CA 94539

**Site Address:** 

1101 Green Street and 400 Beale Street

Assessor's Block/Lot:

0125/026-089 and 3766/012-259

**Zoning District:** 

RH-3/40-X and RH DTR/65-X

**Staff Contact:** 

Stephanie Skangos - (415) 575-8731 or Stephanie.Skangos@sfgov.org

Record Number: 2017-009245ZAD

Dear Ms. Meiners:

This letter is in response to your request for a Letter of Determination (LOD) as to whether two (2) new Sirius XM Wireless Telecommunication Services (WTS) Facilities proposed for 1101 Green Street and 400 Beale Street can be considered Micro WTS Facilities, pursuant to Planning Code Section 102.

The proposed facility at 1101 Green Street would consist of the following: (a) one panel antenna, measuring 39.5" tall by 6.5" wide by 8.0" deep; (b) one VSAT dish, measuring 70.9" in diameter; (c) one RX dish, measuring 26" in diameter; and (d) one equipment cabinet, measuring 80.26" tall by 34.6" wide by 31.5" deep. The proposed facility at 400 Beale Street would consist of the same equipment except that the proposed VSAT dish would be smaller at this location, measuring 39.4" in diameter instead of 70.9" in diameter.

On August 2, 2016, the Board of Supervisors adopted Ordinance No. 16-166 (Planning Code - Wireless Telecommunications Services Facilities) which, among other things, amended the Planning Code to add "Micro WTS Facilities" as a use category which is principally permitted in all zoning districts subject to specific limitations. Micro WTS Facilities are defined as follows:

Wireless Telecommunications Services (WTS) Facility, Micro. The Zoning Administrator shall determine whether a proposed WTS Facility is a Micro WTS Facility. A Micro WTS Facility is generally characterized by

- (a) limited spatial effects;
- (b) a small number of antennas (typically up to two);
- (c) an absence of substantial cumulative effects on neighborhood character or aesthetics, when considered in conjunction with other WTS Facilities at the same project site; and
  - (d) a location that is not "disfavored" as specified in the Guidelines.

After reviewing previous determinations, relevant Planning Code provisions, existing guidelines and the information submitted with your letter, it is my determination that the proposed Sirius XM WTS facilities at 1101 Green Street and 400 Beale Street would not be consistent with the definition of Micro WTS Facilities based upon the following:

- 1. The size, number and function of the proposed equipment are similar to that of a Macro WTS Facility, when considered in conjunction with other WTS Facilities in similar adjacent areas.
  - a. The size of the proposed equipment, specifically the proposed dishes, is larger than the accessory dishes typically included as part of a WTS facility and will have more than a limited spatial effect on the project sites.
  - b. The proposed facility includes one (1) panel antenna; however, the panel antenna is not the only transmitting element of the proposed facility. The VSAT dish functions similar to an antenna and also transmits and receives; and, while, the proposed RX dish receives only, the potential overall impact of the equipment as a whole is more similar to that of a Macro WTS Facility.
- 2. Additionally, the project site at 1101 Green Street is located within an RH-3 Zoning District, which has been identified as a "Disfavored Site," per the WTS Facilities Siting Guidelines.

Please note that a Letter of Determination is a determination regarding the classification of uses and interpretation and applicability of the provisions of the Planning Code. This Letter of Determination is not a permit to commence any work or change occupancy. Permits from appropriate Departments must be secured before work is started or occupancy is changed.

**APPEAL**: If you believe this determination represents an error in interpretation of the Planning Code or abuse in discretion by the Zoning Administrator, an appeal may be filed with the Board of Appeals within 15 days of the date of this letter. For information regarding the appeals process, please contact the Board of Appeals located at 1650 Mission Street, Room 304, San Francisco, or call (415) 575-6880.

Sincerely,

Scott F. Sanchez

Zoning Administrator

cc: Property Owners

Russian Hill and SoMa Neighborhood Group Mailing Lists

Stephanie Skangos, Planner



R#12017-009245ZAD CK# 19729 \$664.-A. LINDSAY (WIRELESS)

Sirius XM Radio Inc. 1221 Avenue of Americas New York, New York, 10020

T: 222-584-5100 F: 212-584-5200 siriusxm.com

### RECEIVED

July 13, 2017

Office of the Zoning Administrator 1650 Mission Street, Suite 400 San Francisco, CA 94103 JUL 1 9 2017

CITY & COUNTY OF S.F.
DEPT. OF CITY PLANNING
ADMINISTRATION

Reference: Request for Letter of Determination for two (2) projects, Applicant Sirius XM:

Project Site Address: 1101 Green Street (Sirius XM SFX501S)

Block/Lot: 0125/026-089

Building Permit Application Number: 2016.11.10.2496

Zone: RH-3

Project Site Address: 400 Beale Street (Sirius XM SFX502T)

Block/Lot: 3766/012-259

Building Permit Application Number: 2017.04.28.5180

Zone: RH-DTR

#### Zoning Administrator,

Per Notice of Planning Department Requirements letters dated December 8, 2016 and May 22, 2017, please find this Request for a Letter of Determination (LOD) to determine whether each of the above referenced projects is a micro wireless facility or a macro wireless facility. Please also find copies of the submitted plans enclosed to assist you in your review.

#### The 1101 Green Street scope of work includes:

- Install (1) new Sirius XM panel antenna on existing penthouse (antenna dimensions: 39.5" x 8")
- Install (1) new Sirius XM VSAT dish on existing penthouse (VSAT diameter: 70.9")
- Install (1) new Sirius XM RX dish on existing penthouse (RX dish diameter: 26")
- Install (1) new Sirius XM cabinet and equipment platform on existing rooftop (dimensions 6' x 4')

#### The 400 Beale Street scope of work is very similar:

- Install (1) new Sirius XM panel antenna on existing rooftop (antenna dimensions: 39.5" x 8")
- Install (1) new Sirius XM VSAT dish on existing rooftop (VSAT diameter: 39.4")
- Install (1) new Sirius XM RX dish on existing rooftop (RX dish diameter: 26")
- Install (1) new Sirius XM cabinet and equipment platform on existing rooftop (dimensions 6' x 4')



Sirius XM Radio Inc. 1221 Avenue of Americas New York, New York, 10020

T: 222-584-5100 F: 212-584-5200 siriusxm.com

The only difference in the scope is a smaller VSAT dish proposed on the Beale Street site. Please also review the plans that were submitted with the application if you have any additional questions regarding what is being proposed.

Thank you for your review of these projects. Please provide Letters of Determination for both sites at your earliest convenience. Please let me know if you have any further questions or if you need any additional information to complete your review.

Sincerely,

Laura Meiners

SureSite Consulting Group for Sirius XM

l.meiners@sure-site.com

949-278-2962

#### SHEET INDEX DESCRIPTION NO. T-I TITLE SHEET T-2 GENERAL NOTES C-I SITE PLAN C-IA ROOF PLAN C-2 ENLARGED EQUIPMENT LAYOUT C-3 SITE ELEVATION C-4 ANTENNA LAYOUTS ANTENNA DETAILS C-5A SITE DETAILS C-6 ANTENNA SCHEDULES C-1 EQUIPMENT SPECS C-1A EQUIPMENT PLATFORM DETAILS UTILITY PLAN AT ROOF LEVEL AND NOTES E-IA UTILITY PLAN AT 20TH FLOOR FINAL SINGLE LINE DIAGRAM/PANEL SCHEDULE F-3 GROUNDING DETAILS AND NOTES E-4 SITE CONFIGURATIONS MATERIAL LIST E-4A SITE CONFIGURATIONS MATERIAL LIST SITE CONFIGURATIONS MATERIAL LIST

#### DRIVING DIRECTIONS

FROM: SAN FRANCISCO INTERNATIONAL AIRPORT DEPART SAN FRANCISCO INTERNATIONAL AIRPORT, TAKE RAMP (LEFT) ONTO US-101/BAYSHORE FWY, KEEP RIGHT ONTO I-80/JAMES LICK SKWY, AT EXIT I, TURN RIGHT ONTO RAMP, BEAR LEFT (NORTH-WEST) ONTO 1TH ST, ROAD NAME CHANGES TO CHARLES J BRENHAM PL/1TH ST N, BEAR LEFT (WEST) ONTO MCALLISTER ST, THEN IMMEDIATELY TURN RIGHT (NORTH) ONTO LEAVENWORTH ST, ARRIVE AT SITE



SITE NAME

GREEN STREET

SITE I.D.

SFX501S


SITE ADDRESS

1101 GREEN ST SAN FRANCISCO, CA 94109

STRUCTURE TYPE

ROOFTOP

### PROJECT TEAM

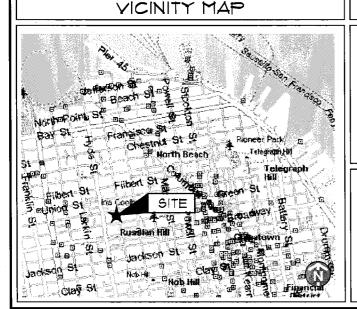

BUILDING C DANBURY, CT 06810

PROJECT MANAGER/

SITE ACQUISITION

**FULLERTON** 

1100 F WOODFIFLD ROAD, SUITE 500 SCHAUMBURG, ILLINOIS 60173 TEL: 847-908-8400 www.FullertonEngineering.com

#### ENGINEER

#### CODE COMPLIANCE: HANDICAP ACCESS REQUIREMENTS ARE NOT

- FACILITY IS UNMANNED AND NOT FOR HUMAN
- FACILITY HAS NO PLUMBING OR REFRIGERANTS
- THIS FACILITY SHALL MEET OR EXCEED ALL FAA AND FCC REGULATORY REQUIREMENTS

#### SCOPE OF WORK:

- INSTALL (1) NEW SIRIUS XM PANEL ANTENNA ON EXISTING PENTHOUSE
- . INSTALL NEW SIRIUS XM VSAT DISH ON EXISTING PENTHOUSE
- . INSTALL NEW SIRIUS XM RX DISH ON EXISTING PENTHOUSE
- INSTALL NEW SIRIUS XM CABINET AND EQUIPMENT PLATFORM ON EXISTING ROOFTOF
- ALL NEW MATERIAL SHALL BE FURNISHED AND INSTALLED BY CONTRACTOR UNLESS NOTED OTHERWISE. CABINETS, ANTENNAS AND CABLES FURNISHED BY OWNER AND INSTALLED BY CONTRACTOR

#### PROJECT SUMMARY

SITE NAME: GREEN STREET

SITE NO: SEXSOIS

IIØI GREEN ST SITE ADDRESS:

SAN FRANCISCO, CA 94109

SAN FRANCISCO COUNTY:

SITE COORDINATES

37.797969° (NAD 83) LATITUDE: LONGITUDE: -122.417469\* (NAD 83) (AMSI) GROUND ELEVATION: 300

CITY OF SAN FRANCISCO JURISDICTION: ZONING:

APPLICANT: SIRIUS XM

1500 ECKINGTON PL NE WASHINGTON, DC 20002 TEL: (202) 380-4151 FAX: (202) 380-4570

LANDLORD:

CONST.

LANDLORD

OCCUPANCY TYPE: CONSTRUCTION TYPE:

2013 CALIFORNIA ADMINISTRATIVE CODE

CALIFORNIA BUILDING CODE (IBC 2012) CALIFORNIA ELECTRICAL CODE (2011 NEC)

CALIFORNIA MECHANICAL CODE (2012 UMC)

CALIFORNIA ENERGY CODE CALIFORNIA FIRE CODE (2012 IFC)

2013 CALIFORNIA GREEN CODE

CALIFORNIA REFERENCES STANDARDS CODE

CITY/COUNTY ZONING ORDINANCES

#### CERTIFICATION STATEMENT

I HEREBY CERTIFY THAT THESE DRAWING WERE PREPARED BY ME OR UNDER MY DIRECT SUPERVISION AND CONTROL, AND TO THE BEST OF MY KNOWLEDGE AND BELIEF COMPLY WITH THE REQUIREMENTS OF ALL APPLICABLE CODES.



APPROVALS

DRAWING SCALED TO 11"x17"

#### GREEN STREET

DATE

DATE

DATE

DATE

SITE ID.

SITE NAME

(Sirius XM))

22 SHELTER ROCK LN.

BUILDING C

DANBURY, CT 06810

LION E WOODFIELD ROAD, SUITE 500 SCHAUMBURG, ILLINOIS 60173

TEL: 847-908-8400

www.FullertonEngineering.com

DESCRIPTION

90% REVIEW

FNAL

REVISION

CHECKED BY: AG

APPROVED BY: MB

DATE

9/9/16

B 9/20/16

0 9/26/16

SFX5ØIS

SITE ADDRESS

IIDI GREEN ST SAN FRANCISCO, CA 94109

SHEET NAME

TITLE SHEET

SHEET NUMBER

PROJECT# 2015.0042.0022

#### GENERAL CONSTRUCTION NOTES:

- I. THIS SET OF PLANS HAS BEEN PREPARED FOR THE PURPOSES OF MUNICIPAL AND AGENCY REVIEW AND APPROVAL.
- THESE PLANS ARE INTENDED TO BE USED TO DIRECT THE PROPOSED LAYOUT.
  DRAWINGS SHOULD NOT BE SCALED UNLESS OTHERWISE NOTED. PLANS,
  ELEVATIONS AND DETAILS ARE INTENDED TO SHOW THE END RESULT OF
  DESIGN. MINOR MODIFICATIONS MAY BE REQUIRED TO SUIT JOB DIMENSIONS OR
  CONDITIONS.
- THE CONTRACTOR SHALL VERIFY ALL DIMENSIONS AND CONDITIONS AND NOTIFY THE PROJECT MANAGER OF ANY DISCREPANCIES BEFORE STARTING ANY ILDERK
- 4. ALL EQUIPMENT AND MATERIALS SHALL BE INSTALLED IN ACCORDANCE WITH THE MANUFACTURER'S RECOMMENDATIONS UNLESS OTHERWISE NOTED BY THE ENGINEER OF RECORD.
- 5. CONTRACTOR SHALL BE RESPONSIBLE FOR ALL WORK PERFORMED AND MATERIALS INSTALLED TO BE IN STRICT COMPORTANCE, AS A MINIMUM STANDARD, WITH ALL APPLICABLE CODES, REGULATIONS AND ORDINANCES HAVING JURISDICTION ELECTRICAL SYSTEMS SHALL BE INSTALLED IN COMPORTMANCE WITH THE NATIONAL ELECTRICAL CODE, AND WITH LOCAL AND STATE JURISDICTIONAL CODES, ORDINANCES, AND WITH LOCAL UTILITY COMPANY SPECIFICATIONS, WHICHEVER IS MORE STRINGENT.
- 6. THE CONTRACTOR SHALL KEEP CONTRACT AREA CLEAN, HAZARD FREE AND DISPOSE OF ALL DIRT, STUMPS, STONES, RUBBISH OR DEBRIS IN ACCORDANCE WITH ALL LOCAL AND ENVIRONMENTAL LAWS. NO MATERIALS OR EQUIPMENT SHALL BE PLACED ANYWHERE ON OR IN THE STRUCTURE WITHOUT MAKING ADEQUATE PROVISIONS TO PROTECT EXISTING PROPERTY. UPON COMPLETION, REPAIR ANY DAMAGE THAT MAY HAVE OCCURRED DURING CONSTRUCTION REPAIR ALL EXISTING WALL SURFACES DAMAGED DURING CONSTRUCTION SUCH THAT THEY MATCH AND BLEND WITH ADJACENT SURFACES.
- THE CONTRACTOR SHALL BE SOLELY RESPONSIBLE AND HAVE CONTROL OVER CONSTRUCTION MEANS, METHODS, TECHNIQUES, SEQUENCES, AND PROCEDURES.

#### WARRANTIES AND BONDS:

- THE CONTRACTOR SHALL GUARANTEE ALL LABOR AND MATERIALS USED IN THIS PROJECT FOR A MINIMUM PERIOD OF ONE (1) YEAR CONTRACTOR IS NOT THE DATE OF FINAL ACCEPTANCE BY THE CLIENT. THE CONTRACTOR IS NOT REQUIRED TO GUARANTEE MATERIAL SUPPLIED BY THE OWNER.
- FINAL DATE OF ACCEPTANCE IS DEEMED AS THE DATE THAT ALL REQUIRED STATE AND FEDERAL APPROVAL HAVE BEEN OBTAINED INCLUDING, BUT NOT LIMITED TO:
  - A. FINAL INSPECTION- DI4
- B. CERTIFICATE OF OCCUPANCY
- ANY DEFICIENCIES THAT COME EVIDENT DURING THIS ONE (1) YEAR PERIOD SHALL BE CORRECTED BY THE CONTRACTOR AT THE CONTRACTOR'S EXPENSE.

#### DELIVERY, STORAGE AND HANDLING:

- L THE CONTRACTOR SHALL BE RESPONSIBLE FOR ALL PROCEDURES AND SCHEDULING ASSOCIATED WITH HOISTING, STAGING, AND ERECTING OF MATERIALS AND EQUIPMENT TO AND/OR UPON THE SITE.
- ALL ELEMENTS OF THE EXISTING SITE, I.E. STRUCTURES, SITE PLANTINGS, ETC.
   SHALL BE PROTECTED AS NECESSARY FROM SAID ACTIONS. THIS WORK MUST
   BE DONE IN A SAFE, SECURE NONDESTRUCTIVE MANNER FOR PROTECTING
   PERSONNEL AND PROPERTY.

#### SITE WORK GENERAL NOTES:

- THIS SET OF PLANS HAS BEEN PREPARED FOR THE PURPOSES OF MUNICIPAL AND AGENCY REVIEW AND APPROVAL.
- THESE PLANS ARE INTENDED TO BE USED TO DIRECT THE PROPOSED LAYOUT.
  DRAWINGS SHOULD NOT BE SCALED UNLESS OTHERWISE NOTED. PLANS,
  ELEVATIONS AND DETAILS ARE INTENDED TO SHOW THE END RESULT OF
  DESIGN. MINOR MODIFICATIONS MAY BE REQUIRED TO SUIT JOB DIMENSIONS OR
  CONDITIONS.
- 3. THE CONTRACTOR SHALL VERIFY ALL DIMENSIONS AND CONDITIONS AND NOTIFY THE PROJECT MANAGER OF ANY DISCREPANCIES BEFORE STARTING ANY WORK.
- 4. ALL EQUIPMENT AND MATERIALS SHALL BE INSTALLED IN ACCORDANCE WITH THE MANUFACTURER'S RECOMMENDATIONS UNLESS OTHERWISE NOTED BY THE ENGINEER OF RECORD.
- 5. CONTRACTOR SHALL BE RESPONSIBLE FOR ALL WORK PERFORMED AND MATERIALS INSTALLED TO BE IN STRICT CONFORMANCE, AS A MINIMUM STANDARD, WITH ALL APPLICABLE CODES, REGULATIONS AND ORDINANCES HAVING JURISDICTION. ELECTRICAL SYSTEMS SHALL BE INSTALLED IN CONFORMANCE WITH THE NATIONAL ELECTRICAL CODE, AND ALL OTHER LOCAL AND STATE JURISDICTIONAL CODES, ORDINANCES, AND WITH LOCAL UTILITY COMPANY SPECIFICATIONS, WHICHEVER IS MORE STRINGENT.
- 6. THE CONTRACTOR SHALL KEEP CONTRACT AREA CLEAN, HAZARD FREE AND DISPOSE OF ALL DIRT, STUMPS, STONES, RUBBISH OR DEBRIS IN ACCORDANCE WITH ALL LOCAL AND ENVIRONMENTAL LAWS. NO MATERIALS OR EQUIPMENT SHALL BE PLACED ANYWHERE ON OR IN THE STRUCTURE WITHOUT MAKING ADEQUATE PROVISIONS TO PROTECT EXISTING PROPERTY. UPON COMPLETION, REPAIR ANY DAMAGE THAT MAY HAVE OCCURRED DURING CONSTRUCTION SUCH THAT THEY MATCH AND BLEND WITH ADJACENT SURFACES.
- THE CONTRACTOR SHALL BE SOLELY RESPONSIBLE AND HAVE CONTROL OVER CONSTRUCTION MEANS, METHODS, TECHNIQUES, SEQUENCES, AND PROCEDURES.
- 8. THE CONTRACTOR SHALL CALL UTILITIES PRIOR TO THE START OF CONSTRUCTION.
- 9. ALL SITE WORK SHALL BE AS INDICATED ON THE DRAWING AND STIPULATED IN THE SPECIFICATION PROJECT SUMMARY.
- ID. IF NECESSARY, RUBBISH, STUMPS, DEBRIS, STICKS, STONES, AND OTHER REFUSE SHALL BE REMOVED FROM THE SITE AND DISPOSED OF LEGALLY.
- II. THE SITE SHALL BE GRADED TO CAUSE SURFACE WATER FLOW AWAY FROM THE EQUIPMENT SHELTER AND TOWER AREAS.
- 12. NO FILL OR EMBANKMENT MATERIAL SHALL BE PLACED ON PROZEN GROUND.
  PROZEN MATERIALS, SNOW OR ICE SHALL NOT BE PLACED IN ANY FILL OR
- THE SUB GRADE SHALL BE COMPACTED AND BROUGHT TO A SMOOTH UNIFORM GRADE PRIOR TO FINISHED SURFACE APPLICATION.
- 4. ALL EXISTING INACTIVE SEWER, WATER, GAS, ELECTRIC AND OTHER UTILITIES, WHICH INTERFERE WITH THE EXECUTION OF THE WORK, SHALL BE REMOVED AND/OR CAPPED, PLUGGED OR OTHERWISE DISCONTINUED AT POINTS WHICH WILL NOT INTERFERE WITH THE EXECUTION OF THE WORK, SUBJECT TO THE APPROVAL OF ENGINEERING.
- 15. THE AREAS OF THE OWNERS PROPERTY DISTURBED BY THE WORK AND NOT COVERED BY THE BUILDING OR DRIVEWAY, SHALL BE GRADED TO A UNIFORM SLOPE, FERTILIZED AND SEEDED.
- 16. CONTRACTOR SHALL MINIMIZE DISTURBANCE TO EXISTING SITE DURING CONSTRUCTION, EROSION CONTROL MEASURES, SHALL BE IN CONFORMANCE WITH THE LOCAL GUIDELINES FOR EROSION AND SEDIMENT CONTROL.
- II. ALL BACK FILL SHALL BE COMPACTED TO 95% MODIFIED PROCTOR DENSITY AS DETERMINED BY ASTM STANDARD TEST PROCEDURES.

#### CONSTRUCTION SPECIFICATIONS:

- THE CONTRACTOR SHALL VIGIT THE SITE OF THE PROPOSED WORK AND FULLY ACQUAINT THEMSELVES WITH THE CONDITIONS AS THEY EXIST IN ORDER THAT ANY RESTRICTIONS PERTAINING TO THE WORK ARE UNDERSTOD. ALL AREAS AND DIMENSIONS ARE INDICATED ON THE DRAWINGS AS ACCURATELY AS POSSIBLE, BUT ALL CONDITIONS SHALL BE VERIFIED BY EACH CONTRACTOR AND/OR SUBCONTRACTOR AT THE SITE. THE FAILURE OF THE CONTRACTOR TO EXAMINE OR RECEIVE ANY FORM, INSTRUMENT OR DOCUMENT, OR TO VISIT THE SITE SHALL NOT RELIEVE THE CONTRACTOR FROM ANY OBLIGATION WITH RESPECT TO THEIR QUOTED PRICE. THE SUBMISSION OF A QUOTATION SHALL ACKNOWLEDGE THAT THE CONTRACTOR AND THEIR SUBCONTRACTORS HAVE FULLY EXAMINED THE SITE AND KNOW THE EXISTING CONDITIONS AND HAVE THE SITE AND FOR OPERATING UNDER THE CONDITIONS AS THEY EXIST AT THE SITE AND HAVE INCLUDED ALL NECESSARY ITEMS.
- THE GENERAL CONTRACTOR'S RESPONSIBILITIES SHALL INCLUDE, BUT NOT BE LIMITED TO, CONSTRUCTION OF THE EQUIPMENT FOUNDATION, INCLUDING ELECTRICAL SERVICE, TELEPHONE CONDUITS, GROUNDING SYSTEM AND COORDINATION WITH LOCAL UTILITY COMPANIES.
- 3. THE ANTENNA INSTALLERS RESPONSIBILITIES SHALL INCLUDE, BUT NOT BE LIMITED TO, CABLE TRAY INSTALLATION, ROUTING OF CABLES FROM RADIO EQUIPMENT TO ANTENNAS, ASSOCIATED HARDWARE FOR SECURING ANTENNA CABLES, ANTENNA MOUNTS, DETERMINING SUPPLIER OF ANTENNAS, GROWNDING OF ANTENNAS TO GROWNDING SYSTEM, INSTALLING ANTENNAS AND VERIFYING WITH RADIO FREQUENCY ENGINEERS, THE ALIGNMENT, LOCATION, AND PROPER ORIENTATION OF ANTENNAS.
- THE CONTRACTORS SHALL COORDINATE CONSTRUCTION ACTIVITIES WITH THE BUILDING LANDLORD IN ORDER TO AVOID CONFLICTS WITH CURRENT USE OF THE SITE.
- THE CUNER MAY HAVE WORK PERFORMED UNDER SEPARATE CONTRACTS, CONCURRENTLY, WITH THE WORK OF THIS CONTRACT.
- THE GENERAL CONTRACTOR SHALL PERMIT ACCESS TO THE PROJECT TO THESE CONTRACTORS TO PERFORM THEIR WORK.
- CONTRACTOR SHALL CONFORM TO ALL APPLICABLE LOCAL, COUNTY, 6TATE, AND FEDERAL CODES, LAUS AND REQUIREMENTS, INCLUDING 0SHA.
- 8. THE CONTRACTOR SHALL APPLY AND PAY FOR THE CONSTRUCTION PERMIT, CERTIFICATE OF OCCUPANCY AND ALL OTHER REGUIRED PERMITS OR LICENSES. THE CONTRACTOR IS RESPONSIBLE FOR OBTAINING ALL DISSECTIONS
- 9. CARE SHALL BE EXERCISED IN PROTECTING THE BUILDING OCCUPANTS DURING THE DEMOLITION AND CONSTRUCTION PERIODS OF THIS PROJECT. EYERY EFFORT SHALL BE MADE TO MAINTAIN A CLEAN OPERATION. DEBRIG SHALL NOT ACCUMULATE. ALL DEBRIG WILL BE DEPOSITED IN A SUITABLE CONTAINER ON A DAILY BASIS AND SHALL BE EMPTIED ON A REGULAR SCHEDULE. THE LOCATION OF THE CONTAINER SHALL BE COORDINATED WITH THE BUILDING MANAGER.
- 2. SAFETY PROCEDURES: ATTENTION IS DIRECTED TO FEDERAL, STATE, AND LOCAL LAWS, RULES AND REGULATIONS CONCERNING CONSTRUCTION SAFETY AND HEALTH STANDARDS. THE CONSTRUCTION COMPANY AUMARDED THIS PROJECT SHALL ENSURE ALL WORKING SURROUNDINGS AND CONDITIONS ARE SANITARY AND ARE NOT HAZARDOUS OR DANGEROUS TO THE HEALTH OR SAFETY OF THE WORK CREWS OR BUILDING OCCUPANTS. PRECAUTION SHALL BE EXERCISED AT ALL TIMES FOR THE PROTECTION OF PERSONS AND PROPERTY. IT IS MANDATORY THAT THE SAFETY PROVISIONS OF APPLICABLE LOCAL LAWS, OSHA REGULATIONS AND BUILDING AND CONSTRUCTION CODES, BE OBSERVED FOR ALL CONTRACTORS AND ANTENNA RIGGERS.
- II. THE GENERAL CONTRACTOR MUST COORDINATE ALL ROOF RELATED WORK WITH THE LANDLORD'S PRE-APPROVED ROOFER THE GENERAL CONTRACTOR MUST CONFIRM THE COMPATIBILITY OF ALL MATERIALS AND ENSURE THAT ALL EXISTING ROOF WARRANTIES, IF ANY, REMAIN IN EFFECT.

## ((Sirius XM))



22 SHELTER ROCK LN. BUILDING C DANBURY, CT 06810

## FULLERTON ENGINEERING DESIGN

1100 E. WOODFIELD ROAD, SUITE 500 SCHAUMBURG, ILLINOIS 60173 TEL: 847-908-8400 www.FullertonEngineering.com

СН	ECKED BY:	AG:	
ΑP	PROVED BY:	MB	
#	DATE	DESCRIPTION	INT.
Α	9/9/16	90% REVIEW	MC
В	9/20/16	REVISION	8
0	9/26/16	FINAL	GT
П			ļ
Г			
П			
		_	
Г			
Г			
Г		·	Γ
Г			
_			



SITE NAME

GREEN STREET

SITE I.D.

SFX5Ø1S

SITE ADDRESS


IIOI GREEN ST SAN FRANCISCO, CA 94109


SHEET NAME

GENERAL NOTES

SHEET NUMBER

PROJECT# 2015.0042.0022

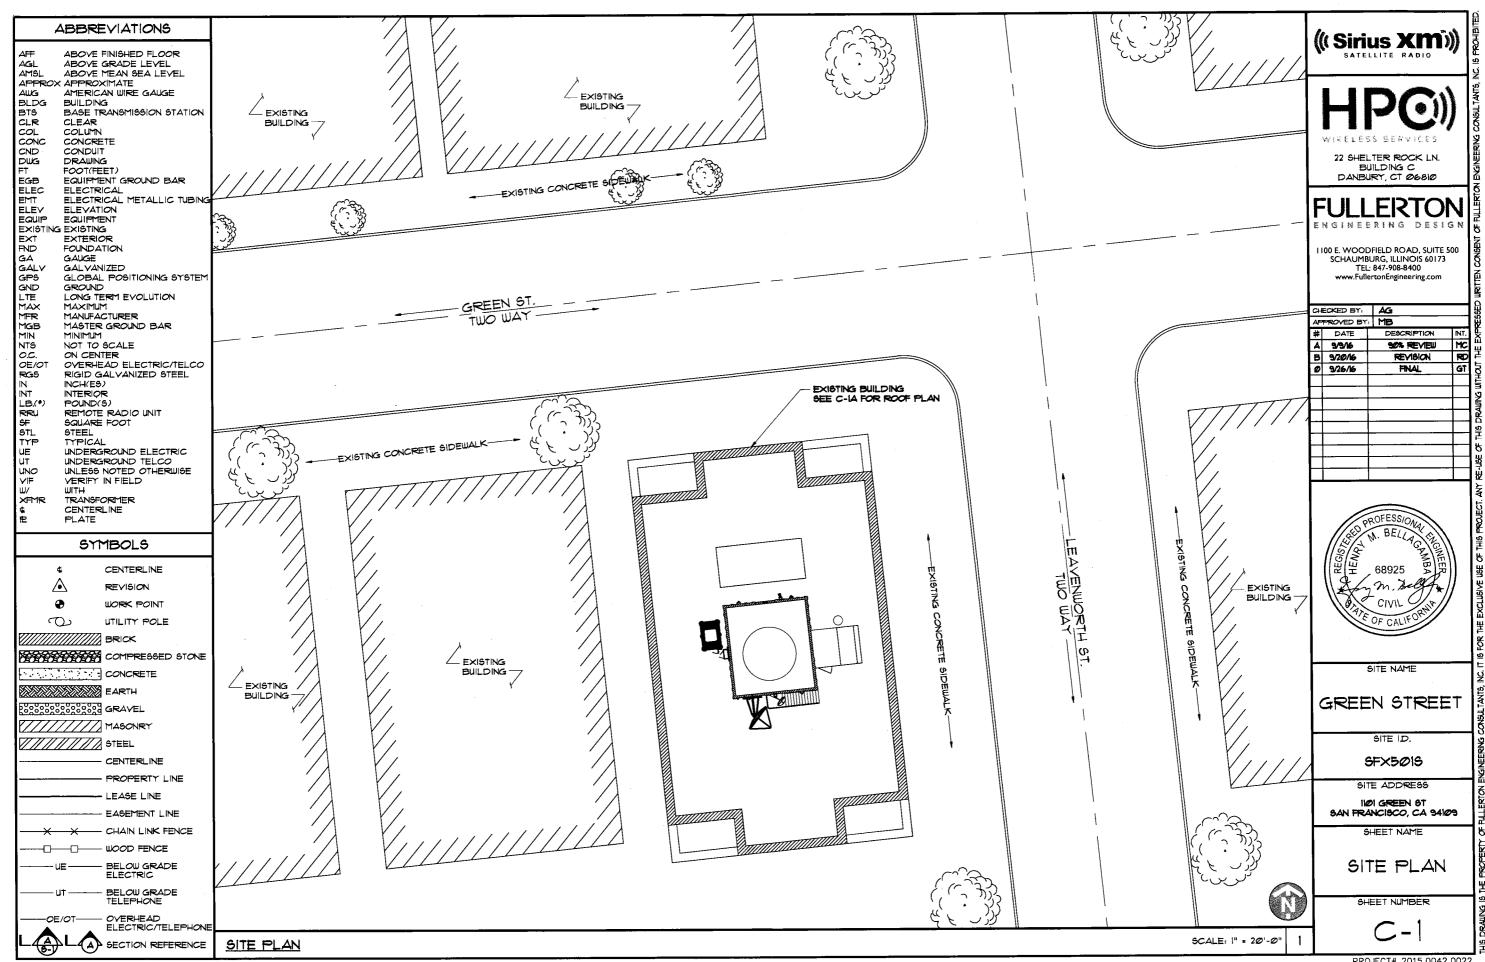

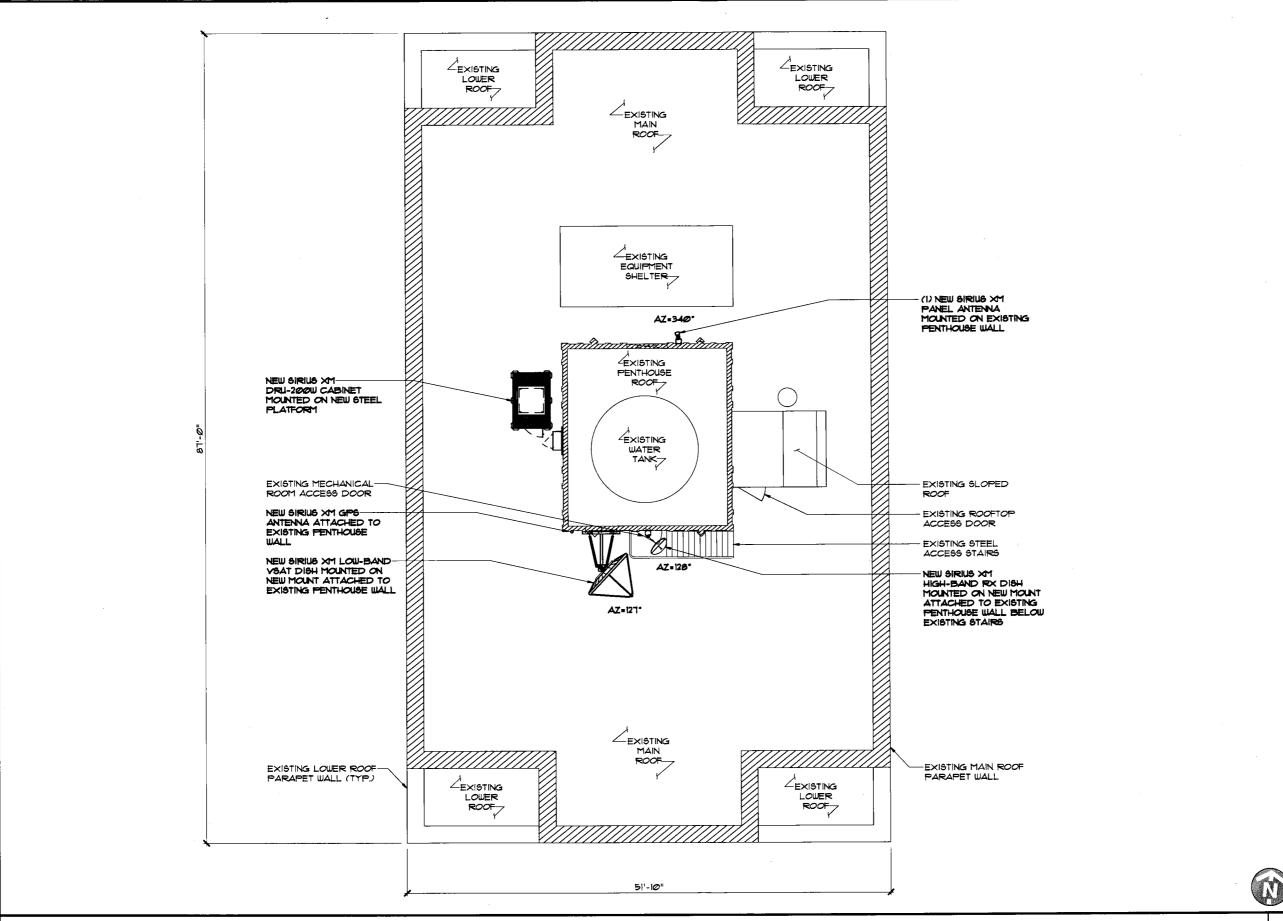

ROOF PLAN

(( Sirius XM))

HPO)

22 SHELTER ROCK LN. BUILDING C DANBURY, CT 06810

## FULLERTON ENGINEERING DESIGN

I 100 E. WOODFIELD ROAD, SUITE 500 SCHAUMBURG, ILLINOIS 60173 TEL: 847-908-8400 www.FullertonEngineering.com

а	ECKED BY.	AG	
ΑF	PROVED BY	MB	
#	DATE	DESCRIPTION	INT.
A	9/9/16	90% REVIEW	7
В	9/20/16	REYISION	Ä
Ø	9/26/16	FINAL	GT
			Π
Г			
Г			
Г			Т
_			$\overline{}$



SITE NAME

GREEN STREET

SITE I.D.

SFX5Ø1S

SITE ADDRESS

IIØI GREEN 6T SAN FRANCISCO, CA 94109


SHEET NAME

ROOF PLAN

SHEET NUMBER

C-1A

SCALE 1" = 10'-0"

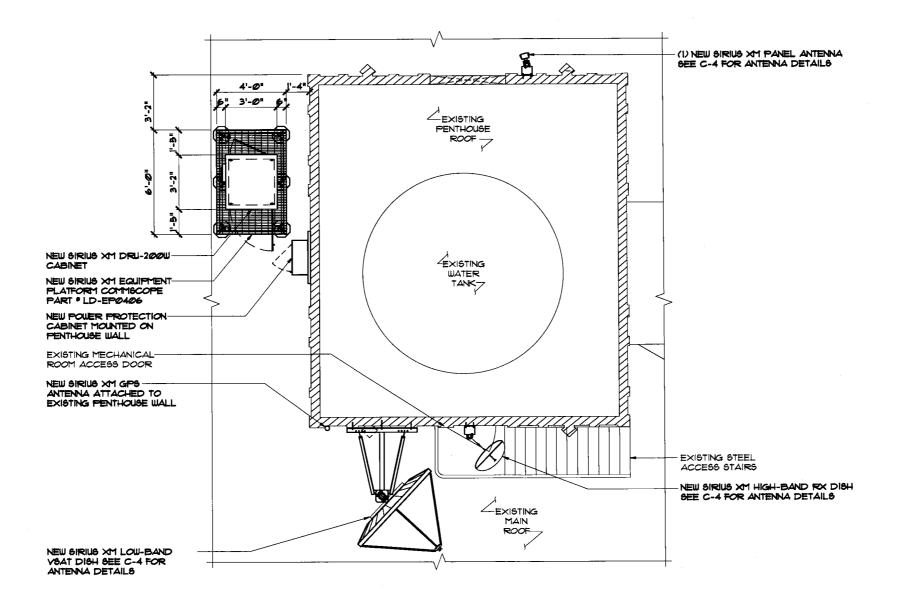






22 SHELTER ROCK LN. BUILDING C DANBURY, CT 06810

#### FULLERTON ENGINEERING DESIGN

1100 E. WOODFIELD ROAD, SUITE 500 SCHAUMBURG, ILLINOIS 60173 TEL: 847-908-8400 www.FullertonEngineering.com

CH	ECKED BY:	AG	
APPROVED BY:		MB	
#	DATE	DESCRIPTION	INT.
A	9/9/6	90% REVIEW	MC
В	9/20/16	REVISION	RO
0	9/26/16	FINAL	GT
			7
_			$\top$
$\Box$			
$\neg$			┪
			$\top$
Н			$\top$
Н		-	+
Н			+

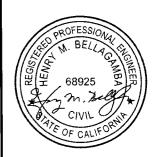

SITE NAME

GREEN STREET

SITE ID.

SFX5Ø1S

SITE ADDRESS

IIØI GREEN 6T SAN FRANCISCO, CA 94109


SHEET NAME

ENLARGED EQUIPMENT LAYOUT

SHEET NUMBER

C-2

SCALE: 3/16" = 1'-0"

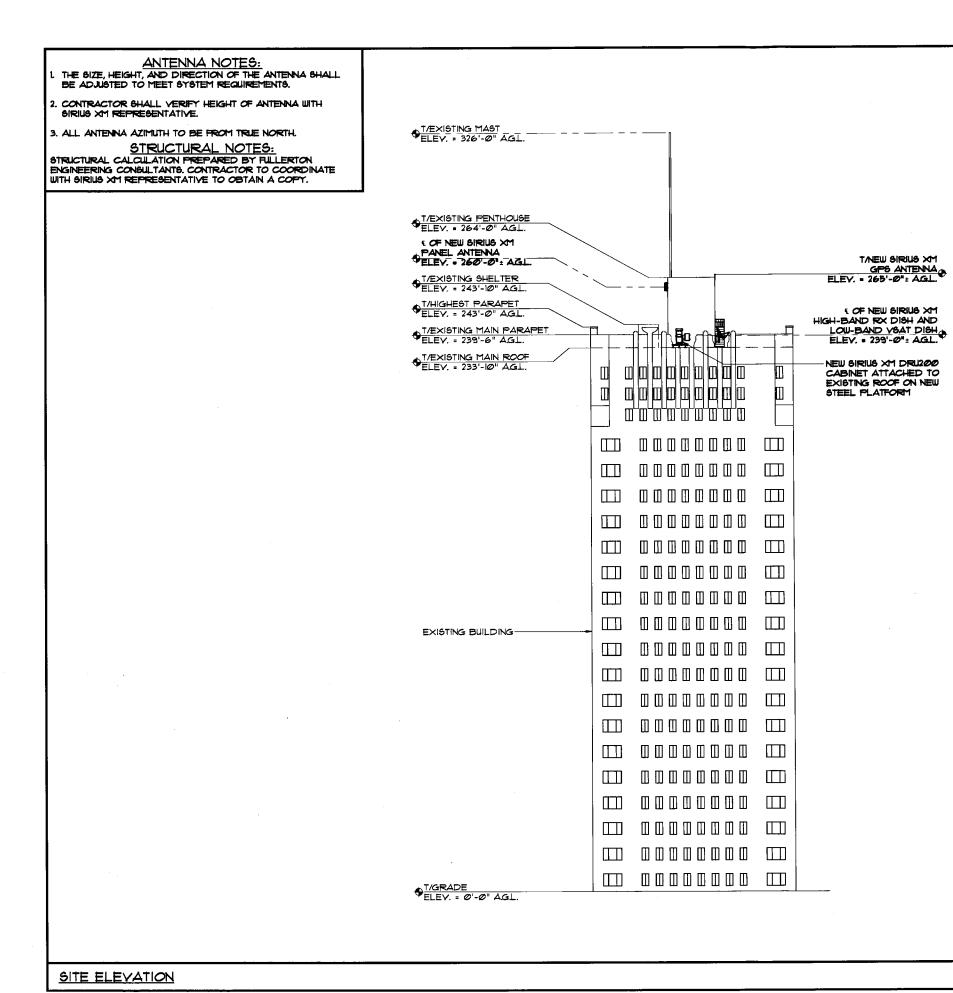

((Sirius XM))



22 SHELTER ROCK LN. BUILDING C DANBURY, CT 06810

#### **FULLERTON** ENGINEERING DESIGN

1100 E. WOODFIELD ROAD, SUITE 500 SCHAUMBURG, ILLINOIS 60173 TEL: 847-908-8400 www.FullertonEngineering.com

CH	ECKED BY:	AG	
ΑP	PROVED BY:	MB	
#	DATE	DESCRIPTION	INT.
A	9/9/16	90% REVIEW	MC
В	9/20/16	REVISION	RD
0	9/26/16	FINAL	GT
			l
		· · · · · · · · · · · · · · · · · · ·	
П			
Г			T
			T
П		<del></del>	1
-			



SITE NAME

GREEN STREET

SITE ID.

SFX5Ø1S

SITE ADDRESS


1101 GREEN 6T SAN FRANCISCO, CA 94109

SHEET NAME

SITE ELEVATION

SHEET NUMBER

SCALE: N.T.S.

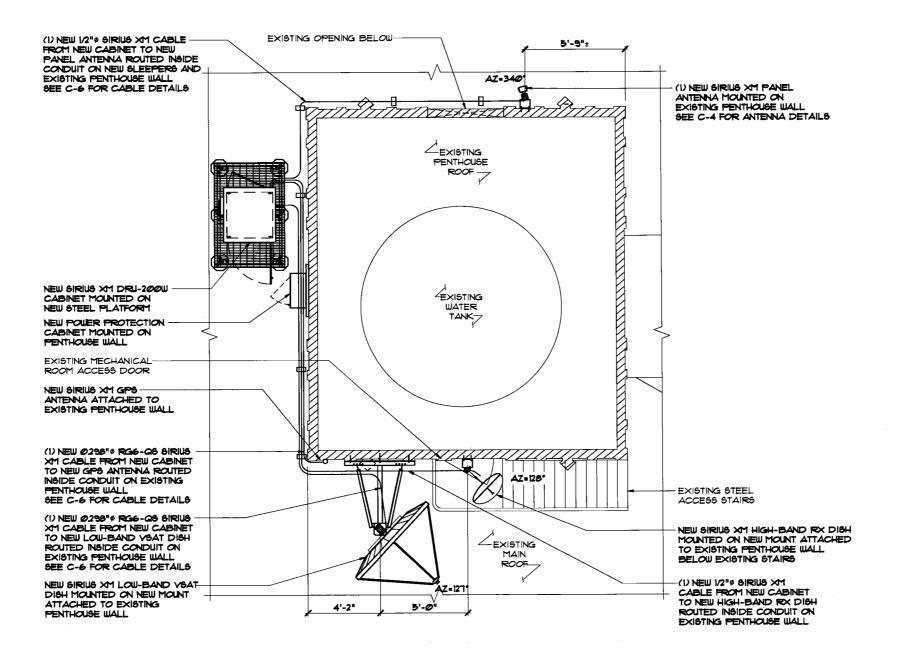

ANTENNA LAYOUT





22 SHELTER ROCK LN. BUILDING C DANBURY, CT 06810

### FULLERTON

I 100 E. WOODFIELD ROAD, SUITE 500 SCHAUMBURG, ILLINOIS 60173 TEL: 847-908-8400 www.FullertonEngineering.com

CH	ECKED BY:	AG	
AP	PROVED BY:	MB	
#	DATE	DESCRIPTION	INT.
Α	9/9/6	92% REVIEW	MC
В	9/20/16	REVISION	RD
Ø	9/26/16	FINAL	GT
П			
П			Т
П			
П			
П			
П			1
Г			$\top$
	· ·		1
_	<del></del>		_



SITE NAME

GREEN STREET

SITE ID.

SFX5Ø1S

SITE ADDRESS


IIOI GREEN ST SAN FRANCISCO, CA 94109


SHEET NAME

ANTENNA LAYOUTS

SHEET NUMBER

C-4

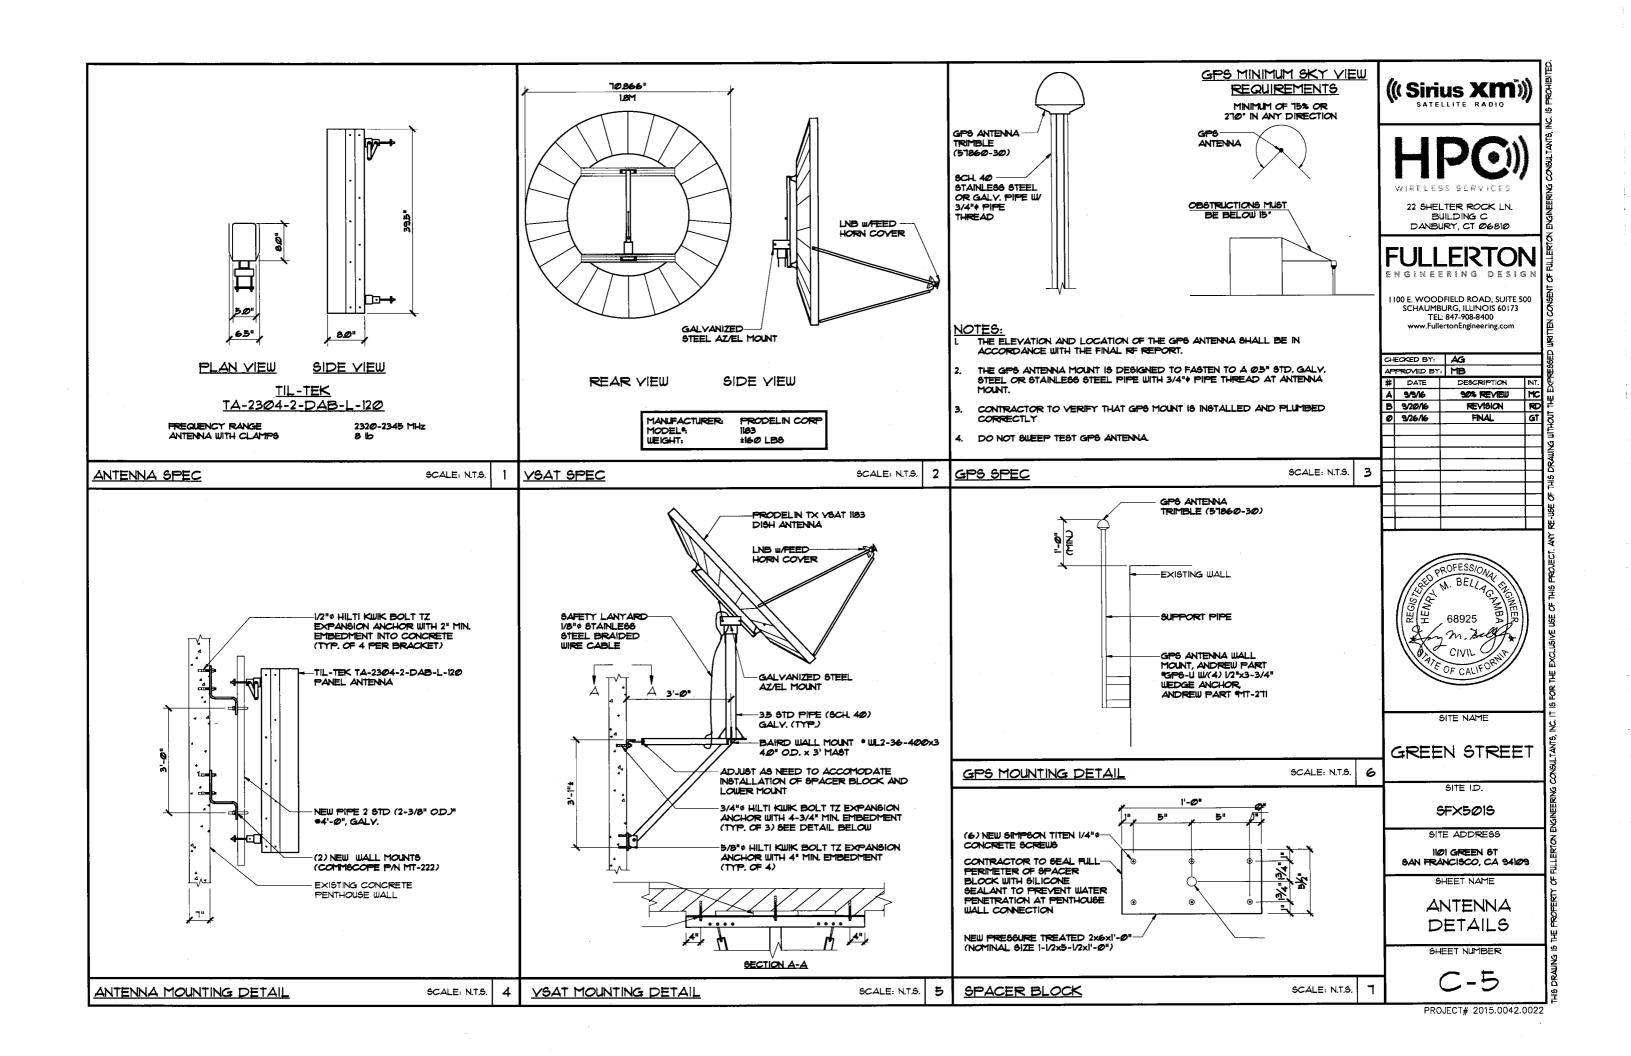

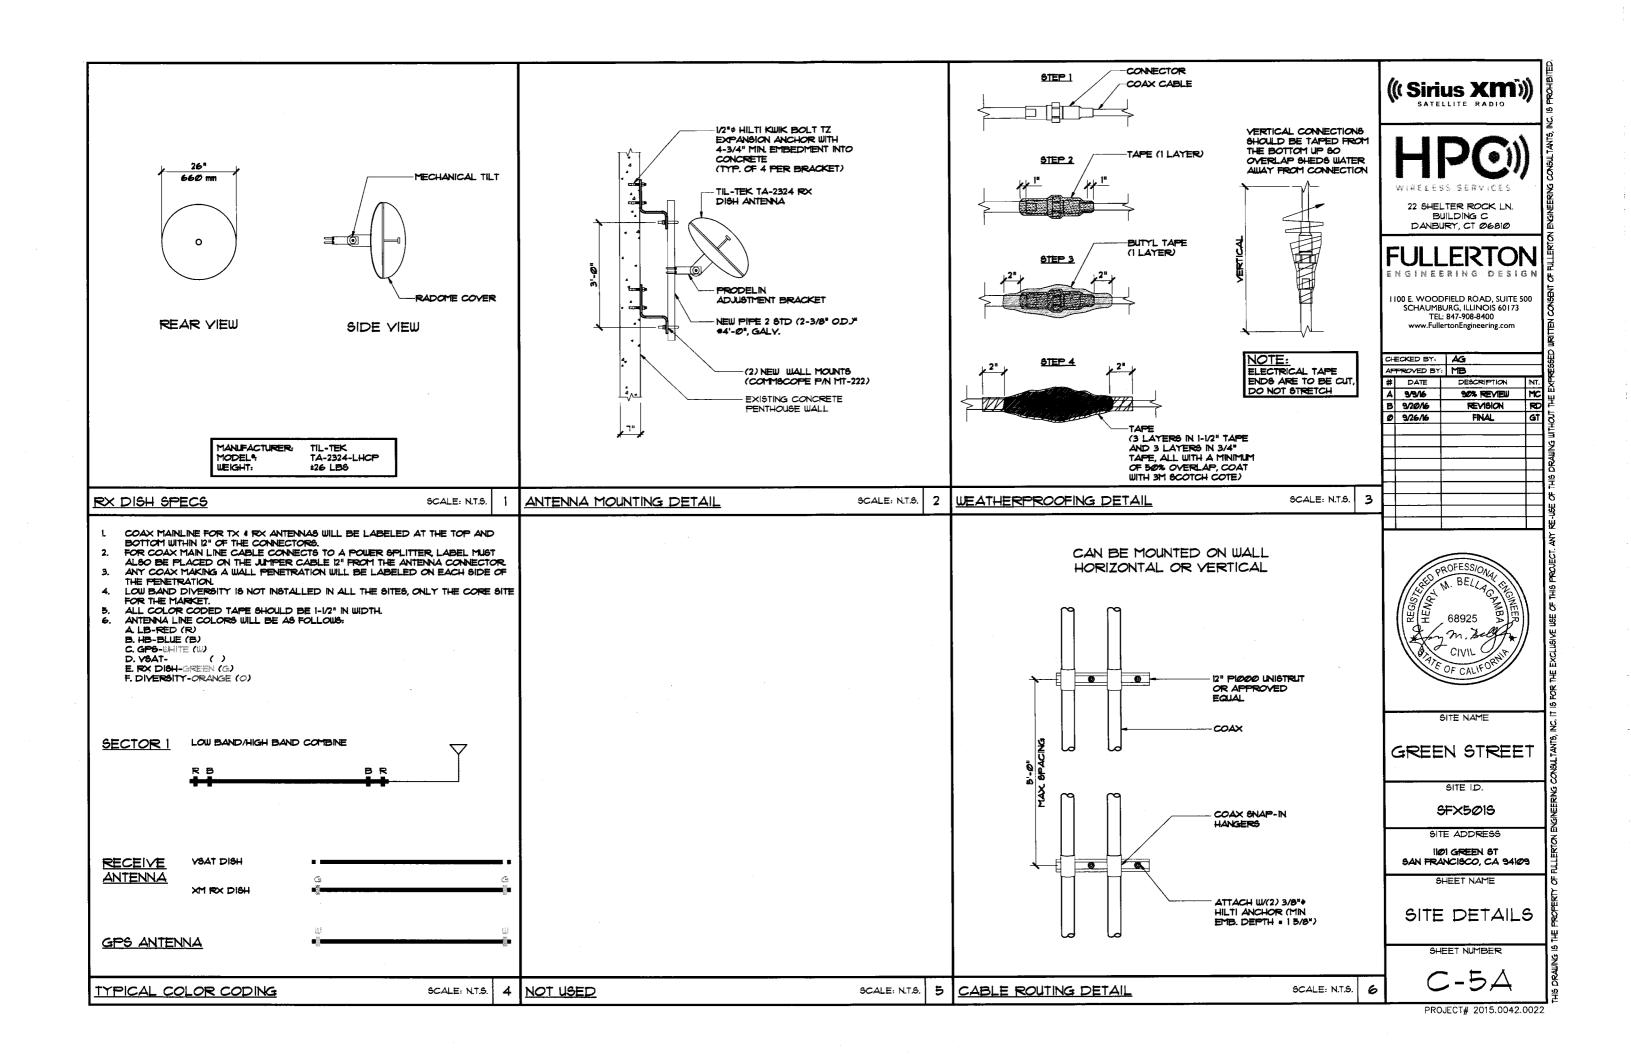

				NEW AI	NTENNA	CONFIGI	JRATION				
			ANTE	NNA					CA	BLE	
ANTENNA NUMBER	NEW OR EXISTING	ANTENNA MANUFACTURER	ANTENNA TYPE	MODEL NUMBER	AZIMUTH (TN)		\$ OF ANTENNA FROM GROUND LEVEL (FT)	NEW OR EXISTING	CABLE TYPE	CABLE SIZE (DIA. IN)	CABLE LENGTH (FT)
1	NEW	TIL-TEK	PANEL	TA-2304-2-DAB-L (120)	340°	4*	26の'-の"	VEU	LD4-50A	500"	65'
2	NEW	PRODELIN	VSAT DISH	1183 WITHOUT DEICING	127°	31°	239'-Ø"	NEW	19G6-Q8	298"	35'
3	NEW	TIL-TEK	FX DISH	TA-2324-LHCP	128*	32°	239'-@"	NEW	LD4-50A	500"	40'
4	WEW	TRIMBLE	GP8	57860-30	N/A	N/A	265'-0"	NEW	19G6-G8	298"	65'
				NEW	EQUIPME	ENT SCH	EDULE				
CABINET NUMBER	CABINET MANUFACTURE	CABINET R TYPE	MODEL NUMBER	NOTES							

NEW POWER SCHEDULE

ue6

VOLTAGE

120/2404

AMPERE

100 AMPS

REPEATER

PHASE

SINGLE

DRU-200W

SUB METER FROM EXISTING AC PANEL ON THE 20TH FLOOR

NOTES

( Sirius XM	<b>)))</b>
-------------	------------



22 SHELTER ROCK LN. BUILDING C DANBURY, CT 06810

### FULLERTON

1100 E. WOODFIELD ROAD, SUITE 500

T100 E. WOODHELD ROAD, SUITE 500
SCHAUMBURG, ILLINOIS 60173
TEL: 847-908-8400
www.FullertonEngineering.com

đ	ECKED BY:	AG:			
ΑP	PROVED BY	MB			
#	DATE	DESCRIPTION	INT.		
A	9/9/6	90% REVIEW	MC		
В	9/20/16	REVISION	3		
Ø	9/26/16	FINAL	GT		
П					
		•	1		
_	-		1		
Г					
$\vdash$			+		



SITE NAME

GREEN STREET

SITE I.D.

SFX5Ø1S

SITE ADDRESS


IIØI GREEN 8T SAN FRANCISCO, CA 94109


SHEET NAME

ANTENNA SCHEDULES

SHEET NUMBER

C-6

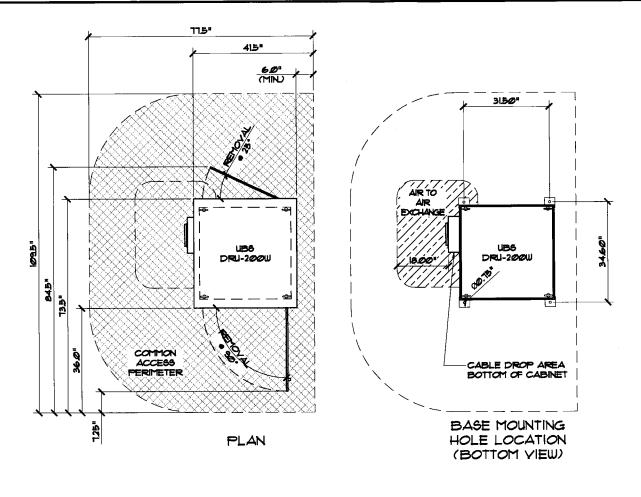

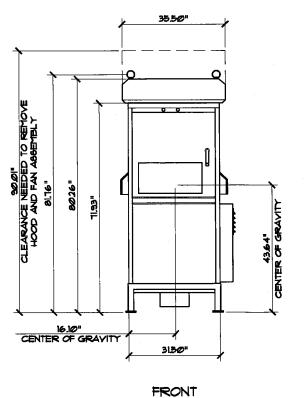

((Sirius XMI))


HPO)

22 SHELTER ROCK LN. BUILDING C DANBURY, CT 06810

## **FULLERTON**

1100 E. WOODFIELD ROAD, SUITE 500 SCHAUMBURG, ILLINOIS 60173 TEL: 847-908-8400 www.FullertonEngineering.com

CH	ECKED BY:	AG	·
4	PROVED BY:	MB	
#	DATE	DESCRIPTION	INT.
A	9/9/16	90% REVIEW	MC
В	9/20/16	REVISION	8
0	9/26/16	FINAL	GT
			Ţ
П			
П			
П			
П			
П			1
П		_	1
-			_

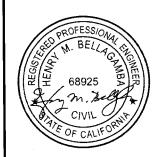

SITE NAME

GREEN STREET

SFX501S

SITE ADDRESS

IIØI GREEN 8T SAN FRANCISCO, CA 94IØ9

SHEET NAME

EQUIPMENT SPECS

SHEET NUMBER

UBS DRU-200W CABINET DETAIL

SCALE: 3/8" = 1'-@"

PROJECT# 2015.0042.0022

# Product Specifications

### **COMMSCOPE®**



ID-FP0406

Light Duty Equipment Platform, 4 ft x 6 ft, with six light duty legs

#### **Dimensions**

Height 508.0 mm | 20.0 in Length 1219.2 mm | 48.0 in Weight 124.8 kg | 275.1 lb Width 1828.8 mm | 72.0 in

### **General Specifications**

Product Type

Equipment platform system

Includes

Frame | Grating | Hardware | Legs

Legs, quantity

Material Type

Hot dip galvanized steel

Note

Contact 828-324-2200 or 1-800-982-1708 (toll free), or your local CommScope

representative | Equipment platforms in additional sizes available.

Package Quantity

### **Regulatory Compliance/Certifications**


Agency


Classification

1

ISO 9001:2008

Designed, manufactured and/or distributed under this quality management system

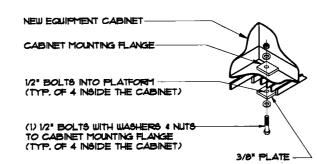

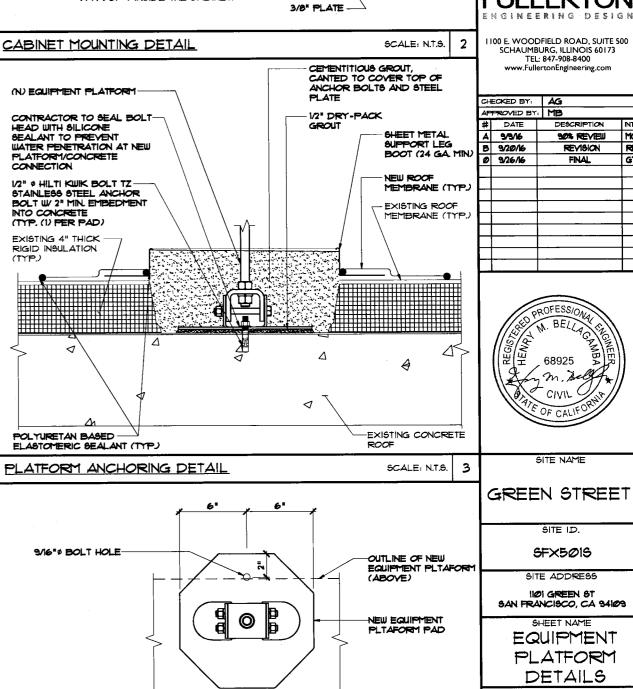

PLATFORM PAD MODIFICATION DETAIL (TYP.)

SCALE: N.T.S.

((Sirius XM))

BUILDING C DANBURY, CT 06810

FINAL

#### SERVICE EQUIPMENT NOTES:

- ALL ELECTRICAL EQUIPMENT SHALL BE LABELED WITH PERMANENT ENGRAVED PLASTIC LABELS
- PATCH, REPAIR AND PAINT ANY AREA THAT HAS BEEN DAMAGED IN THE COURSE OF THE ELECTRICAL

#### CONDUCTOR NOTES:

ELECTRICAL NOTES

- ALL CONDUCTORS SHALL BE COPPER
- ALL WIRING SHALL BE COPPER WITH THIN/THUN DUAL RATED 600 VOLTS INSULATION
- 3. GROUNDING CONDUCTORS SHALL BE SOLID TINNED COPPER UNLESS OTHERWISE NOTED

#### CONDUIT NOTES:

- SCH 80 PYC CONDUIT SHALL BE USED WHEN INSTALLED IN OR UNDER CONCRETE SLABS, IN CONTACT WITH EARTH, OR EXPOSED ABOVE GRADE
- EMT SHALL BE USED ONLY FOR INTERIOR RUNS AND SHALL HAVE COMPRESSION TYPE FITTINGS
- 3. SEAL TIGHT, FLEXIBLE CONDUIT MAY BE USED WHERE CODE PERMITS. ALL CONDUIT SHALL HAVE FULL SIZE EQUIPMENT GROUND WIRE
- 4. SERVICE CONDUITS SHALL HAVE NO MORE THAN (3) -90" BENDS IN ANY SINGLE RUN. THE CONTRACTOR SHALL PROVIDE PULL BOXES AS NEEDED WHERE CONDUIT REQUIREMENTS EXCEED THESE CONDITIONS
- 5. ALL CABLES, POWER AND/OR TELEPHONE AND/OR FIBER 6YSTEM CONDUITS SHALL HAVE A MINIMUM 24" RADIUS SWEEPS TO EQUIPMENT, PULL BOXES, ETC., UNLESS OTHERWISE NOTED, OR AS REQUIRED BY UTILITY COMPANIES

#### NEW CABLE GROUNDING NOTES:

- AVOID DISPUPTION OF EXISTING GROUNDING SYSTEM. REPAIR ANY DAMAGE TO THE SATISFACTION OF THE
- CONTRACTOR SHALL CONNECT GROUND KITS TO THE EXISTING GROUND BARS AT THE TOP AND BASE OF
- 3. CONTRACTOR SHALL CONNECT GROUND KITS TO THE NEW GROUND BAR BEFORE ENTRY TO CABINET
- 4. NO BACK TO BACK LUGGING OF GROUNDS

#### GENERAL GROUNDING NOTES:

- VERTICAL DROPS SHALL BE 20'-0" OF 12 AUG SOLID TINNED COPPER WIRE CADWELD TO GROUND BAR
- 2. ALL BENDS MINIMUM S" RADIUS
- 3. APPLY ANTI-OXIDATION COMPOUND TO ALL CONNECTIONS
- 4. BARE COPPER CONDUCTORS SHALL NOT BE IN CONTACT WITH ANY DISSIMILAR MATERIAL. PLACE ON STANDOFFS, IF NECESSARY TO ALLOW FOR PROPER INSTALLATION
- 5. SHARP BENDS IN GROUNDING CONDUCTORS SHALL BE AVOIDED. 960° BENDS SHALL NOT BE USED
- 6. ALL GROUNDING CONDUCTORS SHALL BE KEPT AS SHORT AS POSSIBLE. THE SHORTEST PRACTICAL ROUTE SHALL BE CHOSEN WITH THE LEAST AMOUNT OF BENDS AND SPLICES. USE THIS RULE AT ALL
- 1. ALL CONNECTIONS TO GROUND BARS SHALL BE WITH A 2-HOLE LUG UNLESS OTHERWISE SPECIFIED
- 8. WHEN GROUNDING MORE THAN ONE PIECE OF EQUIPMENT, DO NOT USE THE EQUIPMENT AS A GROUNDING CONDUCTOR DOUBLE-STACKING OF LUGS SHALL BE USED TO GET FROM EQUIPMENT TO EQUIPMENT
- 9. REMOVE ALL PAINT BENEATH THE SURFACE OF GROUND LUGS

((( Sirius XM)))



22 SHELTER ROCK LN. BUILDING C DANBURY, CT Ø6810

## **LERTON**

100 E. WOODFIELD ROAD, SUITE 500 SCHAUMBURG, ILLINOIS 60173 TEL: 847-908-8400 www.FullertonEngineering.com

١		PROVED BY	: MB	
	#	DATE	DESCRIPTION	1
	A	9/9/16	90% REVIEW	ľ
	B	9/20/16	REVISION	Ī
	0	9/26/16	FINAL	Ī
				Γ
1				Γ
				Γ
				Т

CHECKED BY: AG

SCALE: N.T.S.

YECTRIC

GREEN STREET

SFX5ØIS

SITE ADDRESS

SAN FRANCISCO, CA 94109

UTILITY PLAN

SHEET NUMBER

NEW SIRIUS XM DRU-200W CABINET MOUNTED ON NEW STEEL PLATFORM -EXISTING PROPANE TANK NEW SIRIUS XM POWER DISTRIBUTION PANEL MOUNTED ON PENTHOUSE WALL EXISTING EXISTING WATER STAIRCASE TANK

NEW 1" & ELECTRICAL CONDUIT FROM NEW SIRIUS XM DISTRIBUTION PANEL TO EXISTING PANEL LOCATED ON 20TH FLOOR BELOW ROUTE CONDUIT ALONG ROOFTOP ON SLEEPERS SEE E-1A FOR CONTINUATION

SITE NAME

SITE ID.

INDI GREEN ST

SHEET NAME

a ROOF

PROJECT# 2015.0042.0022

UTILITY PLAN & ROOF

ROOF-

MAIN

EXISTING

NEW WALL PENETRATION

FOR ROUTING OF NEW CONDUIT INSIDE BUILDING

EXISTING ROOF


ACCESS DOOR

EXISTING STEEL

ACCESS STAIRS

SCALE: 3/16" = 1'-0"

NOTE: EXACT LOCATION OF SIRIUS XM ELECTRIC METER SHALL BE COORDINATED WITH LANDLORD

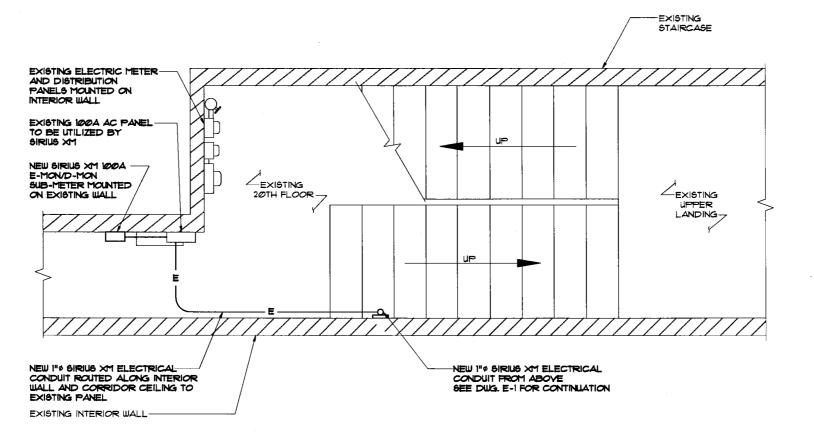






22 SHELTER ROCK LN. BUILDING C DANBURY, CT Ø6810

I 100 E. WOODFIELD ROAD, SUITE 500 SCHAUMBURG, ILLINOIS 60173 TEL: 847-908-8400 www.FullertonEngineering.com

	đ	ECKED BY:	AG	
	¥	PROVED BY	MB	
	#	DATE	DESCRIPTION	INT
1	Α	9/9/6	90% REVIEW	M
	B	9/20/16	REVISION	R
	0	9/26/16	FINAL	GI
				Т
				1
				-

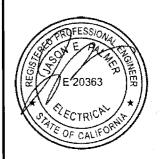

SITE NAME

GREEN STREET

SITE ID.


SFX501S

SITE ADDRESS

IIØI GREEN 6T SAN FRANCISCO, CA 94109

UTILITY PLAN @ 20TH FLOOR

SHEET NUMBER

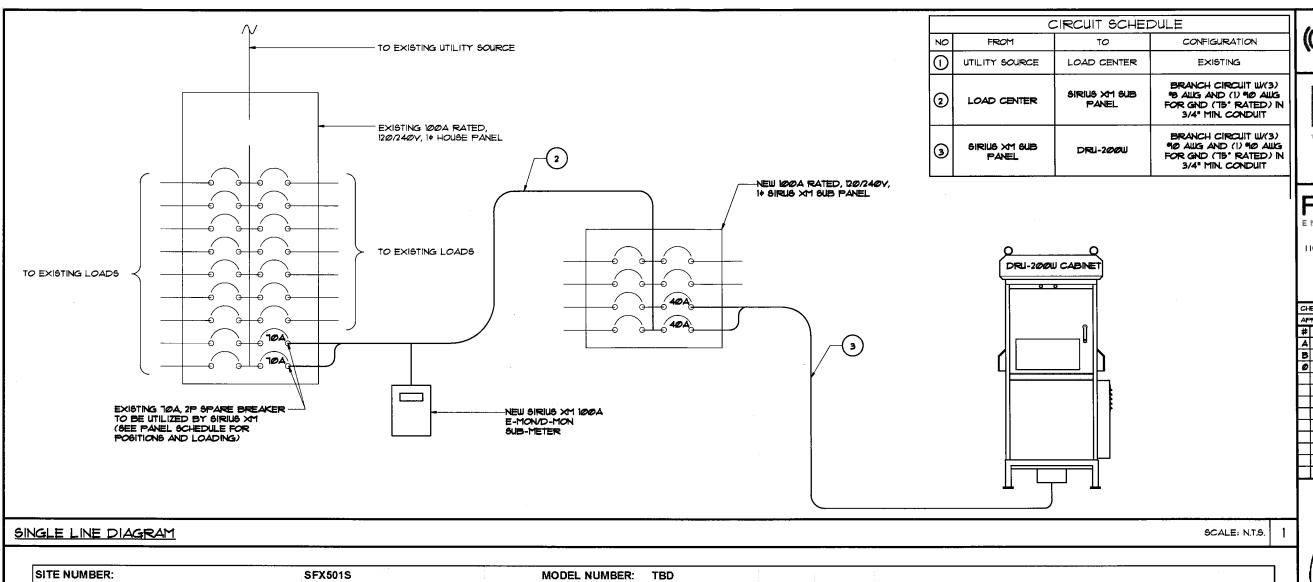

(( Sirius XM))

HPC))

22 SHELTER ROCK LN. BUILDING C DANBURY, CT Ø6810

## FULLERTON

I 100 E. WOODFIELD ROAD, SUITE 500 SCHAUMBURG, ILLINOIS 60173 TEL: 847-908-8400 www.FullertonEngineering.com

A 9/9/6 90% REVIEW B 9/20/6 REVISION	N M
# DATE DESCRIPTION	M
A 9/9/6 90% REVIEW   B 9/20/6 REVISION	M
B 9/20/16 REVISION	F
	_
0 9/26/16 FINAL	G
	_



SITE NAME

### GREEN STREET

SITE ID.

SFX5Ø1S

SITE ADDRESS

IIØI GREEN ST AN FRANCISCO, CA 94109

SHEET NAME

FINAL SINGLE LINE DIAGRAM/ PANEL SCHED.

SHEET NUMBER

E-2

	٠	
		`
1		
скт		GR
2		
4		
6		
8		
		SAN

ENCLOSURE TYPE: Nema 3R PANEL STATUS: Existing BREAKER BREAKER | BREAKER | SERVICE | USAGE PHASE A PHASE B USAGE SERVICE BREAKER BREAKER BREAKER CKT LOAD DESCRIPTION **AMPS POLES** STATUS LOAD VA FACTOR VA FACTOR LOAD VA STATUS AMPS VA POLES LOAD DESCRIPTION 1.00 MAIN BREAKER 100 2 On 3 1.00 5 2194 1.00 2194 1.00 **DRU-200W CABINET** 70 On 2194 1.00 2194 1.00 2194 2194 ٧A TOTAL KVA 4.39 AMPS 18.28

**100 AMPS** 

WIRE:

GROUND BAR:

AIC:

PHASE:

BUSS RATING:

HOUSE PANEL SCHEDULE

VOLTAGE:

MOUNT:

MAIN BREAKER:

120/240

40 AMP


Surface

SCALE: N.T.S.

2

PROJECT# 2015.0042.0022

1/

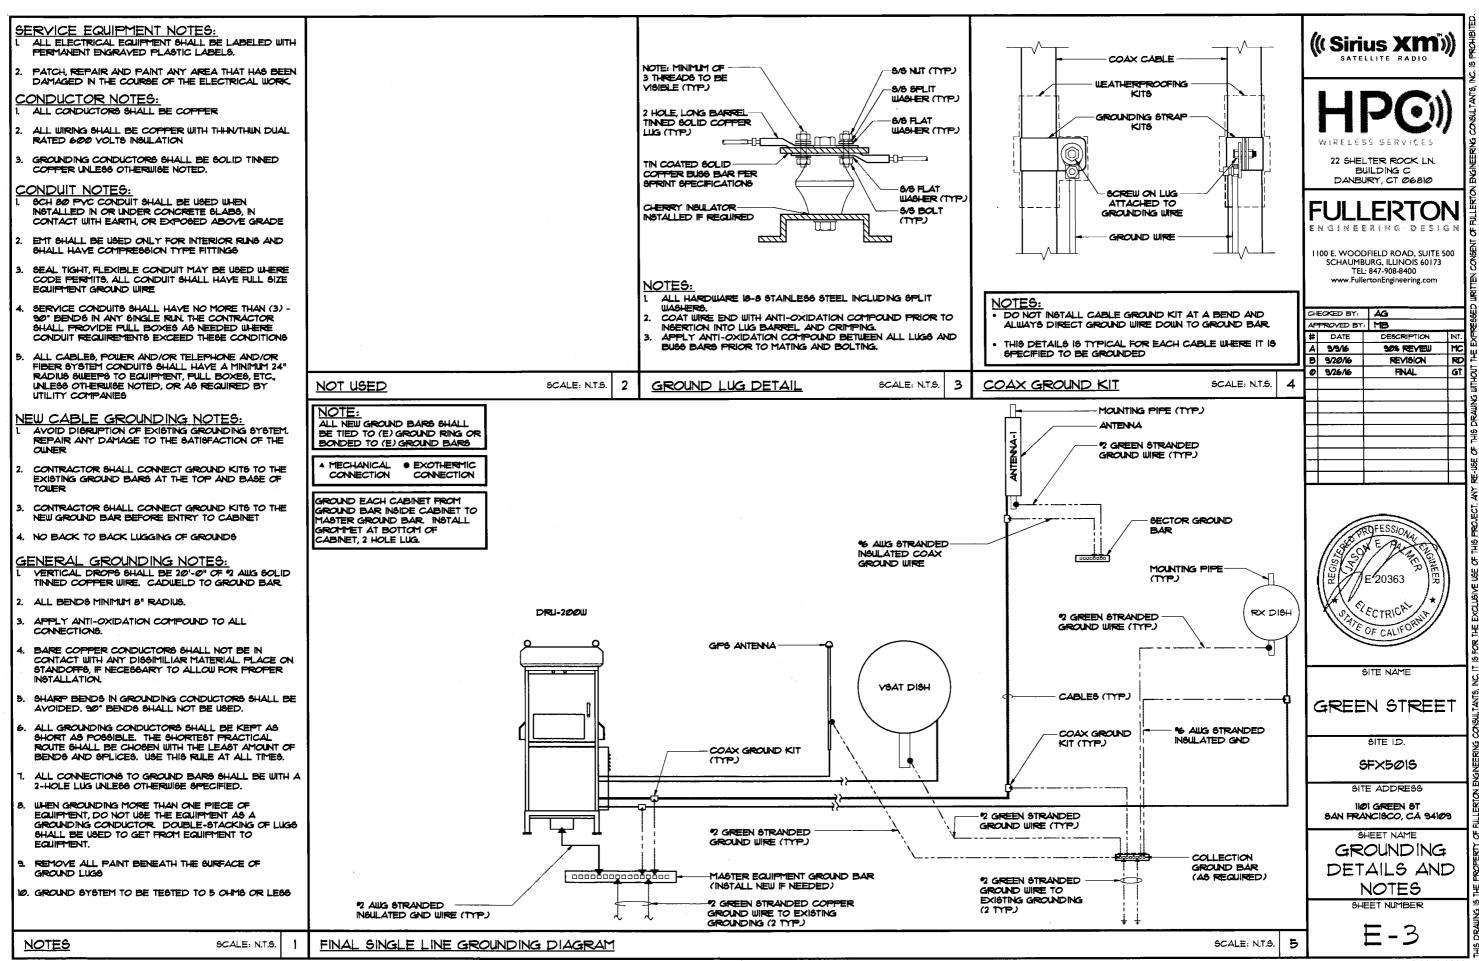

LNB PART *4501A BY NORSAT F-FEMALE	ITEM *	DESCRIPTION	SIZE	QUANTITY	LENGTH	MANUFACTURER	PART NUMBER	REMARKS	PROVIDED BY	((Sirius XMI))
CONNECTOR	1	VSAT DI <del>SH</del>	1 <i>0.8</i> 66"	1 NEW	N/A	PRODELIN	1183 W/O DEICING	PRODELIN VSAT DISH ANTENNA	VENDOR	HPC)) WIRELESS SERVICES
	2	LNB	N/A	1 NEW	N/A	NORSAT	45Ø7A	<b>-</b>	YEND <i>O</i> R	22 SHELTER ROCK LN. BUILDING C DANBURY, CT 06810  FULLERTON ENGINEERING DESIGN
	3	F-MALE CONNECTOR	N/A	1 NEW	N/A	THOMAS AND BETTS	SNSIP6QS	-	VENDOR	I 100 E. WOODFIELD ROAD, SUITE 500 SCHAUMBURG, ILLINOIS 60173 TEL: 847-908-8400 www.FullertonEngineering.com
•	4	COAX CABLE	298"	1 NEW	35'	BELDEN	RG6-Q5	-	VENDOR	# DATE DESCRIPTION INT. A 99/6 90% REVIEW MC B 9/20/6 REVISION RD 0 9/26/6 FINAL GT
	∃5	F-MALE CONNECTOR	N/A	1 NEW	N/A	THOMAS AND BETTS	SNSIP6QS		VENDOR	
		CABINET	N/A	1 NEW	N/A	UBS	DRU-2 <i>00</i> W	<del>-</del>	SIRIUS XM	E 20363
YSAT ANTENNA CONFIGURATION	' <u>.</u>		<u>'</u>						SCALE: N.T.S. 1	OF CALIFORNIA
	ITEM *	DESCRIPTION	SIZE	QUANTITY	LENGTH	MANUFACTURER	PART NUMBER	REMARKS	PROVIDED BY	SITE NAME
	1	GPS ANTENNA	N/A	1 NEW	N/A	TRIMBLE	57860-30	-	SIRIUS XM	GREEN STREET
	2	F CONNECTOR	N/A	1 NEW	N/A	THOMAS AND BETTS	SNSIPEQS	-	VENDOR	\$ITE 1D. \$FX5@15
	3	COAX CABLE	298"	1 NEW	65'	BELDEN	RG6-Q5	-	VENDOR	SITE ADDRESS
	4	F CONNECTOR	N/A	1 NEW	N/A	THOMAS AND BETTS	SNSIP6QS	-	VENDOR	SHEET NAME
	5	F TO N CONNECTOR	N/A	INEW	N/A	EMERSON	26-8020	-	SIRIUS XM	SITE CONFIGURATIONS
	6	CABINET	N/A	1 NEW	N/A	UB\$	DRU-200W	-	SIRIUS XM	MATERIAL LIST SHEET NUMBER
GPS ANTENNA CONFIGURATION			I	I	·				SCALE: N.T.S. 2	T E-4





22 SHELTER ROCK LN. BUILDING C DANBURY, CT 06810

### **FULLERTON**

I 100 E. WOODFIELD ROAD, SUITE 500 SCHAUMBURG, ILLINOIS 60173 TEL: 847-908-8400 www.FullertonEngineering.com

CH	ECKED BY:	AG				
AP	PROVED BY	MB				
#	DATE	DESCRIPTION	INT.			
A	9/9/6	92% REVIEW	3			
В	9/20/16	REVISION	B			
0	9/26/16	FINAL	GT			
			Π			
			1			
	# A B	# DATE A 9/9/6 B 9/20/6	APPROVED BY: MB  # DATE DESCRIPTION  A 3/3/6 30% REVIEW  B 3/20/6 REVISION			

OF CALIFORNIA
---------------

SITE NAME

GREEN STREET

91TE I.D. **9F×5Ø19** 

IIOI GREEN ST SAN FRANCISCO, CA 94109


SHEET NAME

SITE CONFIGURATIONS

MATERIAL LIST

F-4A

		ITEM *	DESCRIPTION	SIZE	QUANTITY	LENGTH	MANUFACTURER	PART NUMBER	REMARKS	PROVIDED BY
		<u></u>	HB RX DISH (233Ø-2345 MHz)	25.25"	1 NEW	N/A	TIL-TEK	TA-2324-LHCP	CIRCULAR POLARIZED SOLID PARABOLIC DISH ANTENNA	BIRIUS XM
	П	2	1-16 DIN MALE CONNECTOR	N/A	1 NEW	N/A	ANDREW	L4TDM-P8A	ATTACH TO CABLE PRIOR TO INSTALLATION	VENDOR
		3	GROUNDING KIT	NA	1 NEW	N/A	ANDREW	<del>3</del> GI2- <i>0</i> 6B2A	NCLUDES 59" % GROUND WIRE, NSTALL 1 KIT EVERY 1000 FT. MIN.	YENDOR
· _/		<u> </u>	COAXIAL CABLE	1/2"ø	1 NEW	50'	ANDREW	LDF4-50A	MINIMUM BEND RADIUS PER MANUFACTURER SPECS	VENDOR
*		— b	GROUNDING KIT	N/A	: NEW	N/A	ANDREW	8GI2- <i>06</i> B2A	NCLUDES 59" % GROUND WIRE, INSTALL I KIT EVERY 1000 FT. MIN.	VENDOR
	/ /	6	N MALE CONNECTOR	NA	1 NEW	N/A	ANDREW	L4TNM-P8A	-	VENDOR
			CABINET	N/A	1 NEW	N/A	uB6	DRU-200W	-	SIRIUS XM
1								-		

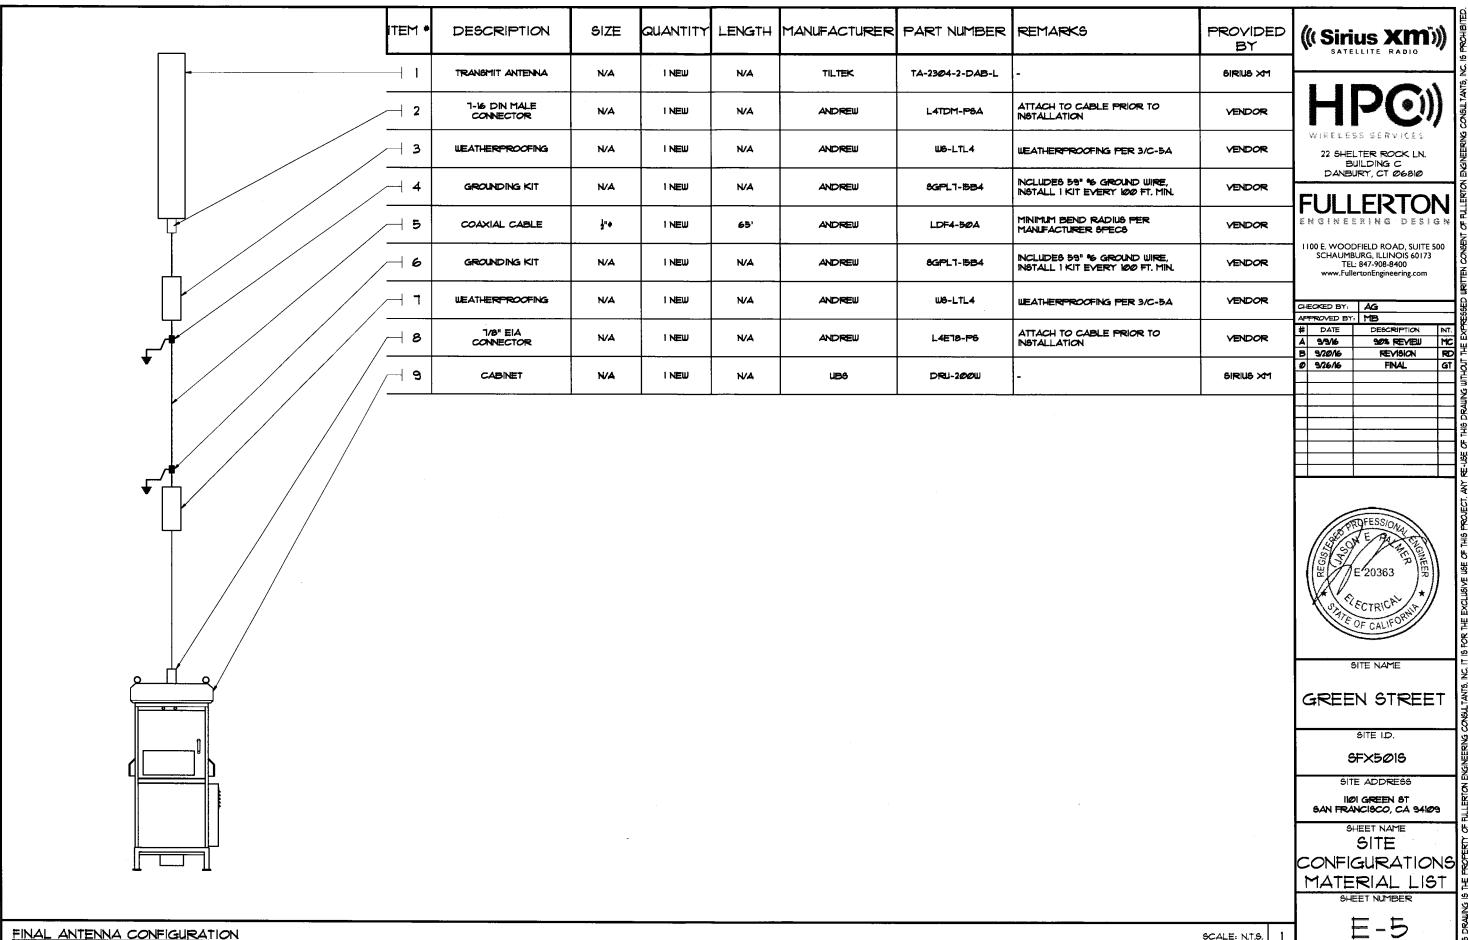

((( Sirius XM 🏿 ))

22 SHELTER ROCK LN. BUILDING C DANBURY, CT 06810

1100 E. WOODFIELD ROAD, SUITE 500 SCHAUMBURG, ILLINOIS 60173 TEL: 847-908-8400

	₫	ECKED BY:	AG	
_	Æ	PROVED BY	MB	
	#	DATE	DESCRIPTION	INT.
	A	9/9/6	90% REVIEW	MC
	В	9/20/16	REVISION	8
	0	9/26/16	FINAL	GT



SITE NAME

GREEN STREET

SFX5ØIS

SITE ADDRESS

IIOI GREEN ST SAN FRANCISCO, CA 94109

SHEET NAME

SITE

MATERIAL LIST

SHEET NUMBER

SCALE: N.T.S.

#### SHEET INDEX NO. DESCRIPTION T-1 TITLE SHEET T-2 GENERAL NOTES C-1 SITE PLAN C-1A ENLARGED ROOF PLAN C-2 ENLARGED EQUIPMENT LAYOUT C-3 SITE ELEVATION C-4 ANTENNA LAYOUTS C-5 ANTENNA DETAILS C-5A SITE DETAILS C-5B MOUNTING DETAILS C-5C MOUNTING DETAILS C-6 ANTENNA SCHEDULES C-7 EQUIPMENT SPECS UTILITY PLAN AND NOTES E-1A UTILITY PLAN AND NOTES E-2 FINAL SINGLE LINE DIAGRAM/PANEL SCHEDULE E-3 GROUNDING DETAILS AND NOTES SITE CONFIGURATIONS MATERIAL LIST E-4A SITE CONFIGURATIONS MATERIAL LIST E-5 SITE CONFIGURATIONS MATERIAL LIST

#### DRIVING DIRECTIONS

DEPART SAN FRANCISCO INTERNATIONAL AIRPORT TURN LEFT (WEST) ONTO LOCAL ROAD(S) KEEP RIGHT ONTO RAMP TAKE RAMP (LEFT) ONTO BAYSHORE FWY TAKE RAMP (RIGHT) ONTO JOHN F FORAN FWY TURN LEFT ONTO RAMP ROAD NAME CHANGES TO KING ST ROAD NAME CHANGES TO HERB CAEN WAY TURN LEFT (WEST) ONTO BRYANT ST TURN RIGHT (NORTH-WEST) ONTO BEALE ST TURN LEFT (SOUTH) ONTO LOCAL ROAD(S)
ARRIVE 400 BEALE ST, SAN FRANCISCO, CA 94105

### **APPROVED**

By kdavis at 8:27 am, Apr 07, 2017



SITE NAME

400 BEALE STREET

SITE I.D.

SFX502T

SITE ADDRESS

400 BEALE STREET SAN FRANCISCO, CA 94105

STRUCTURE TYPE

ROOF TOP

PROJECT TEAM

#### VICINITY MAP



22 SHELTER ROCK LN. BUILDING C DANBURY, CT 06810 PROJECT MANAGER/

SITE ACQUISITION

### **FULLERTON**

I 100 E. WOODFIELD ROAD, SUITE 500 SCHAUMBURG, ILLINOIS 60173 TEL: 847-908-8400 www.FullertonEngineering.com

**ENGINEER** 

#### CODE COMPLIANCE:

- HANDICAP ACCESS REQUIREMENTS ARE NOT
- FACILITY IS UNMANNED AND NOT FOR HUMAN HABITATION
- FACILITY HAS NO PLUMBING OR REFRIGERANTS
- THIS FACILITY SHALL MEET OR EXCEED ALL FAA AND FCC REGULATORY REQUIREMENTS

#### SCOPE OF WORK:

- INSTALL NEW SIRIUS XM RX DISH ON EXISTING ROOFTOP
- INSTALL NEW SIRIUS XM CABINET ON NEW STEEL PLATFORM ON

#### PROJECT SUMMARY

400 BEALE STREET SITE NAME:

SFX502T SITE NO:

400 BEALE STREET

SITE ADDRESS: SAN FRANCISCO, CA 94105

COUNTY: SAN FRANCISCO

SITE COORDINATES
LATITUDE:
LONGITUDE: 37.07037500° (NAD 83) -122.39086388\* (NAD 83) GROUND ELEVATION:

JURISDICTION: ZONING:

SAN FRANCISCO

APPLICANT:

SIRIUS XM 1500 ECKINGTON PL NE WASHINGTON, DC 20002 TEL: (202) 380-4157

FAX: (202) 380-4570

LANDLORD:

CONST.

OPS

LANDLORD

OCCUPANCY TYPE: CONSTRUCTION TYPE:

2016 CALIFORNIA ADMINISTRATIVE CODE 2016 CALIFORNIA BUILDING CODE (IBC 2012)

2016 CALIFORNIA ELECTRICAL CODE (2011 NEC)

CALIFORNIA ENERGY CODE

CALIFORNIA GREEN CODÈ

CITY/COUNTY ZONING ORDINANCES

I HEREBY CERTIFY THAT THESE DRAWING WERE PREPARED BY ME OR UNDER MY DIRECT SUPERVISION AND CONTROL, AND TO THE BEST OF MY KNOWLEDGE AND BELIEF COMPLY WITH THE REQUIREMENTS OF ALL APPLICABLE CODES.



**APPROVALS** 

DRAWING SCALED TO 11"x17"

DATE

DATE

DATE

DATE

400 BEALE STREET

SITE NAME

《Sirius XM》》

22 SHELTER ROCK LN.

BUILDING C DANBURY, CT 06810

1100 E. WOODFIELD ROAD, SUITE 500 SCHAUMBURG, ILLINOIS 60173 TEL: 847-908-8400

DESCRIPTION

90% REVIEW

REVISION

REVISION

FINAL

CHECKED BY: AG

DATÉ

01/13/17

03/28/17

04/03/17

APPROVED BY: AR

SITÉ I.D. SFX502T

SITE ADDRESS

400 BEALE STREET SAN FRANCISCO, CA 94105

SHEET NAME TITI F

SHEET

SHEET NUMBER

FEC# 2015.0042.0025

### INSTALL (1) NEW SIRIUS XM PANEL ANTENNA ON EXISTING ROOFTOP

INSTALL NEW SIRIUS XM VSAT DISH ON EXISTING ROOFTOP
INSTALL NEW SIRIUS XM GPS ANTENNA ON EXISTING ROOFTOP

EXISTING ROOF TOP

ALL NEW MATERIAL SHALL BE FURNISHED AND INSTALLED BY CONTRACTOR UNLESS NOTED OTHERWISE. CABINETS, ANTENNAS AND CABLES FURNISHED BY OWNER AND INSTALLED BY CONTRACTOR

2016 CALIFORNIA MECHANICAL CODE (2012 UMC)

CALIFORNIA FIRE CODE (2012 IFC)

CALIFORNIA REFERENCES STANDARDS CODE

CERTIFICATION STATEMENT



#### GENERAL CONSTRUCTION NOTES:

- THIS SET OF PLANS HAS BEEN PREPARED FOR THE PURPOSES OF MUNICIPAL AND AGENCY REVIEW AND APPROVAL.
- THESE PLANS ARE INTENDED TO BE USED TO DIRECT THE NEW LAYOUT. DRAWINGS SHOULD NOT BE SCALED UNLESS OTHERWISE NOTED. PLANS, ELEVATIONS AND DETAILS ARE INTENDED TO SHOW THE END RESULT OF DESIGN. MINOR MODIFICATIONS MAY BE REQUIRED TO SUIT JOB DIMENSIONS OR CONDITIONS.
- THE CONTRACTOR SHALL VERIFY ALL DIMENSIONS AND CONDITIONS AND NOTIFY THE PROJECT MANAGER OF ANY DISCREPANCIES BEFORE STARTING ANY WORK.
- ALL EQUIPMENT AND MATERIALS SHALL BE INSTALLED IN ACCORDANCE WITH THE MANUFACTURER'S RECOMMENDATIONS UNLESS OTHERWISE NOTED BY THE ENGINEER OF RECORD.
- 5. CONTRACTOR SHALL BE RESPONSIBLE FOR ALL WORK PERFORMED AND MATERIALS INSTALLED TO BE IN STRICT CONFORMANCE, AS A MINIMUM STANDARD, WITH ALL APPLICABLE CODES, REGULATIONS AND ORDINANCES HAVING JURISDICTION. ELECTRICAL SYSTEMS SHALL BE INSTALLED IN CONFORMANCE WITH THE NATIONAL ELECTRICAL CODE, AND ALL OTHER LOCAL AND STATE JURISDICTIONAL CODES, ORDINANCES, AND WITH LOCAL UTILITY COMPANY SPECIFICATIONS, WHICHEVER IS MORE STRINGENT
- 6. THE CONTRACTOR SHALL KEEP CONTRACT AREA CLEAN, HAZARD FREE AND DISPOSE OF ALL DIRT, STUMPS, STONES, RUBBISH OR DEBRIS IN ACCORDANCE WITH ALL LOCAL AND ENVIRONMENTAL LAWS. NO MATERIALS OR EQUIPMENT SHALL BE PLACED ANYWHERE ON OR IN THE STRUCTURE WITHOUT MAKING ADEQUATE PROVISIONS TO PROTECT EXISTING PROPERTY. UPON COMPLETION, REPAIR ANY DAMAGE THAT MAY HAVE OCCURRED DURING CONSTRUCTION. REPAIR ALL EXISTING WALL SURFACES DAMAGED DURING CONSTRUCTION SUCH THAT THEY MATCH AND BLEND WITH ADJACENT SURFACES.
- THE CONTRACTOR SHALL BE SOLELY RESPONSIBLE AND HAVE CONTROL OVER CONSTRUCTION MEANS, METHODS, TECHNIQUES, SEQUENCES, AND PROCEDURES.

#### WARRANTIES AND BONDS:

- THE CONTRACTOR SHALL GUARANTEE ALL LABOR AND MATERIALS USED IN THIS
  PROJECT FOR A MINIMUM PERIOD OF ONE (1) YEAR COMMENCING FROM THE DATE
  OF FINAL ACCEPTANCE BY THE CLIENT. THE CONTRACTOR IS NOT REQUIRED TO
  GUARANTEE MATERIAL SUPPLIED BY THE OWNER.
- 2. FINAL DATE OF ACCEPTANCE IS DEEMED AS THE DATE THAT ALL REQUIRED STATE AND FEDERAL APPROVAL HAVE BEEN OBTAINED INCLUDING, BUT NOT LIMITED TO:

  A. FINAL INSPECTION—D14

  B. CERTIFICATE OF OCCUPANCY
- ANY DEFICIENCIES THAT COME EVIDENT DURING THIS ONE (1) YEAR PERIOD SHALL BE CORRECTED BY THE CONTRACTOR AT THE CONTRACTOR'S EXPENSE.

#### DELIVERY, STORAGE AND HANDLING:

- THE CONTRACTOR SHALL BE RESPONSIBLE FOR ALL PROCEDURES AND SCHEDULING ASSOCIATED WITH HOISTING, STAGING, AND ERECTING OF MATERIALS AND EQUIPMENT TO AND/OR UPON THE SITE.
- ALL ELEMENTS OF THE EXISTING SITE, I.E. STRUCTURES, SITE PLANTINGS, ETC. SHALL BE PROTECTED AS NECESSARY FROM SAID ACTIONS. THIS WORK MUST BE DONE IN A SAFE, SECURE NONDESTRUCTIVE MANNER FOR PROTECTING PERSONNEL AND PROPERTY.

#### SITE WORK GENERAL NOTES:

- THIS SET OF PLANS HAS BEEN PREPARED FOR THE PURPOSES OF MUNICIPAL AND AGENCY REVIEW AND APPROVAL.
- THESE PLANS ARE INTENDED TO BE USED TO DIRECT THE NEW LAYOUT. DRAWINGS SHOULD NOT BE SCALED UNILESS OTHERWISE NOTED. PLANS, ELEVATIONS AND DETAILS ARE INTENDED TO SHOW THE END RESULT OF DESIGN. MINOR MODIFICATIONS MAY BE REQUIRED TO SUIT JOB DIMENSIONS OR CONDITIONS.
- THE CONTRACTOR SHALL VERIFY ALL DIMENSIONS AND CONDITIONS AND NOTIFY THE PROJECT MANAGER OF ANY DISCREPANCIES BEFORE STARTING ANY WORK.
- ALL EQUIPMENT AND MATERIALS SHALL BE INSTALLED IN ACCORDANCE WITH THE MANUFACTURER'S RECOMMENDATIONS UNLESS OTHERWISE NOTED BY THE ENGINEER OF RECORD.
- 5. CONTRACTOR SHALL BE RESPONSIBLE FOR ALL WORK PERFORMED AND MATERIALS INSTALLED TO BE IN STRICT CONFORMANCE, AS A MINIMUM STANDARD, WITH ALL APPLICABLE CODES, REGULATIONS AND ORDINANCES HAVING JURISDICTION. ELECTRICAL SYSTEMS SHALL BE INSTALLED IN CONFORMANCE WITH THE NATIONAL ELECTRICAL CODE, AND ALL OTHER LOCAL AND STATE JURISDICTIONAL CODES, ORDINANCES, AND WITH LOCAL UTILITY COMPANY SPECIFICATIONS, WHICHEVER IS MORE STRINGENT.
- 6. THE CONTRACTOR SHALL KEEP CONTRACT AREA CLEAN, HAZARD FREE AND DISPOSE OF ALL DIRT, STUMPS, STONES, RUBBISH OR DEBRIS IN ACCORDANCE WITH ALL LOCAL AND ENVIRONMENTAL LAWS. NO MATERIALS OR EQUIPMENT SHALL BE PLACED ANYWHERE ON OR IN THE STRUCTURE WITHOUT MAKING ADEQUATE PROVISIONS TO PROTECT EXISTING PROPERTY. UPON COMPLETION, REPAIR ANY DAMAGE THAT MAY HAVE OCCURRED DURING CONSTRUCTION. REPAIR ALL EXISTING WALL SURFACES DAMAGED DURING CONSTRUCTION SUCH THAT THEY MATCH AND BLEND WITH ADJACENT SURFACES.
- THE CONTRACTOR SHALL BE SOLELY RESPONSIBLE AND HAVE CONTROL OVER CONSTRUCTION MEANS, METHODS, TECHNIQUES, SEQUENCES, AND PROCEDURES.
- 8. THE CONTRACTOR SHALL CALL UTILITIES PRIOR TO THE START OF CONSTRUCTION.
- ALL SITE WORK SHALL BE AS INDICATED ON THE DRAWING AND STIPULATED IN THE SPECIFICATION PROJECT SUMMARY.
- IF NECESSARY, RUBBISH, STUMPS, DEBRIS, STICKS, STONES, AND OTHER REFUSE SHALL BE REMOVED FROM THE SITE AND DISPOSED OF LEGALLY.
- 11. THE SITE SHALL BE GRADED TO CAUSE SURFACE WATER FLOW AWAY FROM THE EQUIPMENT SHELTER AND TOWER AREAS.
- NO FILL OR EMBANKMENT MATERIAL SHALL BE PLACED ON FROZEN GROUND. FROZEN MATERIALS, SNOW OR ICE SHALL NOT BE PLACED IN ANY FILL OR FMBANKMENT.
- 13. THE SUB GRADE SHALL BE COMPACTED AND BROUGHT TO A SMOOTH UNIFORM GRADE PRIOR TO FINISHED SURFACE APPLICATION.
- 14. ALL EXISTING INACTIVE SEWER, WATER, GAS, ELECTRIC AND OTHER UTILITIES, WHICH INTERFERE WITH THE EXECUTION OF THE WORK, SHALL BE REMOVED AND/OR CAPPED, PLUGGED OR OTHERWISE DISCONTINUED AT POINTS WHICH WILL NOT INTERFERE WITH THE EXECUTION OF THE WORK, SUBJECT TO THE APPROVAL OF
- 15. THE AREAS OF THE OWNERS PROPERTY DISTURBED BY THE WORK AND NOT COVERED BY THE BUILDING OR DRIVEWAY, SHALL BE GRADED TO A UNIFORM SLOPE,
- 16. CONTRACTOR SHALL MINIMIZE DISTURBANCE TO EXISTING SITE DURING CONSTRUCTION. EROSION CONTROL MEASURES, SHALL BE IN CONFORMANCE WITH THE LOCAL GUIDELINES FOR EROSION AND SEDIMENT CONTROL.
- ALL BACK FILL SHALL BE COMPACTED TO 95% MODIFIED PROCTOR DENSITY AS DETERMINED BY ASTM STANDARD TEST PROCEDURES.

#### CONSTRUCTION SPECIFICATIONS:

- THE CONTRACTOR SHALL VISIT THE SITE OF THE NEW WORK AND FULLY ACQUAINT THEMSELVES WITH THE CONDITIONS AS THEY EXIST IN ORDER THAT ANY RESTRICTIONS PERTAINING TO THE WORK ARE UNDERSTOOD. ALL AREAS AND DIMENSIONS ARE INDICATED ON THE DRAWINGS AS ACCURATELY AS POSSIBLE, BUT ALL CONDITIONS SHALL BE VERIFIED BY EACH CONTRACTOR AND/OR SUBCONTRACTOR AT THE SITE. THE FAILURE OF THE CONTRACTOR TO EXAMINE OR RECEIVE ANY FORM, INSTRUMENT OR DOCUMENT, OR TO VISIT THE SITE SHALL NOT RELIEVE THE CONTRACTOR FROM ANY OBLIGATION WITH RESPECT TO THEIR QUOTED PRICE. THE SUBMISSION OF A QUOTATION SHALL ACKNOWLEDGE THAT THE CONTRACTOR AND THEIR SUBCONTRACTORS HAVE FULLY EXAMINED THE SITE AND KNOW THE EXISTING CONDITIONS AND HAVE MADE PROVISIONS FOR OPERATING UNDER THE CONDITIONS AS THEY EXIST AT THE SITE AND HAVE INCLUDED ALL NECESSARY ITEMS.
- THE GENERAL CONTRACTOR'S RESPONSIBILITIES SHALL INCLUDE, BUT NOT BE LIMITED TO, CONSTRUCTION OF THE EQUIPMENT FOUNDATION, INCLUDING ELECTRICAL SERVICE, TELEPHONE CONDUITS, GROUNDING SYSTEM AND COORDINATION WITH LOCAL UTILITY COMPANIES.
- 3. THE ANTENNA INSTALLERS RESPONSIBILITIES SHALL INCLUDE, BUT NOT BE LIMITED TO, CABLE TRAY INSTALLATION, ROUTING OF CABLES FROM RADIO EQUIPMENT TO ANTENNAS, ASSOCIATED HARDWARE FOR SECURING ANTENNA CABLES, ANTENNA MOUNTS, DETERMINING SUPPLIER OF ANTENNAS, GROUNDING OF ANTENNAS TO GROUNDING SYSTEM, INSTALLING ANTENNAS AND VERIFYING WITH RADIO FREQUENCY ENGINEERS, THE ALIGNMENT, LOCATION, AND PROPER ORIENTATION OF ANTENNAS.
- 4. THE CONTRACTORS SHALL COORDINATE CONSTRUCTION ACTIVITIES WITH THE BUILDING LANDLORD IN ORDER TO AVOID CONFLICTS WITH CURRENT USE OF THE SITE.
- THE OWNER MAY HAVE WORK PERFORMED UNDER SEPARATE CONTRACTS, CONCURRENTLY, WITH THE WORK OF THIS CONTRACT.
- THE GENERAL CONTRACTOR SHALL PERMIT ACCESS TO THE PROJECT TO THESE CONTRACTORS TO PERFORM THEIR WORK.
- CONTRACTOR SHALL CONFORM TO ALL APPLICABLE LOCAL, COUNTY, STATE, AND FEDERAL CODES, LAWS AND REQUIREMENTS, INCLUDING OSHA.
- 8. THE CONTRACTOR SHALL APPLY AND PAY FOR THE CONSTRUCTION PERMIT, CERTIFICATE OF OCCUPANCY AND ALL OTHER REQUIRED PERMITS OR LICENSES. THE CONTRACTOR IS RESPONSIBLE FOR OBTAINING ALL INSPECTIONS.
- 9. CARE SHALL BE EXERCISED IN PROTECTING THE BUILDING OCCUPANTS DURING THE DEMOLITION AND CONSTRUCTION PERIODS OF THIS PROJECT. EVERY EFFORT SHALL BE MADE TO MAINTAIN A CLEAN OPERATION. DEBRIS SHALL NOT ACCUMULATE. ALL DEBRIS WILL BE DEPOSITED IN A SUITABLE CONTAINER ON A DAILY BASIS AND SHALL BE EMPTIED ON A REGULAR SCHEDULE. THE LOCATION OF THE CONTAINER SHALL BE COORDINATED WITH THE BUILDING MANAGER.
- 10. SAFETY PROCEDURES: ATTENTION IS DIRECTED TO FEDERAL, STATE, AND LOCAL LAWS, RULES AND REGULATIONS CONCERNING CONSTRUCTION SAFETY AND HEALTH STANDARDS. THE CONSTRUCTION COMPANY AWARDED THIS PROJECT SHALL ENSURE ALL WORKING SURROUNDINGS AND CONDITIONS ARE SANITARY AND ARE NOT HAZARDOUS OR DANGEROUS TO THE HEALTH OR SAFETY OF THE WORK CREWS OR BUILDING OCCUPANTS. PRECAUTION SHALL BE EXERCISED AT ALL TIMES FOR THE PROTECTION OF PERSONS AND PROPERTY. IT IS MANDATORY THAT THE SAFETY PROVISIONS OF APPLICABLE LOCAL LAWS, OSHA REGULATIONS AND BUILDING AND CONSTRUCTION CODES, BE OBSERVED FOR ALL CONTRACTORS AND ANTENNA RIGGERS.
- 11. THE GENERAL CONTRACTOR MUST COORDINATE ALL ROOF RELATED WORK WITH THE LANDLORD'S PRE-APPROVED ROOFER. THE GENERAL CONTRACTOR MUST CONFIRM THE COMPATIBILITY OF ALL MATERIALS AND ENSURE THAT ALL EXISTING ROOF WARRANTIES, IF ANY, REMAIN IN EFFECT.





22 SHELTER ROCK LN. BUILDING C DANBURY, CT 06810

#### FULLERTON ENGINEERING DESIGN

1100 E. WOODFIELD ROAD, SUITE 500 SCHAUMBURG, ILLINOIS 60173 TEL: 847-908-8400 www.FullertonEngineering.com

CHI	ECKED BY:	AG	
API	PROVED BY:	AR	
#	DATE	DESCRIPTION	INT.
"	01/13/17	90% REVIEW	KC
	03/14/17	REVISION	KC
	03/28/17	REVISION	KC
	04/03/17	FINAL	KC
		-	1
			1
			T
П			T



SITE NAME

400 BEALE STREET

SITE I.D.

SFX502T

SITE ADDRESS


400 BEALE STREET SAN FRANCISCO, CA 94105

SHEET NAME

**GENERAL NOTES** 

SHEET NUMBER

T-2

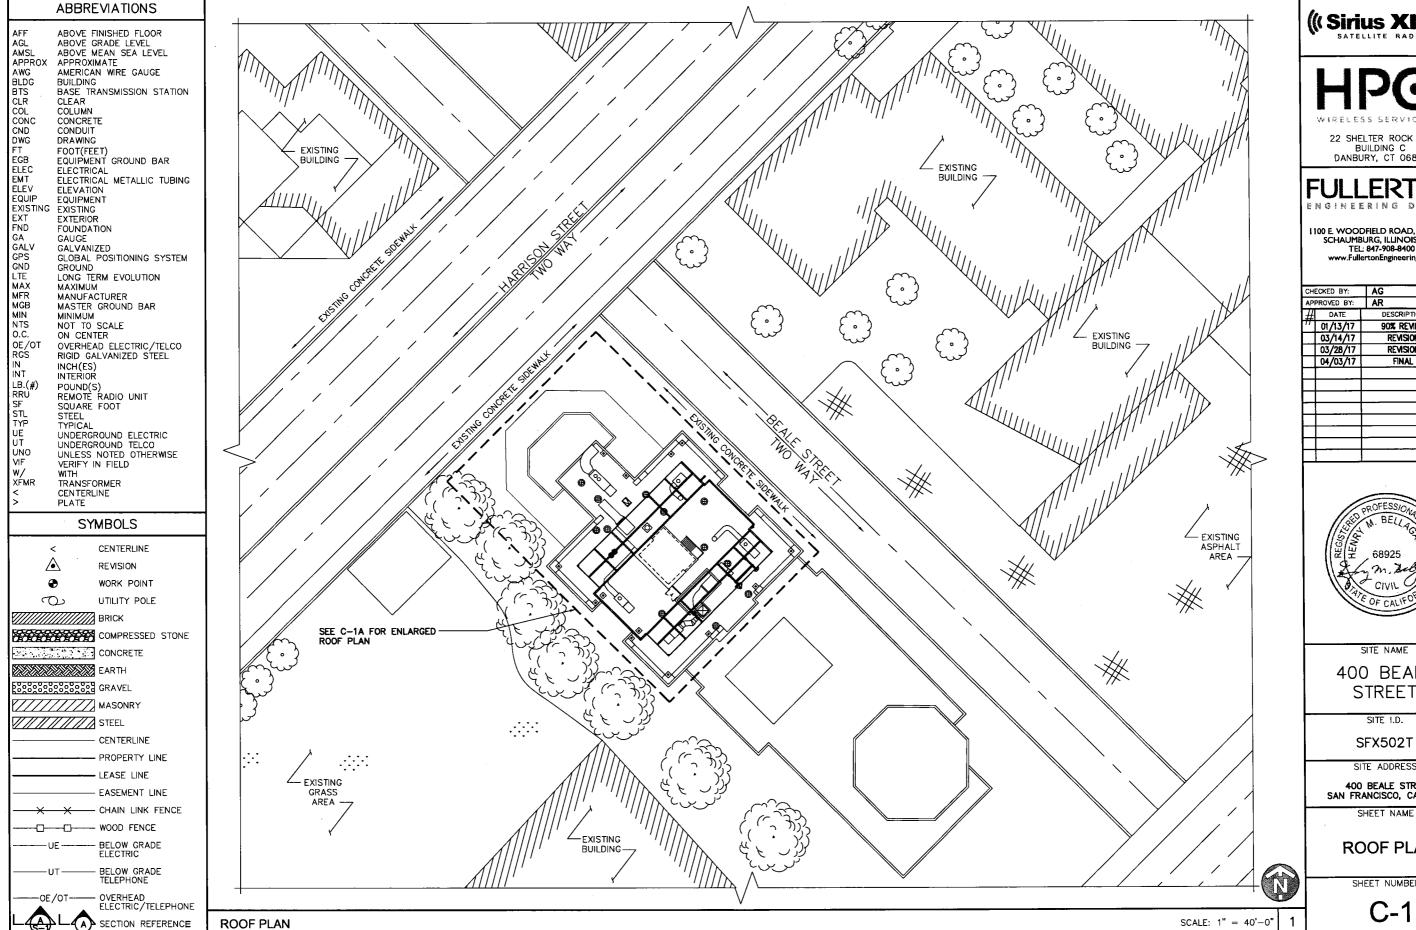





22 SHELTER ROCK LN. BUILDING C DANBURY, CT 06810

#### **FULLERTON** ENGINEERING DESIG

I 100 E. WOODFIELD ROAD, SUITE 500 SCHAUMBURG, ILLINOIS 60173 TEL: 847-908-8400 www.FullertonEngineering.com

CH	ECKED BY:	AG	
ΑP	PROVED BY:	AR	
#	DATE	DESCRIPTION	INT.
11	01/13/17	90% REVIEW	KC
	03/14/17	REVISION	KC
	03/28/17	REVISION	KC
	04/03/17	FINAL	KC
			T
		1	
			$\top$



SITE NAME

400 BEALE STREET

SITE ADDRESS


400 BEALE STREET SAN FRANCISCO, CA 94105

SHEET NAME

**ROOF PLAN** 

SHEET NUMBER

C-1

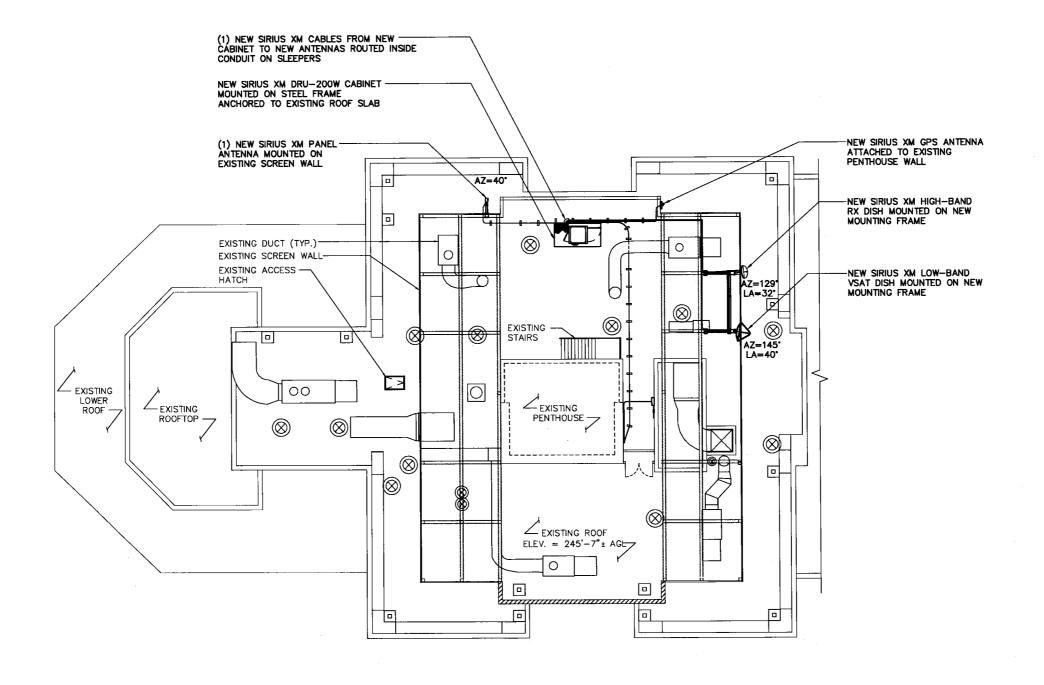





1010 F 4 C C F 2 V 1 T 5 4

22 SHELTER ROCK LN. BUILDING C DANBURY, CT 06810

### **FULLERTON**

ENGINEERING DES

I 100 E. WOODFIELD ROAD, SUITE 500 SCHAUMBURG, ILLINOIS 60173 TEL: 847-908-8400 www.FullertonEngineering.com

CHECKED BY:		AG	
APPROVED BY:		AR	
#	DATE	DESCRIPTION	INT.
77	01/13/17	90% REVIEW	KC
	03/14/17	REVISION	KC
	03/28/17	REVISION	KC
	04/03/17	FINAL	KC
Г			$\top$
Г		·	
Г			丁
Т			1
Г	<del>                                     </del>	•	
Г	<b></b>		$\top$
$\vdash$	<del>                                     </del>		+



SITE NAME

400 BEALE STREET

SFX502T

SITE I.D.

31 A002

SITE ADDRESS

400 BEALE STREET SAN FRANCISCO, CA 94105

SHEET NAME


ENLARGED ROOF PLAN

SHEET NUMBER

C-1A

8

SCALE: 1/16" = 1'-0"

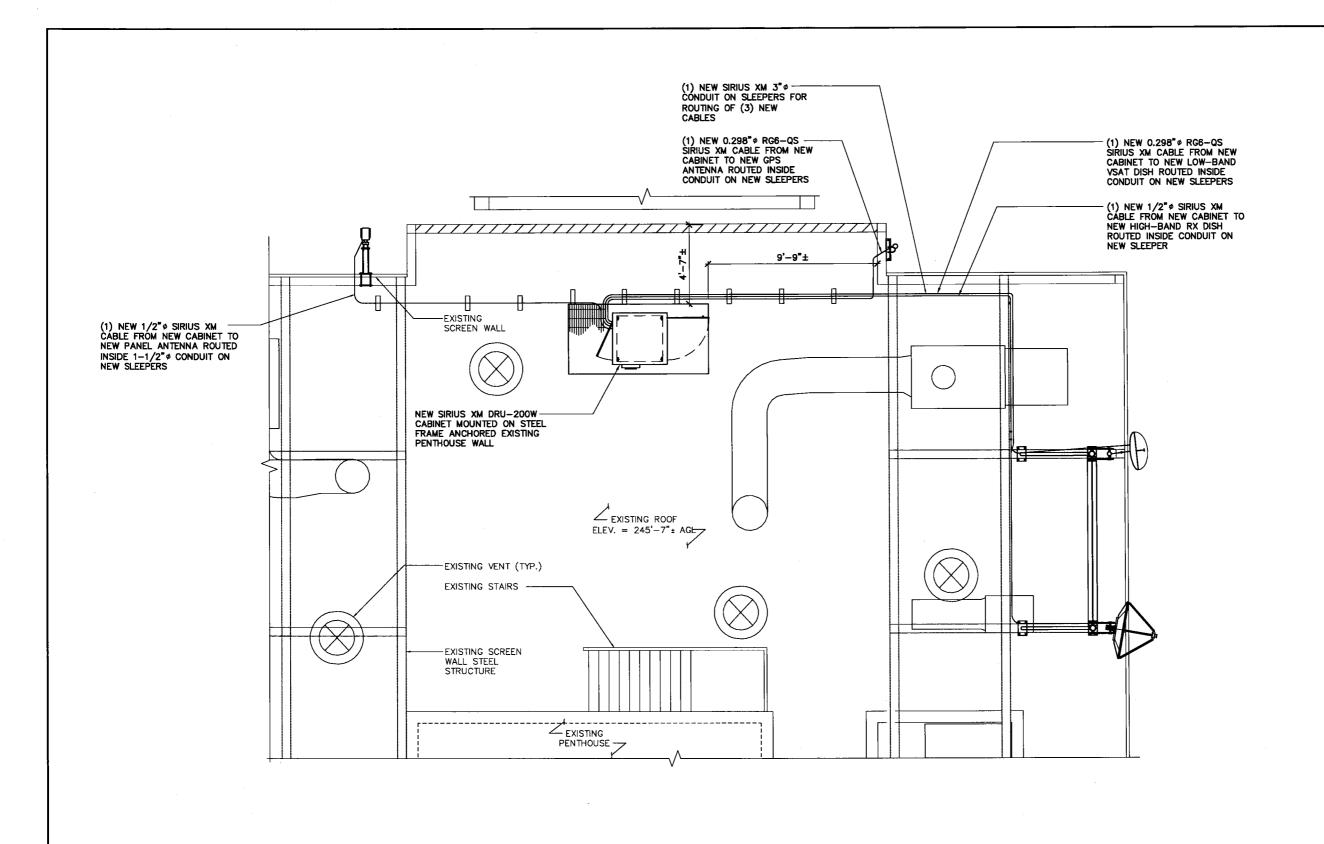

**EXISTING EQUIPMENT LAYOUT** 





22 SHELTER ROCK LN. BUILDING C DANBURY, CT 06810

## ENGINEERING DESIGN

I 100 E. WOODFIELD ROAD, SUITE 500 SCHAUMBURG, ILLINOIS 60173 TEL: 847-908-8400 www.FullertonEngineering.com

CHI	ECKED BY:	AG	
API	PROVED BY:	AR	
:#	DATE	DESCRIPTION	INT
77	01/13/17	90% REVIEW	KC
	03/14/17	REVISION	KC
П	03/28/17	REVISION	КС
	04/03/17	FINAL	KC
Г			丁
Г			
П			
П			$\neg$
Г		_	
Г			
Г			
⊢			<del></del>



SITE NAME

400 BEALE STREET

> SITE I.D. SFX502T

SITE ADDRESS

400 BEALE STREET SAN FRANCISCO, CA 94105

SHEET NAME

**ENLARGED EQUIPMENT** 

**LAYOUT** 

SHEET NUMBER

- ANTENNA NOTES:
  . THE SIZE, HEIGHT, AND DIRECTION OF THE ANTENNA SHALL BE ADJUSTED TO MEET SYSTEM REQUIREMENTS.
- 2. CONTRACTOR SHALL VERIFY HEIGHT OF ANTENNA WITH SIRIUS XM REPRESENTATIVE.
- 3. ALL ANTENNA AZIMUTH TO BE FROM TRUE NORTH.

STRUCTURAL NOTES:
STRUCTURAL CALCULATION PREPARED BY FULLERTON ENGINEERING CONSULTANTS. CONTRACTOR TO COORDINATE WITH SIRIUS XM REPRESENTATIVE TO OBTAIN A COPY.

NEW SIRIUS XM GPS ANTENNA-ATTACHED TO EXISTING NEW SIRIUS XM HIGH-BAND PENTHOUSE WALL RX DISH MOUNTED ON NEW (1) NEW SIRIUS XM PANEL -ANTENNA MOUNTED ON EXISTING SCREEN WALL MOUNTING FRAME NEW SIRIUS XM LOW-BAND VSAT DISH MOUNTED ON NEW MOUNTING FRAME T/NEW SIRIUS XM GPS ANTENNA ELEV. = 266'-0"± AGL -EXISTING SCREEN WALL ◆T/EXISTING PENTHOUSE ELEV. = 268'-11" AGL & OF NEW SIRIUS XM PANEL ANTENNA, HIGH-BAND &
LOW-BAND RX DISHES
ELEV. =264'-0"± AGL ◆T/EXISTING ROOF ELEV. = 249'-7" AGL NEW SIRIUS XM DRU200

CABINET MOUNTED ON STEEL
FRAME ANCHORED TO EXISTING EXISTING BUILDING-◆T/GRADE ELEV. = ± 50'-6" AGL ◆T/GRADE ELEV. = 0'-0" AGL





22 SHELTER ROCK LN. BUILDING C DANBURY, CT 06810

#### **FULLERTON** ENGINEERING DESIGN

I 100 E. WOODFIELD ROAD, SUITE 500 SCHAUMBURG, ILLINOIS 60173 TEL: 847-908-8400 www.FullertonEngineering.com

CHECKED BY:		HECKED BY: AG	
APPE	ROVED BY: AR		
#	DATE	DESCRIPTION	INT.
"	01/13/17	90% REVIEW	KC
П	03/14/17	REVISION	KC
	03/28/17	REVISION	KC
П	04/03/17	FINAL	KC
П		*	
	Í		1
Н		•	
$\vdash$ †			-
Н	1		
$\vdash$			$\neg$
1			$\top$
$\vdash$			



SITE NAME

400 BEALE STREET

SITE I.D.

SFX502T

SITE ADDRESS

400 BEALE STREET SAN FRANCISCO, CA 94105

SHEET NAME


SITE ELEVATION

SHEET NUMBER

NORTHWEST ELEVATION

SCALE: N.T.S.

FEC# 2015.0042.0025

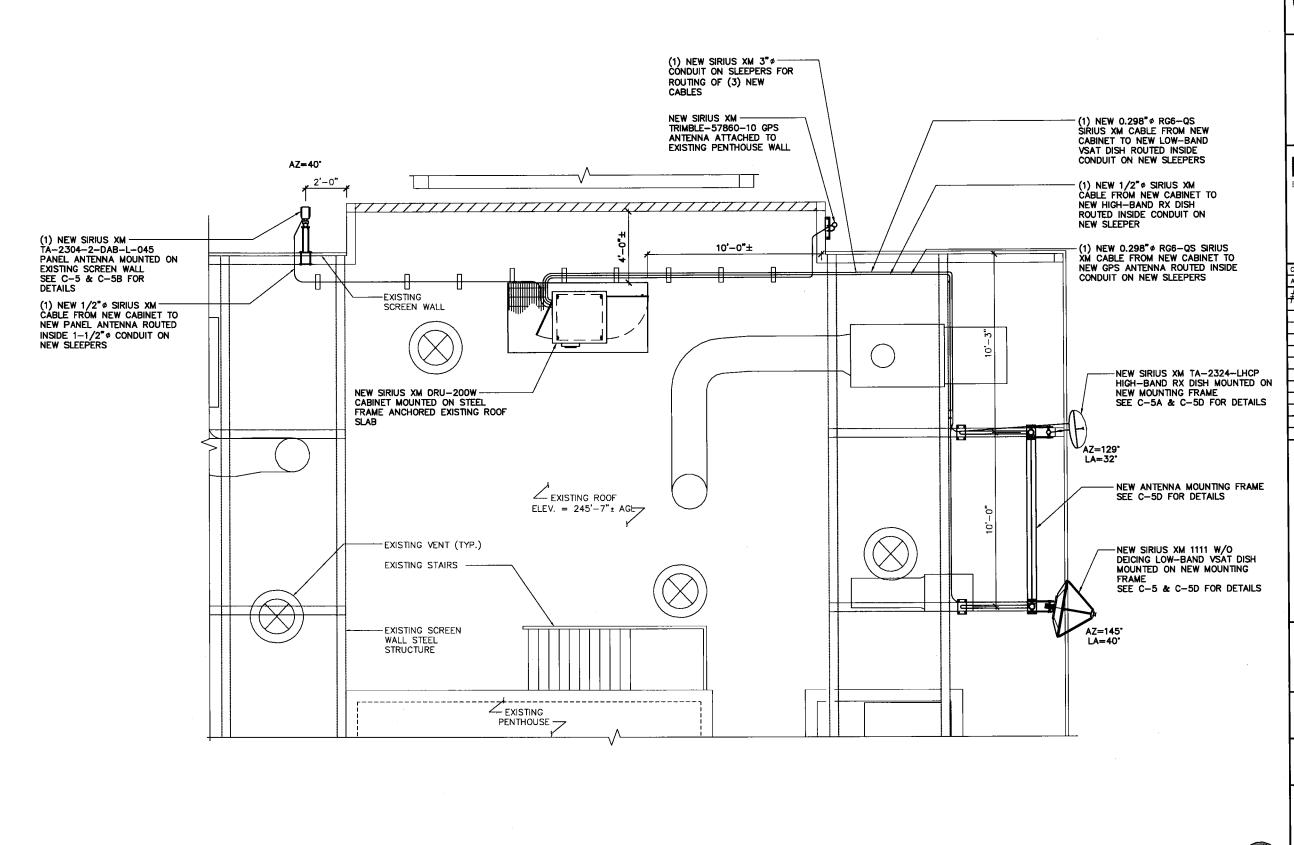

**NEW ANTENNA LAYOUT** 

((Sirius XM))



22 SHELTER ROCK LN. BUILDING C DANBURY, CT 06810

#### FULLERTON ENGINEERING DESIGN

I 100 E. WOODFIELD ROAD, SUITE 500 SCHAUMBURG, ILLINOIS 60173 TEL: 847-908-8400 www.FullertonEngineering.com

011	FOUED DV	140	
CH	ECKED BY:	AG	
AP	PROVED BY:	AR	
#	DATE	DESCRIPTION	IN.
77	01/13/17	90% REVIEW	K
	03/14/17	REVISION	K
	03/28/17	REVISION	K
	04/03/17	FINAL	K
			丁



SITE NAME

400 BEALE STREET

SITE I.D.

SFX502T

SITE ADDRESS


400 BEALE STREET SAN FRANCISCO, CA 94105


SHEET NAME


ANTENNA LAYOUTS

SHEET NUMBER

C-Z

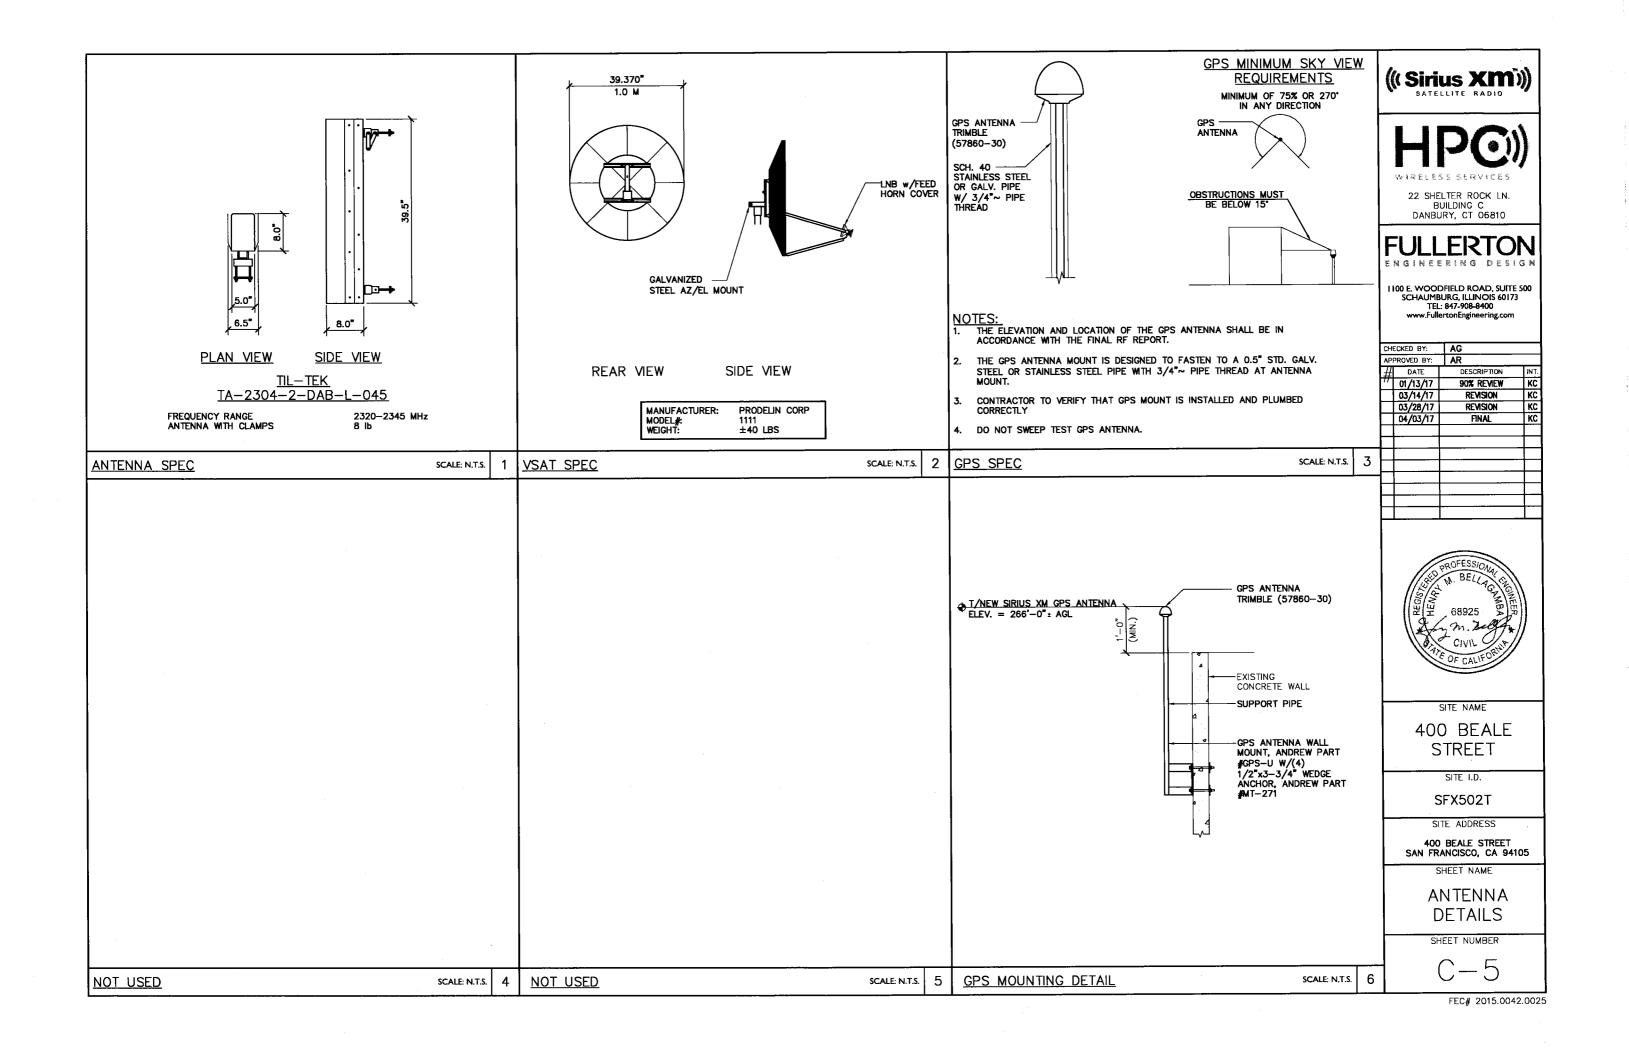

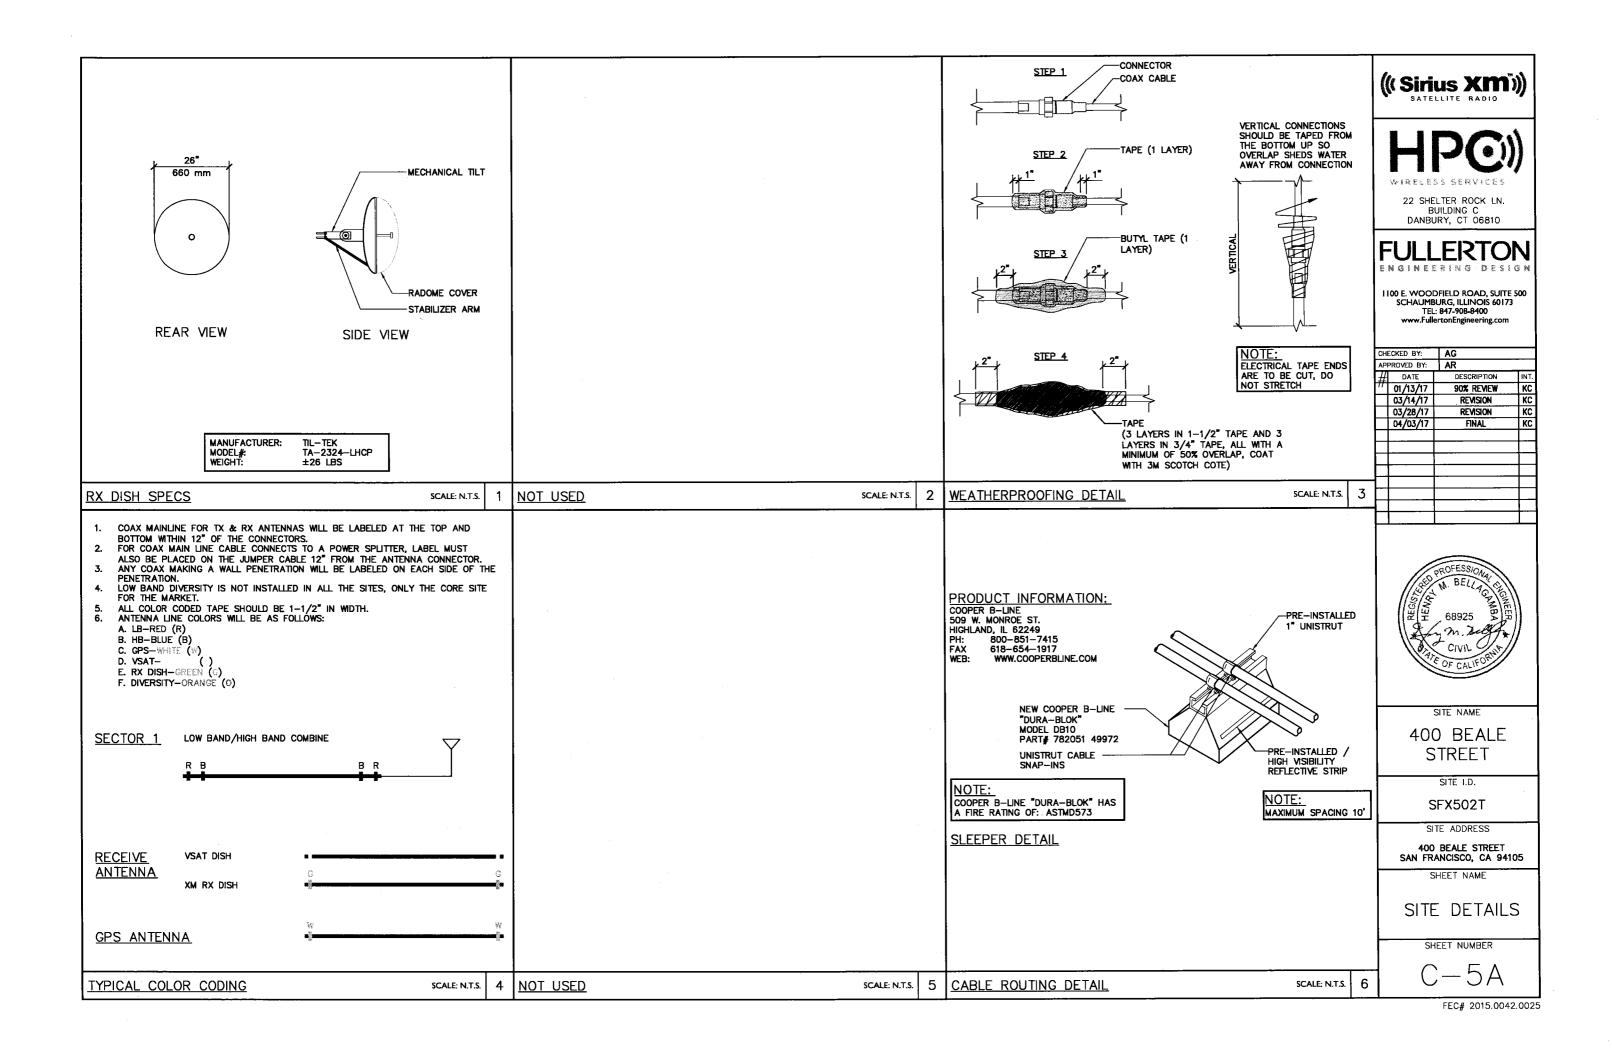

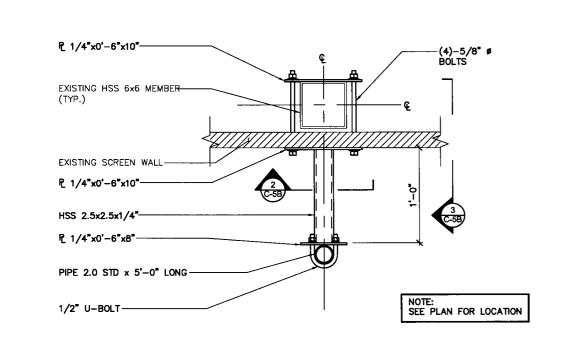


NEW MOUNTING STRUCTURE PLAN VIEW


NEW MOUNTING STRUCTURE ELEVATION VIEW

SCALE: 1" = 1'-0" 1

SCALE: 1-1/2" = 1'-0"

SECTION VIEW

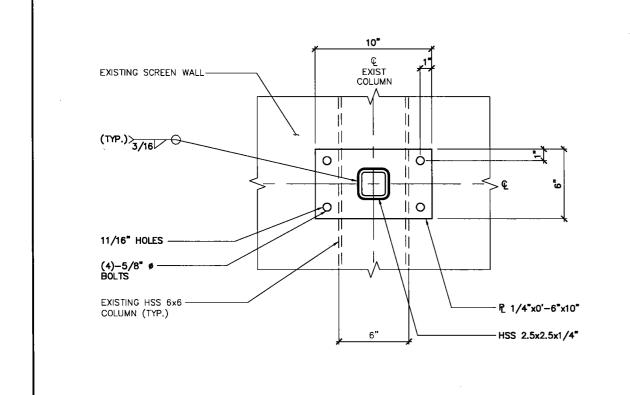

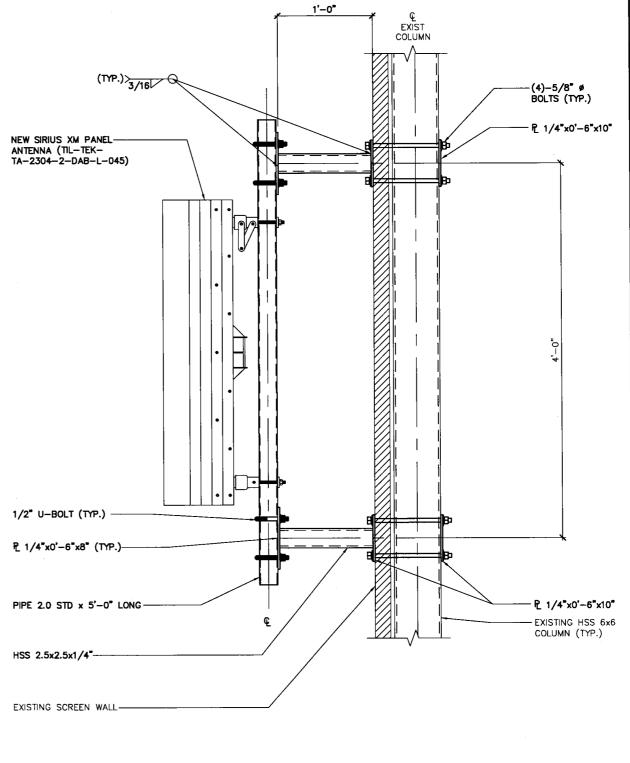

((Sirius XM))



22 SHELTER ROCK LN. BUILDING C DANBURY, CT 06810

## FULLERTON

1100 E. WOODFIELD ROAD, SUITE 500 SCHAUMBURG, ILLINOIS 60173 TEL: 847-908-8400 www.FullertonEngineering.com

_			
CH	ECKED BY:	AG	
AP	PROVED BY:	AR	
#	DATE	DESCRIPTION	INT.
"	01/13/17	90% REVIEW	KC
	03/14/17	REVISION	KC
	03/28/17	REVISION	KC
	04/03/17	FINAL	KC
			T
		•	
ĺ			



SITE NAME

400 BEALE STREET

SITE I.D.

SFX502T

SITE ADDRESS

400 BEALE STREET SAN FRANCISCO, CA 94105


SHEET NAME


MOUNTING DETAILS

SHEET NUMBER

C-5B

SCALE: 1" = 1'-0" | 3

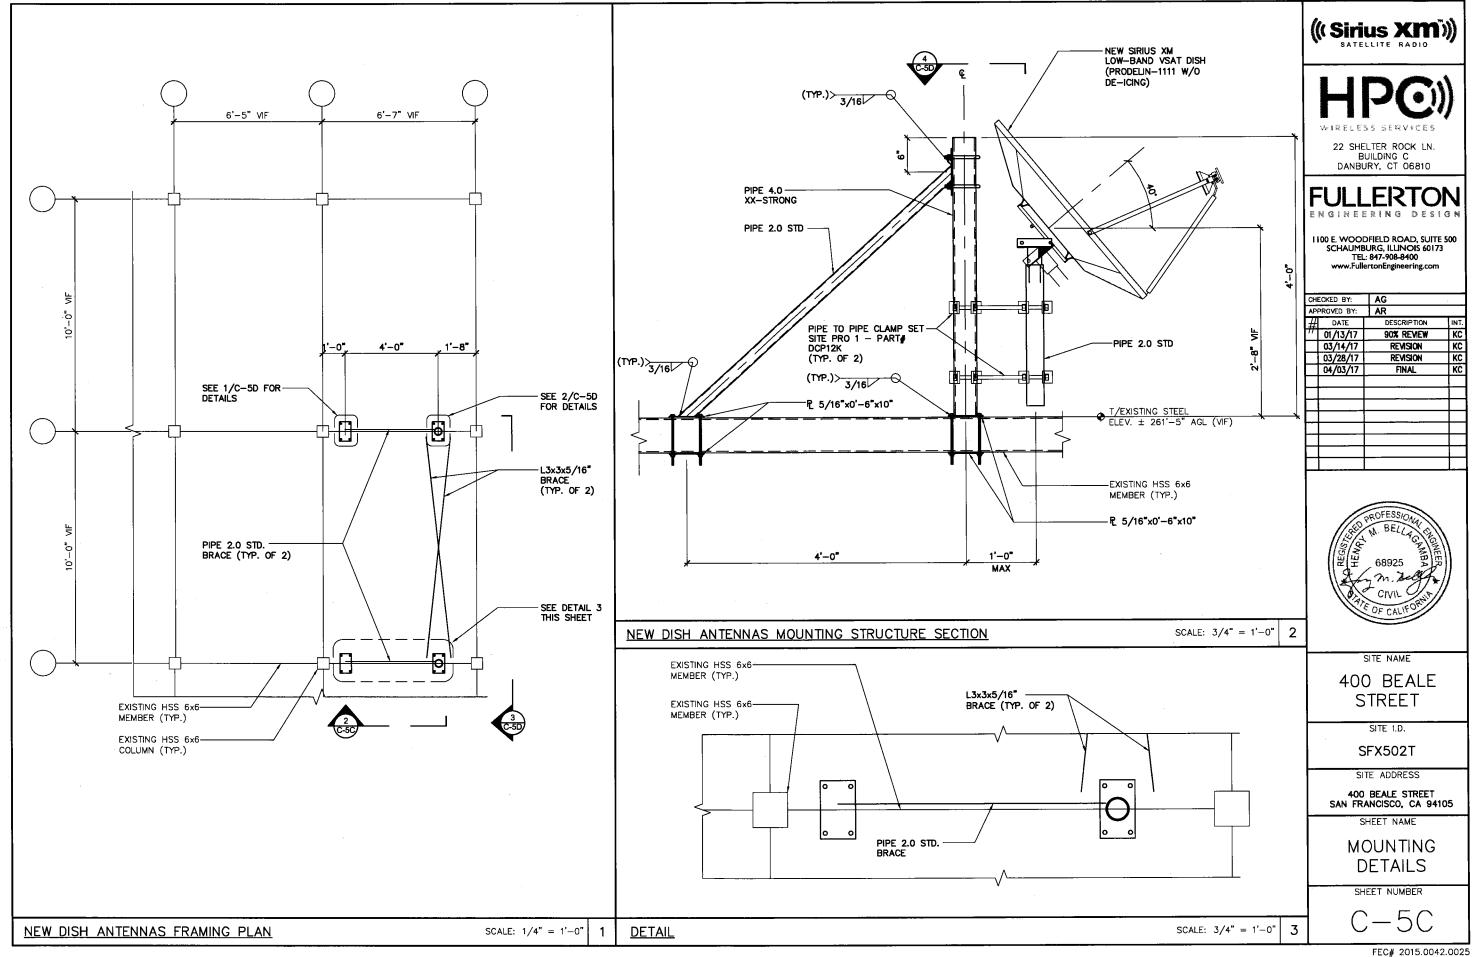

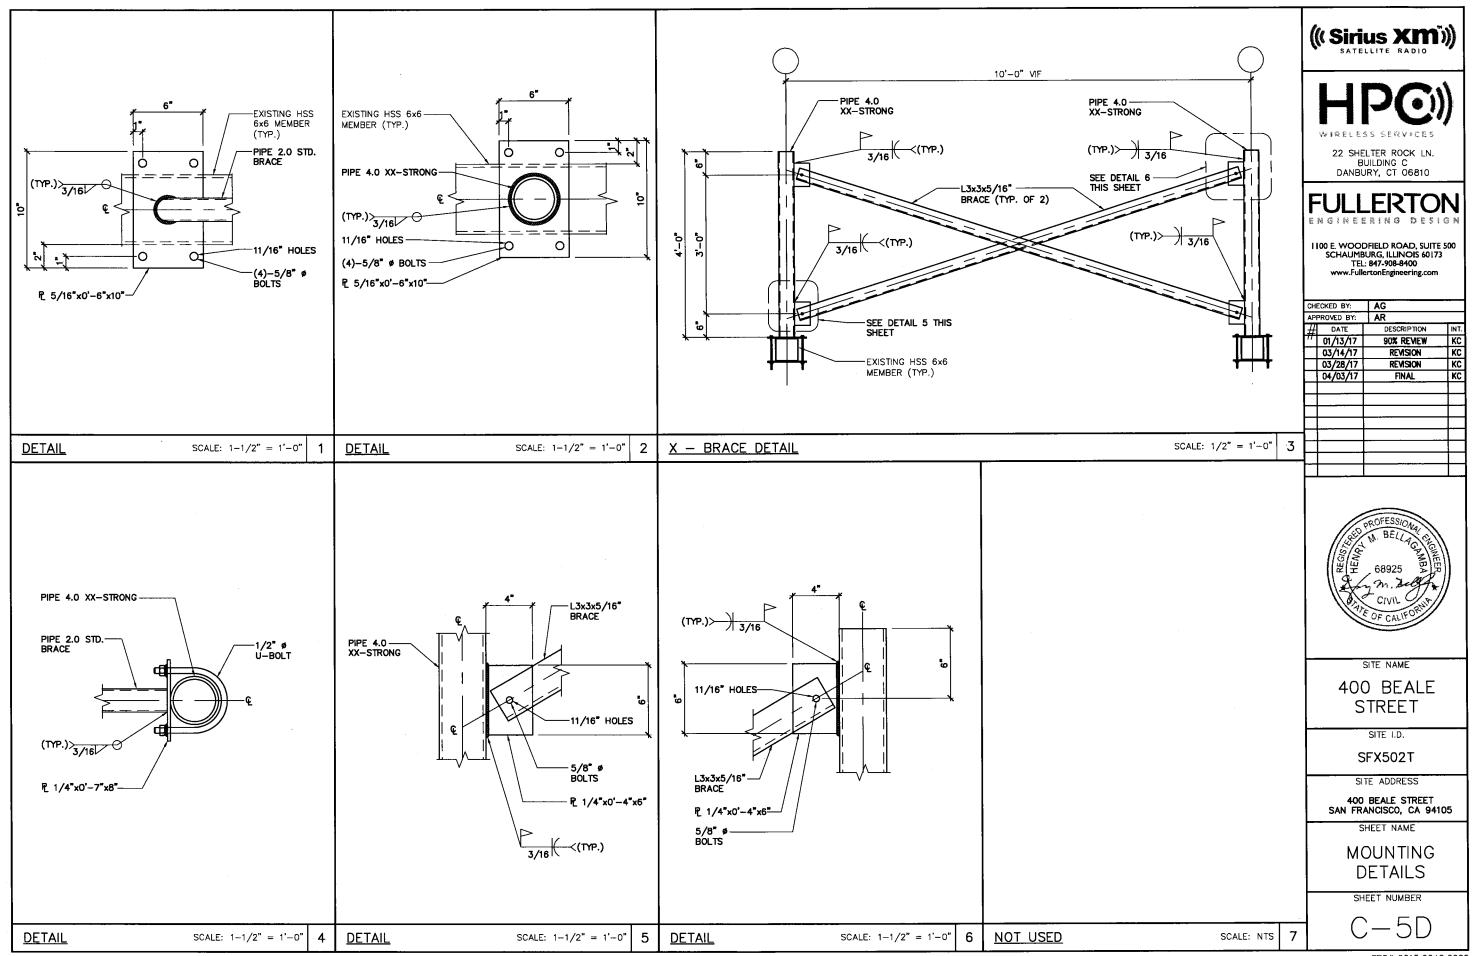

				NEW AI	NTENNA (	CONFIGU	RATION				
				CA	ABLE						
ANTENNA NUMBER	NEW OR EXISTING	ANTENNA MANUFACTURER	ANTENNA TYPE	MODEL NUMBER	AZIMUTH (TN)		© OF ANTENNA FROM GROUND LEVEL (FT)	NEW OR EXISTING	CABLE TYPE	CABLE SIZE (DIA. IN)	CABLE LENGTH (FT)
1	NEW	TIL-TEK	PANEL	TA-2304-2-DAB-L-045	40°	0.	264'	NEW	LDFR-50A	1/2"	45'
2	NEW	PRODELIN	VSAT	1111 W/O DE-ICING	145*	40°	264'	NEW	RG6-QS	0.298"	75'
3	NEW	TILTEK	RX	TA-2324-LHCP	129*	32.	264'	NEW	LDF4-50A	1/2"	60'
4	NEW	TRIMBLE	GPS	57860-30	N/A	N/A	266'	NEW	RG6-QS	.298	50'





22 SHELTER ROCK LN. BUILDING C DANBURY, CT 06810

### FULLERTON

1100 E. WOODFIELD ROAD, SUITE 500 SCHAUMBURG, ILLINOIS 60173 TEL: 847-908-8400 www.FullertonEngineering.com

ı			
СН	ECKED BY:	AG	
ΑP	PROVED BY:	AR	
#	DATE	DESCRIPTION	INT.
"	01/13/17	90% REVIEW	KC
Г	03/14/17	REVISION	KC
Г	03/28/17	REVISION	KC
Г	04/03/17	FINAL	KC
Г			
Г			
Г		•	
			$\neg$



SITE NAME

400 BEALE STREET

SITE I.D.

SFX502T

SITE ADDRESS

400 BEALE STREET SAN FRANCISCO, CA 94105

SHEET NAME


ANTENNA SCHEDULES


SHEET NUMBER

C - 6


### NEW EQUIPMENT SCHEDULE

CABINET NUMBER	CABINET MANUFACTURER	CABINET TYPE	MODEL NUMBER	NOTES	
HOMBER	WITHOUT TO TOTALIN	111 -	NOMBLIX		C
	UBS	REPEATER	DRU200W		Af
l '	065	REPEATER	DRU-200#		
				NEW DOWED COLLEDING	
				NEW POWER SCHEDULE	
AMPERE	VOLTAGE	PHASE	NOTES		
WALL FIVE	VOLINOL	THASE	HOILS		
40 AMPS	208/120V	7	LITHIZE EVICTING DANE	IL INSIDE ELECTRICAL ROOM ON 26TH FLOOR	
TO AMICS	200/1204	, ,	UTILIZE EXISTING PANE	L INSIDE ELECTRICAL ROOM ON 2011 FLOOR	
					F-

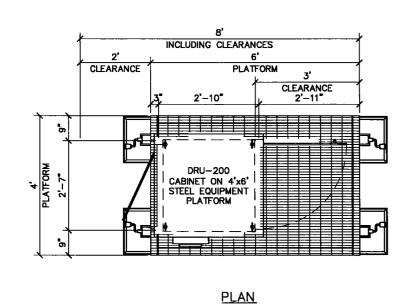

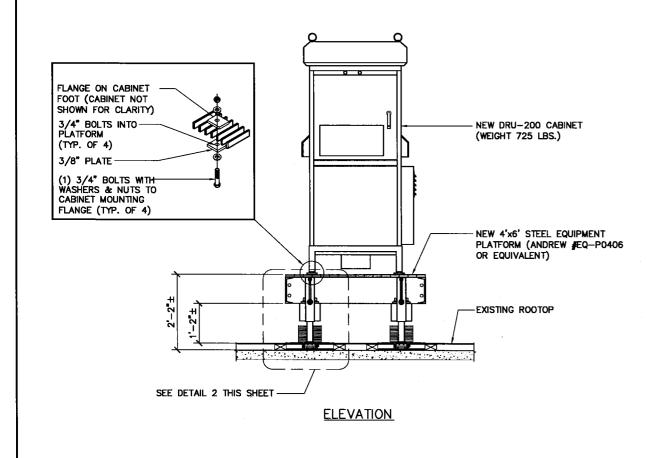

UBS DRU-200W CABINET DETAIL

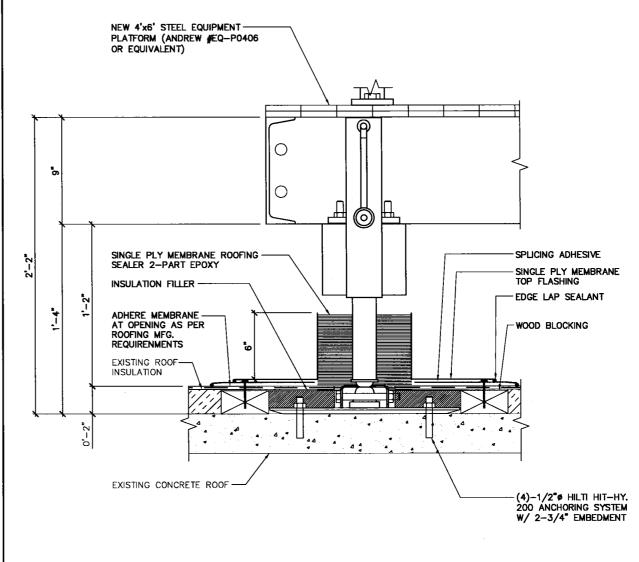





INFLESS SERVICES

22 SHELTER ROCK LN. BUILDING C DANBURY, CT 06810

### FULLERTON

NGINEERING DES

1100 E. WOODFIELD ROAD, SUITE 500 SCHAUMBURG, ILLINOIS 60173 TEL: 847-908-8400 www.FullertonEngineering.com

CKED BY:	AG	
PROVED BY:	AR	
DATE	DESCRIPTION	ΙΝΊ
01/13/17	90% REVIEW	K
03/14/17	REVISION	K
03/28/17	REVISION	K
04/03/17	FINAL	K
		Т
	DATE 01/13/17 03/14/17	PROVED BY: AR  DATE DESCRIPTION 01/13/17 90% REVIEW 03/14/17 REVISION 03/28/17 REVISION



SITE NAME

400 BEALE STREET

SITE I.D.

SFX502T

SITE ADDRESS

400 BEALE STREET SAN FRANCISCO, CA 94105

SHEET NAME

EQUIPMENT SPECS

SHEET NUMBER

SCALE: N.T.S.

C-7

SCALE: 3/8" = 1'-0"

#### **SERVICE EQUIPMENT NOTES:**

- ALL ELECTRICAL EQUIPMENT SHALL BE LABELED WITH PERMANENT ENGRAVED PLASTIC LABELS
- 2. PATCH, REPAIR AND PAINT ANY AREA THAT HAS BEEN DAMAGED IN THE COURSE OF THE ELECTRICAL WORK

#### **CONDUCTOR NOTES:**

FINAL UTILITY PLAN

- 1. ALL CONDUCTORS SHALL BE COPPER
- 2. ALL WRING SHALL BE COPPER WITH THHN/THWN DUAL RATED 600 VOLTS INSULATION
- 3. GROUNDING CONDUCTORS SHALL BE SOLID TINNED COPPER UNLESS OTHERWISE NOTED

#### **CONDUIT NOTES:**

- 1. SCH 80 PVC CONDUIT SHALL BE USED WHEN INSTALLED IN OR UNDER CONCRETE SLABS, IN CONTACT WITH EARTH. OR EXPOSED ABOVE GRADE
- 2. EMT SHALL BE USED ONLY FOR INTERIOR RUNS AND SHALL HAVE COMPRESSION TYPE FITTINGS
- 3. SEAL TIGHT, FLEXIBLE CONDUIT MAY BE USED WHERE CODE PERMITS. ALL CONDUIT SHALL HAVE FULL SIZE EQUIPMENT GROUND WIRE
- 4. SERVICE CONDUITS SHALL HAVE NO MORE THAN (3) 90' BENDS IN ANY SINGLE RUN. THE CONTRACTOR SHALL PROVIDE PULL BOXES AS NEEDED WHERE CONDUIT REQUIREMENTS EXCEED THESE CONDITIONS
- ALL CABLES, POWER AND/OR TELEPHONE AND/OR FIBER SYSTEM CONDUITS SHALL HAVE A MINIMUM 24" RADIUS SWEEPS TO EQUIPMENT, PULL BOXES, ETC., UNLESS OTHERWISE NOTED, OR AS REQUIRED BY UTILITY COMPANIES

#### **NEW CABLE GROUNDING NOTES:**

- AVOID DISRUPTION OF EXISTING GROUNDING SYSTEM.
  REPAIR ANY DAMAGE TO THE SATISFACTION OF THE OWNER
- CONTRACTOR SHALL CONNECT GROUND KITS TO THE EXISTING GROUND BARS AT THE TOP AND BASE OF TOWER
- 3. CONTRACTOR SHALL CONNECT GROUND KITS TO THE NEW GROUND BAR BEFORE ENTRY TO CABINET
- 4. NO BACK TO BACK LUGGING OF GROUNDS

#### **GENERAL GROUNDING NOTES:**

- VERTICAL DROPS SHALL BE 20'-0" OF #2 AWG SOLID TINNED COPPER WIRE. CADWELD TO GROUND BAR
- 2. ALL BENDS MINIMUM 8" RADIUS
- 3. APPLY ANTI-OXIDATION COMPOUND TO ALL CONNECTIONS
- 4. BARE COPPER CONDUCTORS SHALL NOT BE IN CONTACT WITH ANY DISSIMILAR MATERIAL PLACE ON STANDOFFS, IF NECESSARY TO ALLOW FOR PROPER INSTALLATION
- SHARP BENDS IN GROUNDING CONDUCTORS SHALL BE AVOIDED. 90° BENDS SHALL NOT BE USED
- 6. ALL GROUNDING CONDUCTORS SHALL BE KEPT AS SHORT AS POSSIBLE. THE SHORTEST PRACTICAL ROUTE SHALL BE CHOSEN WITH THE LEAST AMOUNT OF BENDS AND SPLICES. USE THIS RULE AT ALL TIMES
- 7. ALL CONNECTIONS TO GROUND BARS SHALL BE WITH A 2-HOLE LUG UNLESS OTHERWISE SPECIFIED
- 8. WHEN GROUNDING MORE THAN ONE PIECE OF EQUIPMENT, DO NOT USE THE EQUIPMENT AS A GROUNDING CONDUCTOR. DOUBLE-STACKING OF LUGS SHALL BE USED TO GET FROM EQUIPMENT TO EQUIPMENT

((Sirius XM))



22 SHELTER ROCK LN. BUILDING C DANBURY, CT 06810

#### FULLERTON ENGINEERING DESIGN

I 100 E. WOODFIELD ROAD, SUITE 500 SCHAUMBURG, ILLINOIS 60173 TEL: 847-908-8400 www.FullertonEngineering.com

-	CHI	ECKED BY:	AG	
	API	PROVED BY:	AR	
	#	DATE	DESCRIPTION	INT.
	77	01/13/17	90% REVIEW	KC
		03/14/17	REVISION	KC
		03/28/17	REVISION	KC
		04/03/17	FINAL	KC
	Г		•	
	Г			
	П			
	П			



SITE NAME

400 BEALE STREET

SITE I.D.

SFX502T

-----

SITE ADDRESS

400 BEALE STREET SAN FRANCISCO, CA 94105

SHEET NAME

UTILITY PLAN AND NOTES


SHEET NUMBER

SCALE: 1/8" = 1'-0"

E-1

9. REMOVE ALL PAINT BENEATH THE SURFACE OF GROUND LUGS **ELECTRICAL NOTES** SCALE: N.T.S. CONTRACTOR TO VERIFY AVAILABILITY OF EXISTING CONDUIT AND REUSE EXISTING WHEN POSSIBLE SCREEN WALL NEW SIRIUS XM DRU-200W CABINET-MOUNTED ON STEEL FRAME ANCHORED TO EXISTING ROOF SLAB EXISTING ELECTRICAL ROOM AT 26TH FLOOR EXISTING BELOW VENT (TYP.) NEW SIRIUS XM DISTRIBUTION PANEL LOCATED INSIDE ELECTRICAL ROOM ON 26TH FLOOR BELOW ROUTE CONDUIT ON SLEEPERS AND ALONG PENTHOUSE WALL
SEE E-1A FOR CONTINUATION NEW ROOF PENETRATION FOR ROUTING OF NEW CONDUIT DOWN TO ELECTRICAL ROOM BELOW SEE E1-A FOR CONTINUATION ← EXISTING PENTHOUSE: EXISTING ENCLOSURE WITH ELEVATOR POWER EQUIPMENT (AT ROOF LEVEL)

NOTE: CONTRACTOR TO VERIFY AVAILABILITY OF EXISTING CONDUIT AND REUSE WHEN POSSIBLE

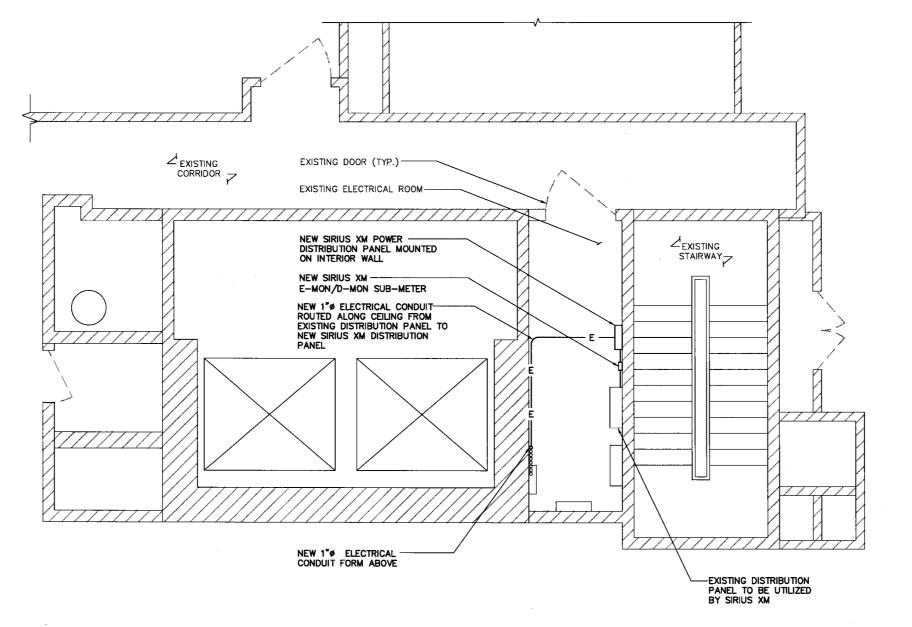





22 SHELTER ROCK LN. BUILDING C DANBURY, CT 06810

### **FULLERTON**

1100 E. WOODHELD ROAD, SUITE 500 SCHAUMBURG, ILLINOIS 60173 TEL: 847-908-8400 www.FullertonEngineering.com

СH	ECKED BY:	AG	
AP	PROVED BY:	AR	
#	DATE	DESCRIPTION	INT.
11	01/13/17	90% REVIEW	KC
	03/14/17	REVISION	KC
	03/28/17	REVISION	KC
	04/03/17	FINAL	КС
			$\top$
			1



SITE NAME

400 BEALE STREET

SITE I.D.

SFX502T

SITE ADDRESS

400 BEALE STREET SAN FRANCISCO, CA 94105

SHEET NAME

UTILITY PLAN AND NOTES


SHEET NUMBER

F-1A

(Ž

FINAL UTILITY PLAN

SCALE: 1/8" = 1'-0"

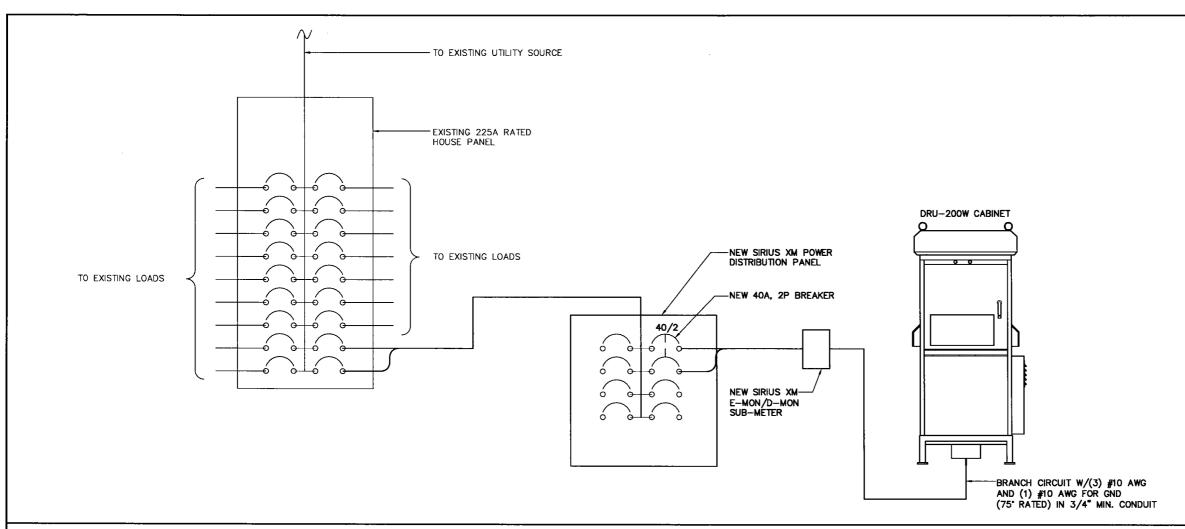

(( Sirius XM))


HPO)

22 SHELTER ROCK LN. BUILDING C DANBURY, CT 06810

### **FULLERTON**

I 100 E. WOODHELD ROAD, SUITE 500 SCHAUMBURG, ILLINOIS 60173 TEL: 847-908-8400 www.FullertonEngineering.com

CHI	ECKED BY:	AG	
API	PROVED BY:	AR	
#	DATE	DESCRIPTION	INT.
11	01/13/17	90% REVIEW	КС
	03/14/17	REVISION	KC
	03/28/17	REVISION	КС
	04/03/17	FINAL	KC
			$\neg$
			一
			$\neg$
_			
			_

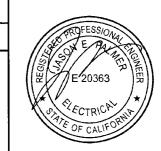

SITE NAME

400 BEALE STREET

SITE I.D.

SFX502T

SITE ADDRESS

400 BEALE STREET SAN FRANCISCO, CA 94105

SHEET NAME FINAL SINGLE LINE DIAGRAM/

PANEL SCHED.

E-2


FINAL SINGLE LINE DIAGRAM  SCALE N.T.S. 1
---

SITE NUN	IBER:	SFX502T				MODEL N	UMBER:	TBD							
OLTAGE		240V/120				PHASE:		3		WIRE:			4		
IAIN BRE	EAKER:	225AMP M	LO			BUSS RA	TING:	225 AMPS	;	AIC:			10,000		
MOUNT:		SURFACE				NEUTRAL	BAR:	YES		GROUND	BAR:		YES		
ENCLOSE	IRE TYPE:	NEMA 1				N to GRO	UND BOND	YES							
ANEL ST	TATUS:	EXISTING	·			INTERNAL	.TVSS:	YES						A	
CKT	LOAD DESCRIPTION	BREAKER AMPS	BREAKER POLES	BREAKER STATUS	SERVICE LOAD VA	1		PHASE B VA			BREAKER STATUS	BREAKER POLES	BREAKER AMPS	LOAD DESCRIPTION	СКТ
1	TELEPHONE BOARD PLUGS	20	1	ON	200	1.00	490	-	1.00	200	ON	1	20	TELEPHONE BOARD PLUGS	2
3	TELEPHONE BOARD PLUGS	20	1	ON	200	1.00		400	1.08	200	ON	1	20	TELEPHONE BOARD PLUGS	4
5	TELEPHONE BOARD PLUGS	20	1	ON	200	1.00	490		1.00	200	ON	1	26	SPARE	6
7	SPARE	20	1	ON	200	1.00	-	400	1.00	200	ON	1	20	SPARE	8
9	SPACE	-		_	0	0.00	0		0.00	0	_	-	***	SPACE	10
11	SPACE	-	_	-	0	0.00		0	0.00	0	_	-	-	SPACE	12
13	SPACE	_	_	_	0	9.00	0		0,00	0	_	_	_	SPACE	14
15	TEMP POWER	40	2	ON	2194	1.25		2742.5	0.00	0	_	_	_	SPACE	16
17		_	_	N/A	2194	1.25	2743		00,0	0	_	_	_	SPACE	18
	5 10 15 20 20											717			
		a barana	2.25				3543	3543	VA			TOTAL KVA	7.09		
	MIGRATION PERIOD LOADING						3343	3343	YA	j		AMPS	29.52		$\dashv$

FINAL PANEL SCHEDULE

SCALE: N.T.S. 2

FEC# 2015.0042.0025

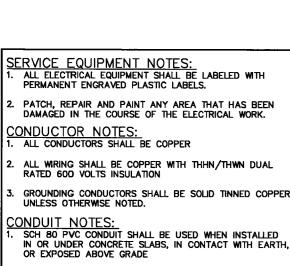

## SCH 80 PVC CONDUIT SHALL BE USED WHEN INSTALLED IN OR UNDER CONCRETE SLABS, IN CONTACT WITH EARTH,


- 2. EMT SHALL BE USED ONLY FOR INTERIOR RUNS AND SHALL HAVE COMPRESSION TYPE FITTINGS
- SEAL TIGHT, FLEXIBLE CONDUIT MAY BE USED WHERE CODE PERMITS. ALL CONDUIT SHALL HAVE FULL SIZE EQUIPMENT GROUND WIRE
- SERVICE CONDUITS SHALL HAVE NO MORE THAN (3) 90' BENDS IN ANY SINGLE RUN. THE CONTRACTOR SHALL PROVIDE PULL BOXES AS NEEDED WHERE CONDUIT REQUIREMENTS EXCEED THESE CONDITIONS
- ALL CABLES, POWER AND/OR TELEPHONE AND/OR FIBER SYSTEM CONDUITS SHALL HAVE A MINIMUM 24" RADIUS SWEEPS TO EQUIPMENT, PULL BOXES, ETC., UNLESS OTHERWISE NOTED, OR AS REQUIRED BY UTILITY

#### NEW CABLE GROUNDING NOTES

- AVOID DISRUPTION OF EXISTING GROUNDING SYSTEM.
  REPAIR ANY DAMAGE TO THE SATISFACTION OF THE
- 2. CONTRACTOR SHALL CONNECT GROUND KITS TO THE EXISTING GROUND BARS AT THE TOP AND BASE OF
- CONTRACTOR SHALL CONNECT GROUND KITS TO THE NEW GROUND BAR BEFORE ENTRY TO CABINET
- 4. NO BACK TO BACK LUGGING OF GROUNDS

#### **GENERAL GROUNDING NOTES:**

- VERTICAL DROPS SHALL BE 20"-0" OF #2 AWG SOLID TINNED COPPER WIRE. CADWELD TO GROUND BAR.
- 2. ALL BENDS MINIMUM 8" RADIUS.
- 3. APPLY ANTI-OXIDATION COMPOUND TO ALL CONNECTIONS.
- 4. BARE COPPER CONDUCTORS SHALL NOT BE IN CONTACT WITH ANY DISSIMILIAR MATERIAL PLACE ON STANDOFFS, IF NECESSARY TO ALLOW FOR PROPER INSTALLATION.
- SHARP BENDS IN GROUNDING CONDUCTORS SHALL BE AVOIDED, 90° BENDS SHALL NOT BE USED.
- 5. ALL GROUNDING CONDUCTORS SHALL BE KEPT AS SHORT AS POSSIBLE. THE SHORTEST PRACTICAL ROUTE SHALL BE CHOSEN WITH THE LEAST AMOUNT OF BENDS AND SPLICES. USE THIS RULE AT ALL TIMES.
- ALL CONNECTIONS TO GROUND BARS SHALL BE WITH A 2-HOLE LUG UNLESS OTHERWISE SPECIFIED.
- WHEN GROUNDING MORE THAN ONE PIECE OF EQUIPMENT. DO NOT USE THE EQUIPMENT AS A GROUNDING CONDUCTOR. DOUBLE-STACKING OF LUGS SHALL BE USED TO GET FROM EQUIPMENT TO EQUIPMENT.
- 9. REMOVE ALL PAINT BENEATH THE SURFACE OF GROUND
- 10. GROUND SYSTEM TO BE TESTED TO 5 OHMS OR LESS

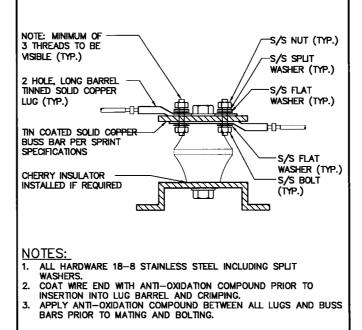

GROUND LUG DETAIL

SCALE: N.T.S.

COAX CABLE WEATHERPROOFING KITS GROUNDING STRAP KITS SCREW ON LUG ATTACHED TO GROUNDING WIRE GROUND WIRE

• DO NOT INSTALL CABLE GROUND KIT AT A BEND AND ALWAYS DIRECT GROUND WIRE DOWN TO GROUND BAR.

THIS DETAILS IS TYPICAL FOR EACH CABLE WHERE IT IS SPECIFIED TO BE GROUNDED

COAX GROUND KIT

ANTENNA

MOUNTING PIPE (TYP.)

SCALE: N.T.S.

SCALE: N.T.S.

4 DATE DESCRIPTION 01/13/17 90% REVIEW 03/14/17 REVISION 03/28/17 revision 04/03/17 FINAL

CHECKED BY: AG

PROVED BY: AR

((Sirius XM))

22 SHELTER ROCK LN.

BUILDING C DANBURY, CT 06810

I 100 E. WOODFIELD ROAD, SUITE 500 SCHAUMBURG, ILLINOIS 60173

TEL: 847-908-8400


www.FullertonEngineering.com

ALL NEW GROUND BARS SHALL BE TIED TO (E) GROUND RING OR BONDED TO (E) GROUND BARS

NOT USED


EXOTHERMIC MECHANICAL CONNECTION CONNECTION

GROUND EACH CABINET FROM GROUND BAR INSIDE CABINET TO MASTER GROUND BAR. INSTALL GROMMET AT BOTTOM OF CABINET,

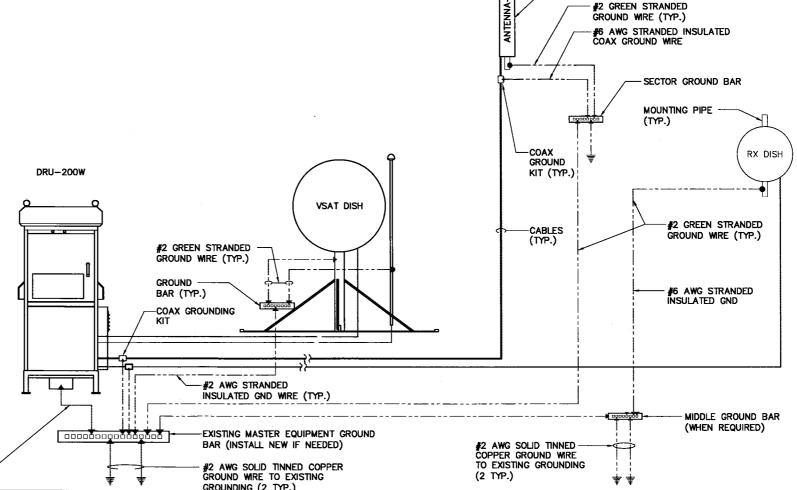

SCALE: N.T.S.

3

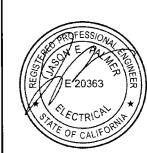

SITE NAME

400 BEALE STREET

SITE I.D.

SFX502T

SITE ADDRESS

400 BEALE STREET SAN FRANCISCO, CA 94105

SHEET NAME

GROUNDING DETAILS AND NOTES

SHEET NUMBER

FEC# 2015.0042.0025

#2 AWG STRANDED

INSULATED GND WIRE (TYP.)

LNB PART #4507A BY NORSAT F-FEMALE	ITEM #	DESCRIPTION	SIZE	QUANTITY	LENGTH	MANUFACTURER	PART NUMBER	REMARKS	PROVIDED BY	((Sirius XM)))
CONNECTOR	—-  1	VSAT DISH	1.OM	1 NEW	N/A	PRODELIN	1111 WITHOUT DEICING	PRODELIN VSAT DISH ANTENNA	VENDOR	HPG)
	— l 2	LNB	N/A	1 NEW	N/A	NORSAT	4507A	_	VENDOR	22 SHELTER ROCK LN. BUILDING C DANBURY, CT 06810  FULLERTON ENGINEERING DESIGN
	— <b>3</b>	F-MALE CONNECTOR	N/A	1 NEW	N/A	THOMAS AND BETTS	SNS1P6QS	_	VENDOR	I100 E. WOODFIELD ROAD, SUITE 500 SCHAUMBURG, ILLINOIS 60173 TEL: 847-908-8400 www.FullertonEngineering.com  CHECKED BY: AG APPROVED BY: AR
	<del></del>	COAX CABLE	.298"	1 NEW	75'	BELDEN	RG6-QS		VENDOR	## DATE DESCRIPTION INT.  17 01/13/17 90% REVIEW KC 03/14/17 REVISION KC 03/28/17 REVISION KC 04/03/17 FINAL KC
	— <b>∣</b> 5	F-MALE CONNECTOR	N/A	1 NEW	N/A	THOMAS AND BETTS	SNS1P6QS		VENDOR	
	—   6	CABINET	N/A	1 NEW	N/A	UBS	DRU-200W	_	SIRIUS XM	E 20363
VSAT ANTENNA CONFIGURATION									SCALE: N.T.S. 1	OF CALIFORNIA
	ITEM #	DESCRIPTION	SIZE	QUANTITY	LENGTH	MANUFACTURER	PART NUMBER	REMARKS	PROVIDED BY	SITE NAME
	1	GPS ANTENNA	N/A	1 NEW	N/A	TRIMBLE	57860-30	_	SIRIUS XM	400 BEALE STREET
	-12	F CONNECTOR	N/A	1 NEW	N/A	THOMAS AND BETTS	SNS1P6QS	<b>–</b>	VENDOR	SITE I.D.  SFX502T
	3	COAX CABLE	.298"	1 NEW	50'	TRIMBLE	RG6-QS	-	VENDOR	SITE ADDRESS
	4	F CONNECTOR	N/A	1 NEW	N/A	THOMAS AND BETTS	SNS1P6QS	-	VENDOR	400 BEALE STREET SAN FRANCISCO, CA 94105 SHEET NAME
	15	F TO N CONNECTOR	N/A	1 NEW	N/A	EMERSON	26-8020	_	SIRIUS XM	SITE CONFIGURATIONS
	6	CABINET	N/A	1 NEW	N/A	UBS	DRU-200W	_	SIRIUS XM	MATERIAL LIST SHEET NUMBER
GPS ANTENNA CONFIGURATION									SCALE: N.T.S. 2	FEC# 2015.0042.002





22 SHELTER ROCK LN. BUILDING C DANBURY, CT 06810

### **FULLERTON**

1100 E. WOODFIELD ROAD, SUITE 500 SCHAUMBURG, ILLINOIS 60173 TEL: 847-908-8400 www.FullertonEngineering.com

	СН	ECKED BY:	AG						
	AP	PROVED BY:	AR						
	#	DATE	DESCRIPTION	IN.					
	77	01/13/17	90% REVIEW	K					
		03/14/17	REVISION	K					
		03/28/17	REVISION	K					
		04/03/17	FINAL	K					
				Τ					
DED BY				$\top$					
				$\top$					
				十					
				1					
S XM				†					
	┢			$\top$					
	_			十					
DOR	Н		• •	_					
	ı								
	l								
DOR									
	ı		ROFESS/ON						
	i	1/4/	X E PANCON						
DOR	l	1/3/9	1//////////////////////////////////////	\					
	1	PROFESSIONAL E PARENTE DE LA CONTRACTOR							
		1144127/	TE/00000 100	1 6					

SITE NAME

400 BEALE STREET

SITE I.D.

SFX502T

SITE ADDRESS

400 BEALE STREET SAN FRANCISCO, CA 94105

SHEET NAME

SITE CONFIGURATIONS

MATERIAL LIST SHEET NUMBER

\_ \_ / \

										_
		ITEM#	DESCRIPTION	SIZE	QUANTITY	LENGTH	MANUFACTURER	PART NUMBER	REMARKS	PROVIDED BY
		1	HB RX DISH (2330-2345 MHz)	25.25"	1 NEW	N/A	TIL-TEK	TA-2324-LHCP	CIRCULAR POLARIZED SOLID PARABOLIC DISH ANTENNA	SIRIUS XM
		<u> </u>	7-16 DIN MALE CONNECTOR	N/A	1 NEW	N/A	ANDREW	L4TDM-PSA	ATTACH TO CABLE PRIOR TO INSTALLATION	VENDOR
	1	<del> </del> 3	GROUNDING KIT	N/A	1 NEW	N/A	ANDREW	SG12-06B2A	INCLUDES 59" #6 GROUND WIRE, INSTALL 1 KIT EVERY 100 FT. MIN.	VENDOR
		<u> </u>	COAXIAL CABLE	1/2"ø	1 NEW	60'	ANDREW	LDF4-50A	MINIMUM BEND RADIUS PER MANUFACTURER SPECS	VENDOR
		<b>─</b> 5	GROUNDING KIT	N/A	1 NEW	N/A	ANDREW	SG12-06B2A	INCLUDES 59" #6 GROUND WIRE, INSTALL 1 KIT EVERY 100 FT. MIN.	VENDOR
		<b>⊣</b> 6	N MALE CONNECTOR	N/A	1 NEW	N/A	ANDREW	L4TNM-PSA	-	VENDOR
		<b>→</b> 7	CABINET	N/A	1 NEW	N/A	UBS	DRU-200 <b>W</b>	-	SIRIUS XM
_	/ / /								•	•





# 22 SHELTER ROCK LN. BUILDING C DANBURY, CT 06810

1100 E. WOODHELD ROAD, SUITE 500 SCHAUMBURG, ILLINOIS 60173 TEL: 847-908-8400 www.FullertonEngineering.com

Γ	7										<u> </u>	
- 1	CH										CHECKED BY:	AG
- 1		1 1					ì		1	}	APPROVED BY:	AR
- 1		ITEM#	DESCRIPTION	SIZE	QUANTITY	LENGTH	MANUFACTURER	PART NUMBER	REMARKS	PROVIDED BY	# DATE	DESCRIPTION
- 1		l "I	22301 11311	0,22	1307	LLITOITI	I WALLET ALGERTALIS	I TAKE NOMBER	TIEMP II TIE	I NOVIBLE BY	" 01/13/17	90% REVIEW
- 1		L			ļ		·			ļ	03/14/17	REVISION
- 1											03/28/17	REVISION
- 1	•	<b>⊣</b> 1	TRANSMIT ANTENNA	N/A	1 NEW	N/A	TILLEK	TA-2304-2-DAB-L-045	_	SIRIUS XM	04/03/17	FINAL
- 1					<u> </u>						<u> </u>	
- 1			7 46 00 444									
- 1		<b>⊣</b> 2	7-16 DIN MALE CONNECTOR	N/A	1 NEW	N/A	ANDREW		ATTACH TO CABLE PRIOR TO INSTALLATION	VENDOR		
- 1			CONNECTOR		1			1	INSTALLATION	1		
- 1											<u>.                                    </u>	
- 1		—  3	GROUNDING KIT	N/A	1 NEW	N/A	ANDREW	SG12-06B2A	INCLUDES 59" #6 GROUND WIRE,	VENDOR		
		' '		'	1	·			INSTALL 1 KIT ËVERY 100 FT. MIN.	1		
										<del>                                     </del>	<u> </u>	
		<b> 4</b>	COAXIAL CABLE	1/2*	1 NEW	60'	ANDREW		MINIMUM BEND RADIUS PER	VENDOR	I	
/Ţ		' '	GOTTAINE OTBLE		'''				MANUFACTURER SPECS	VENDOI!	I	
- +		-			_		· · · · · · · · · · · · · · · · · · ·			-	I	
- 1		5	GROUNDING KIT	N/A	1 NEW	N/A			INCLUDES 59" #6 GROUND WIRE,			DEESCIA
		3	GROUNDING KIT	N/A	1 NEW	N/A	ANDREW	SG12-06B2A	INSTALL 1 KIT EVERY 100 FT. MIN.	VENDOR	1/6	RY 100/0/4
											1/3/	N 5 BOX SEN
-				l ,					ATTACH TO CABLE PRIOR TO		1/2/2	E 20363
		6	7/8" EIA CONNECTOR	N/A	1 NEW	N/A	ANDREW	L4E78-PS	INSTALLATION	VENDOR		7 m
											\\\\\\\\\\	E 20363 第)
											\\\&\\/ <sub>&amp;</sub>	. /+//
		<b>─</b>   7	CABINET	N/A	1 NEW	N/A	UBS	DRU-200W	<b> _</b>	SIRIUS XM	1 1	ECTRICA
1									•			
/¶					-		•					OF CALIFOR
<b>₽</b>											1	



SITE NAME

400 BEALE STREET

SITE I.D.

SFX502T

SITE ADDRESS

400 BEALE STREET SAN FRANCISCO, CA 94105

SHEET NAME SITE CONFIGURATIONS

MATERIAL LIST SHEET NUMBER

FINAL ANTENNA CONFIGURATION

SCALE: N.T.S.