Letter of Determination

1650 Mission St. Suite 400 San Francisco, CA 94103-2479

Reception: 415.558.6378

Fax: 415.558.6409

Planning Information: 415.558.6377

March 15, 2016

Robert Edmonds Edmonds + Lee Architects 2601 Mission Street, #503 San Francisco CA 94110

Site Address:

165 Page Street

Assessor's Block/Lot:

0853/015

Zoning District:

Moderate Scale Neighborhood Commercial Transit (NCT-3)

Site Address:

Central Freeway Parcel T

Assessor's Block/Lot:

0853/022

Zoning District:

Hayes Gough Neighborhood Commercial Transit (NCT)

Staff Contact:

Carly Grob, (415) 575-9138 or carly.grob@sfgov.org

Record No.:

2016-002104ZAD

Dear Mr. Edmonds:

This letter is in response to your request for a Letter of Determination regarding 165 Page Street and Central Freeway Parcel T. 165 Page Street is located in the Moderate Scale Neighborhood Commercial Transit (NCT-3) Zoning District and 50-X Height and Bulk District. Parcel T is located in the Hayes-Gough Neighborhood Commercial Transit (NCT) Zoning District and 50-X Height and Bulk District. The request is to determine if a rear yard setback is required for a proposed development which would occupy both parcels.

Per Planning Code Section 134(a)(1), the typical minimum rear yard depth in Neighborhood Commercial (NC) Zoning Districts shall be equal to 25% of total lot depth on which the building is situated, and in no cases less than 15 feet. Section 134(a)(1)(C) states that in NCT-3 and Hayes-Gough NCT Districts, rear yards shall be provided at the lowest level containing a dwelling unit. This section also states that in the Hayes-Gough NCT, lots fronting the east side of Octavia Boulevard between Linden and Market Streets (Central Freeway Parcels L, M, N, R, S, T, U, and V) are not required to provide rear yards at any level of the building, provided that the project fully meets the usable open space requirement for Dwelling Units per Planning Code Section 135, the exposure requirements of Section 140, and gives adequate architectural consideration to the light and air needs of adjacent buildings given the constraints of the project site.

A proposed project which only occupied Parcel T would not be required to provide a rear yard setback provided that the other criteria of Section 134(a)(1)(C) are met. However, merging the subject lots would

March 15, 2016 Letter of Determination Parcel T and 165 Page Street

not change the requirements of the underlying Zoning Districts. The rear yard exemption in Section 134(a)(1)(C) applies only to certain Central Freeway parcels along Octavia Boulevard which are located within the Hayes-Gough NCT. The property at 165 Page Street is located within the NCT-3 District, in which a rear yard is required. Therefore, a rear yard setback would be required at the lowest level containing a dwelling unit on the portion of the property that is located within the NCT-3 District.

It should be noted that Section 134(e)(1) allows the Zoning Administrator to modify or waive the rear yard requirement in NC Districts pursuant to the procedures which are applicable to variances if all of the following criteria are met:

- Residential uses are included in the new or expanding development and a comparable amount of
 usable open space is provided elsewhere on the lot or within the development where it is more
 accessible to the residents of the development; and
- 2. The proposed new or expanding structure will not significantly impede the access of light and air and views from adjacent properties; and
- 3. The proposed new or expanding structure will not adversely affect the interior block open space formed by the rear yards of adjacent properties.

Please note that a Letter of Determination is a determination regarding the classification of uses and interpretation and applicability of the provisions of the Planning Code. This Letter of Determination is not a permit to commence any work or change occupancy. Permits from appropriate Departments must be secured before work is started or occupancy is changed.

APPEAL: If you believe this determination represents an error in interpretation of the Planning Code or abuse in discretion by the Zoning Administrator, an appeal may be filed with the Board of Appeals within 15 days of the date of this letter. For information regarding the appeals process, please contact the Board of Appeals located at 1650 Mission Street, Room 304, San Francisco, or call (415) 575-6880.

Sincerely,

Scott F. Sanchez

Zoning Administrator

cc: Kate Conner, Planner

Property Owner

Neighborhood Groups

BBN Requestor (if any)

2601 Mission Street, #503 San Francisco, CA 94110 T 415 . 285 . 1300 www.edmondslee.com

Mr. Scott Sanchez, Zoning Administrator San Francisco Planning Department 1650 Mission Street, Suite 400 San Francisco, CA 94103 February 12, 2016

R#2016-002104 ZAD CK # 325 \$ 645.-M. LUELLEN (NE)

RE: Rear Yard Requirements for Parcel T & 165 Page Street

Dear Mr. Sanchez,

I am writing to request a Letter of Determination for the rear yard requirement for the mixed-use, multi-family residential building being proposed on the Central Freeway Parcel T (0853 / 022) and 165 Page Street (0853 / 015).

In May of 2014 and in response the City and County of San Francisco's Request for Developer Proposal, the joint development team of DDG and DM Development entered into an Exclusive Negotiating Agreement (ENA) to develop Parcel T into a mixed-use, 5-story, 26-residential unit building designed by Edmonds + Lee Architects.

The basis of design of the proposed project was on the assumption that rear yards would not be required on the parcel per San Francisco Zoning Code Section 134 (a)(1)(C) which states:

"...lots fronting the east side of Octavia Boulevard between Linden and Market Streets (Central Freeway Parcels L, M, N, R, S, T, U, and V) are not required to provide rear yards at any level of the building, provided that the project fully meets the usable open space requirement for Dwelling Units per Section 135 of this Code, the exposure requirements of Section 140, and gives adequate architectural consideration to the light and air needs of adjacent buildings given the constraints of the project site."

In recent months, the development team in collaboration with the Mayor's Office has been in negotiations to acquire the directly adjacent parcel at 165 Page Street with the intent of demolishing the existing commercial building and incorporating the 165 Page Street property into the larger Parcel T development project. If combined, we believe there would be a net increase of 14 additional residential units providing 40 total residential units for the combined project.

The development team would therefore like to confirm that there will not be a rear yard requirement for the combined project.


Attached for your reference are supporting documents that illustrate our proposal.


Thank you for your consideration.

Sincerely,

Robert Edmonds

EDMONDS + LEE ARCHITECTS

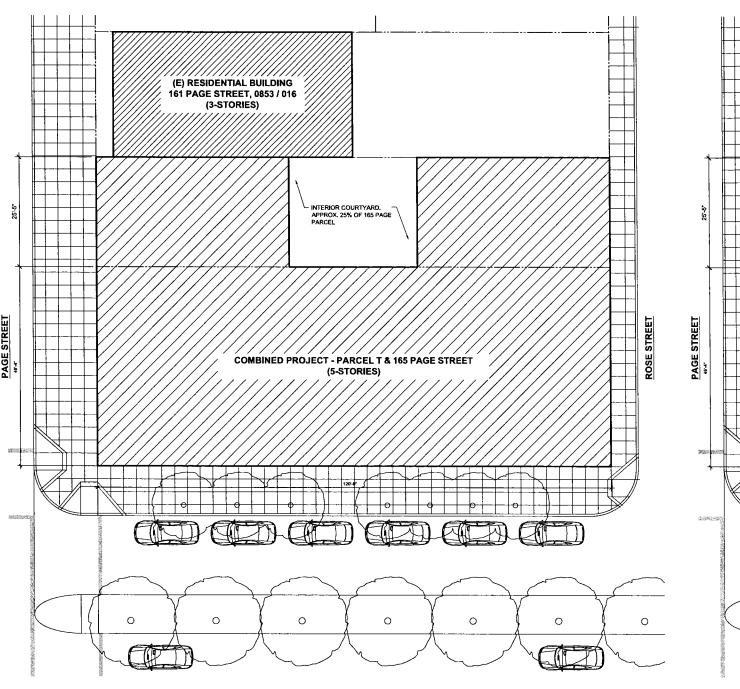

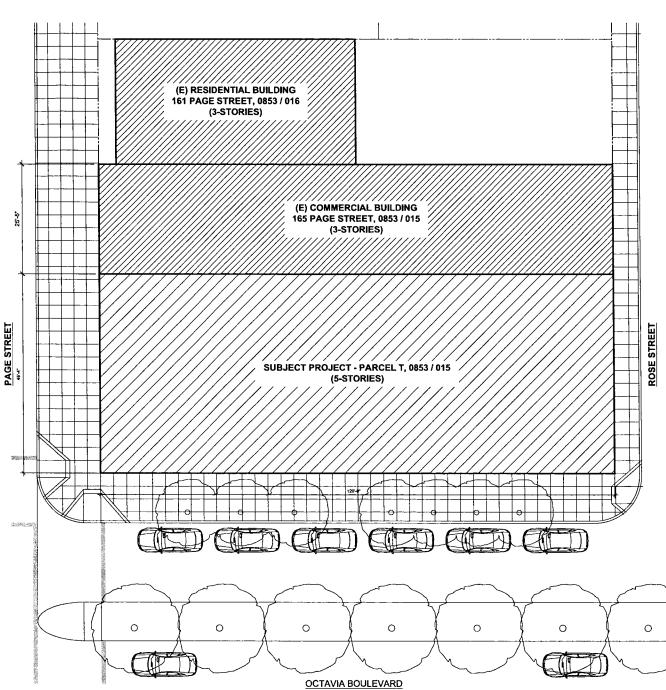

EDMONDS + LEE ARCHITECTS, INC.

2601 Mission St., #503 San Francisco, CA 94110 T 415 , 285 , 1300 www.edmondslee.com

PROJEC

OCTAVIA BLVD. PARCEL T BLOCK 0853, LOT 022 SAN FRANCISCO, CA 94102


DRAWING:

SITE PLAN PROPOSALS

SCALE:	1/32" = 1'-0"
DATE:	FEBRUARY 5, 2016
JOB NO.	2014.12
DRAWN:	
CAD FILE:	



Street View of Project Site at Page Street & Octavia Boulevard Image Date: August, 2015 (Google Street View)

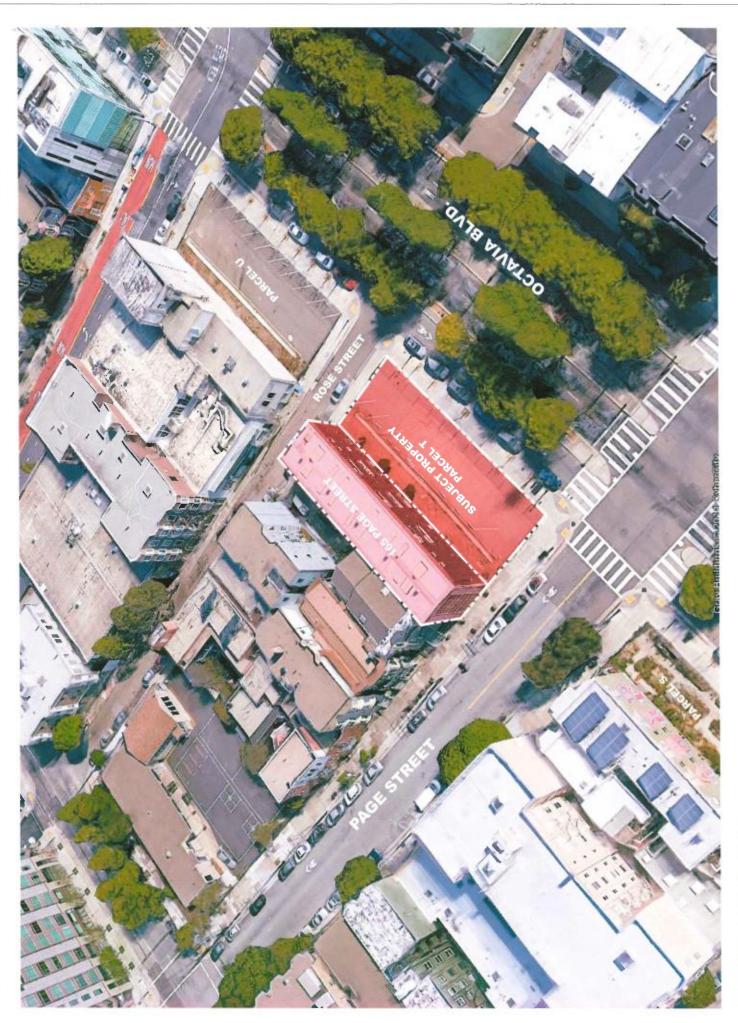

Aerial View of Project Site Image Date: March, 2015 (Google Earth)



OCTAVIA BOULEVARD PARCEL T

BLOCK 0853, LOT 022, SAN FRANCISCO, CA 94102

ISSUED FOR PRELIMINARY PROJECT ASSESSMENT (PPA) - SEPTEMBER 12, 2014

SHEET INDEX:

COVER SHEET GENERAL NOTES AND SYMBOLS

SITE PLAN (EXISTING) SITE PLAN (NEW)

SITE PHOTOS CONCEPT RENDERINGS A0.20 A0.30

FLOOR PLAN - BASEMENT & 1ST FLOOR (NEW) FLOOR PLAN - 2ND & 3RD FLOOR (NEW) FLOOR PLAN - 4TH & 5TH FLOOR (NEW) FLOOR PLAN - ROOF (NEW)

EXTERIOR ELEVATION (NEW) EXTERIOR ELEVATION (NEW)

BUILDING SECTION

PROJECT INFORMATION: ADDRESS:

0853

T.B.D. SAN FRANCISCO, CA 94102

BLOCK:

LOT:

HAYES-GOUGH NEIGHBORHOOD COMMERCIAL TRANSIT DISTRICT (NCT)

WORK HOURS:

BUILDING CONSTRUCTION IS ALLOWED DURING THE HOURS OF 7:00 AM TO 8:00 PM, SEVEN DAYS A WEEK, INCLUDING HOLIDAYS. ANY WORK DONE BEFORE OR AFTER THESE HOURS MUST NOT EXCEED THE NOISE LEVEL OF FIVE DECIBELS AT THE NEAREST LOT LINE UNLESS A SPECIAL PERMIT HAS BEEN GRANTED.

ISSUED FOR PPA

EDMONDS + LEE

ARCHITECTS, INC. 2601 Mission St., 400A

San Francisco, CA 94110 T 415 . 285 . 1300

www.edmondslee.com

NO: DATE: SUBMISSION:

THE PROPOSED PROJECT IS THE CONSTRUCTION OF A (NEW) 5-STORY, MIXED-USE COMMERCIAL AND 26-UNIT RESIDENTIAL BUILDING.

SPECIFIC WORK CONSISTS OF THE FOLLOWING:

ARCHITECTURE INTERIOR:

PROJECT DESCRIPTION:

1. (NEW) CONSTRUCTION OF ALL INTERIORS INCLUDING BEDROOMS, KITCHEN, BATHROOMS, LIVING AREAS, AND UTILITY AREAS.

ARCHITECTURE EXTERIOR:

(NEW) CONSTRUCTION OF EXTERIORS INCLUDING CLADDING, FENESTRATION, EXTERIOR DECKS AND ROOFS.

STRUCTURAL:

(NEW) CONCRETE FOUNDATION AND PODIUM WITH TYPE V CONSTRUCTION ABOVE.

MECHANICAL, ELECTRICAL & PLUMBING:

(NEW) MEP FIXTURES AND EQUIPMENT THROUGHOUT STRUCTURE.
 (NEW) MEP & FIRE SPRINKLERS TO BE DESIGN BUILD AND FILED UNDER A SEPARATE PERMIT.

PROJECT DIRECTORY:

CLIENT:

CONTRACTOR: T.B.D. LINDEN PARTNERS INVESTMENTS.

LLC 448 LINDEN STREET SAN FRANCISCO, CA 94102 T (415) 692-5054

ARCHITECT:

STRUCTURAL ENGINEER

EDMONDS + LEE ARCHITECTS, INC. CONTACT: ROBERT EDMONDS 2601 MISSION STREET, 400A SAN FRANCISCO, CA 94110 T (415) 285-1300

OCTAVIA BLVD. PARCEL T

COVER SHEET

SCALE;	AS NOTED
DATE:	SEPTEMBER 12, 2014
JOB NO.	2014.12
DRAWN:	
CAD FILE:	





A0.00

VICINITY MAP SCALE: N.T.S.

GENERAL CONDITIONS

THE GENERAL CONDITIONS OF THE CONTRACT ARE THE AMERICAN INSTITUTE OF ARCHITECTS DOCUMENT A201, "GENERAL CONDITIONS OF THE CONTRACT FOR CONSTRUCTION," CURRENT EDITION, WHERE THESE CONFLICT WITH THE FOLLOWING SUPPLEMENTARY GENERAL CONDITIONS, THE LATTER SHALL TAKE PRECEDENCE.

SUMMARY OF WORK

THE WORK DESCRIBED IN THIS CONTRACT CONSISTS OF FOLLOWING CONSTRUCTION DOCUMENTS AND SPECIFICATIONS.

CHANGE IN THE WORK

- 1. VERBAL INSTRUCTION: IT IS THE GENERAL CONTRACTOR'S RESPONSIBILITY TO ADVISE THE ARCHITECT REGARDING ANY ADDITIONAL COSTS RESULTING FROM THE ARCHITECT'S VERBAL INSTRUCTIONS; SUCH ADVICE SHALL OCCUR BEFORE ANY ADDITIONAL WORK IS EXECUTED.
- SUBMITTAL OF CHANGE ORDERS: CHANGE ORDERS SHALL BE PREPARED BY THE GENERAL
 CONTRACTOR; IF A CHANGE ORDER SUBMITTED TO THE ARCHITECT FOR APPROVAL AFTER THE WORK
 REFLECTED BY THE CHANGE ORDER HAS ALREADY BEEN EXECUTED, THE CHANGE ORDER WILL BE
 AUTOMATICALLY REJECTED. A WRITTEN EXPLANATION BY THE GENERAL CONTRACTOR OF THE EFFECT
 OF THE CHANGE ORDER ON THE PROJECT SCHEDULE MUST ACCOMPANY EACH CHANGE ORDER.
- FITTINGS, HARDWARE AND FINISHES: WHEN PLUMBING FAUCETS, DOOR HARDWARE, CERAMIC TILE ETC.
 ARE TO BE SPECIFIED BY CHANGE ORDER, THE COST SHALL CONSIST OF: 1. PRODUCT COST LESS
 TRADE DISCOUNT, 2. SUB CONTRACTOR'S OVERHEAD AND PROFIT, 3. DELIVERY COSTS AND TAXES.

- CONSIDERATION OF SUBSTITUTIONS; BURDEN OF PROOF OF THE MERIT OF PROPOSED SUBSTITUTION IS UPON THE PROPOSER.
- SUBMITTAL REQUIREMENTS: SUBSTITUTIONS SHALL BE SUBMITTED IN WRITING BY THE CONTRACTOR
 AND SHALL INCLUDE CONFIRMATION OF THE SUBSTITUTION'S EFFECT ON PROJECT COST, SCHEDULE
 AND INTERFACE WITH OTHER SPECIFIED PRODUCTS.

DRAWINGS AND SPECIFICATIONS

- 1. THE CONTRACTOR WILL RECEIVE NECESSARY NUMBER OF COPIES OF EACH OF THE ARCHITECTURAL, MECHANICAL, ELECTRICAL AND STRUCTURAL DRAWINGS AND SPECIFICATIONS FOR DISTRIBUTION TO
- 2 DRAWINGS AND SPECIFICATIONS ARE INTENDED TO BE COMPLEMENTARY, ANYTHING SHOWN IN THE DRAWING BUT NOT MENTIONED ION THE SPECIFICATIONS, OR VISA VERSA, SHALL BE FURNISHED AS IF SHOWN OR MENTIONED IN BOTH. LARGE SCALE DRAWINGS AND SPECIFICATIONS SHALL TAKE PRECEDENCE OVER SMALL SCALE DRAWINGS.

 SUPPLEMENTAL DRAWINGS AND SPECIFICATIONS: AS DETAILS BECOME FURTHER DEVELOPED AND REFINED BY THE ARCHITECT, DRAWINGS AND SPECIFICATIONS WILL BE ISSUED DURING CONSTRUCTION. IN THE EVENT THAT THE CONTRACTOR FEELS THESE DRAWINGS AFFECT THE COST OF THE WORK THAT THAY ELERADY BEEN BID, A CHANGE ORDER WILL BE NEGOTIATED PRIOR TO THE EXCILITION OF THE WORK INFOL WORK INFOL WERE MID. EXECUTION OF THE WORK INVOLVED.
- SHOP DRAWINGS: SUBMIT TWO PRINTS OF EACH SHOP DRAWINGS TO THE ARCHITECT; IF RE-SUBMITTAL IS REQUESTED REPEAT PROCESS.
- 4 SAMPLES FULL-SIZE SAMPLES OF VARIOUS BUILDING COMPONENTS WILL BE REQUIRED FOR THE SAMPLES FOLL-SIZE SAMPLES OF VANIOUS BUILDING COMPINENTS WILL BE REQUIRED FOR THE REVIEW OF KIND, COLOR, PATTERN AND TEXTURE, FOR A FINAL CHECK OF THESE CHARACTERISTICS WITH OTHER ELEMENTS, AND FOR A COMPARISON OF THESE CHARACTERISTICS BETWEEN THE FINAL SUBMITTAL AND THE ACTUAL COMPONENT AS DELIVERED AND INSTALLED REFER TO SPECIFIC SECTIONS OF THE SPECIFICATIONS FOR FURTHER INFORMATION ON SAMPLE SUBMITTAL.

CONSTRUCTION SCHEDULES

- 1. FORM: THE CONTRACTOR MAY UTILIZE ANY BAR GRAPH OR CRITICAL PATH FORM HE WISHES.
- 2. SUBMITTAL: THE FIRST SCHEDULE SHALL BE SUBMITTED PRIOR TO THE START OF THE WORK: SUBMISSEDUENT SCHEDULE CHANGES AS THEY ARISE WITH THE NEAREST APPLICATION FOR PAYMENT
- PRIOR TO THE START OF CONSTRUCTION THE CONTRACTOR SHALL PROVIDE ARCHITECT WITH A SCHEDULE OF DATES FOR THE SUBMITTAL OF DRAWINGS AND DOCUMENTS REQUIRED IN ORDER TO CARRY OUT THE WORK.

PROJECT CLOSEOUT

- SUBSTANTIAL COMPLETION: THE ARCHITECT SHALL ISSUE A CERTIFICATE OF SUBSTANTIAL COMPLETION AFTER THE PERMANENT UTILITIES ARE IN OPERATING AND THE WORK HAS PROGRESSED TO THE POINT WHEN THE OWNER COULD OCCUPY THE PROJECT FOR ITS INTENDED USE; THE CERTIFICATE SHALL ESTABLISH RESPONSIBILITIES OF THE OWNER AND GENERAL CONTRACTOR FOR SECURITY, MAINTENANCE, UTILITIES, DAMAGE TO THE WORK, AND INSURANCE, AND SHALL FIX DEADLINE, NEGOTIATED BETWEEN GENERAL CONTRACTOR AND THE OWNER, FOR THE COMPLETION OF ALL PUNCH LIST ITEMS, ALL WARRANTIES REQUIRED BY THE CONTRACT DOCUMENT SHALL COMMENCE ON THE DATE OF THE CERTIFICATE OF SUBSTANTIAL COMPLETION.
- 2. PUNCH LIST: THE ARCHITECT SHALL ATTACH TO THE CERTIFICATE OF SUBSTANTIAL COMPLETION A PUNCH LIST SETTING FORTH THE REMAINING WORK REQUIRED TO CLOSE OUT THE CONTRACT; THE PUNCH LIST AND DEADLINE MAY BE AMENDED REPEATEDLY AS FURTHER DEFICIENCY IN THE WORK ARISE; IF THE PUNCH LIST WORK IS NOT COMPLETED BY THE DEADLINE, THE OWNER MAY CARRY OUT HE WORK IN ACCORDANCE WITH GENERAL REQUIREMENTS.
- 3 OWNER'S MANUAL: ASSEMBLE THE FOLLOWING ITEMS IN A THREE RING BINDER, WITH TARBED DIVIDERS SEPARATING BASIC CATEGORIES OWNER'S MANUAL AND PRODUCT WARRANTIES FOR EQUIPMENT, ALL APPLIANCES CEILING FANS ETC. ALSO INCLUDE A TYPEWRITTEN LIST OF ALL SUBCONTRACTORS AND THEIR PHONE NUMBERS: SUBMIT BINDER TO ARCHITECT.
- 4 FINAL PAYMENT: AFTER THE GENERAL CONTRACTOR HAS COMPLETED THE PUNCH LIST. SUBMITTED THE OWNER'S MANUAL, AND SUBMITTED A COMPLETE RELEASE OF LIENS TO THE ARCHITECT, THE FINAL PAYMENT SHALL BE DUE.

MISCELLANEOUS CONTRACTOR REQUIREMENTS

- ALL WORK SHALL COMPLY WITH ALL FEDERAL, STATE AND LOCAL CODES AND ORDINANCES, ALL
 UTILITY COMPANY RULES AND REGULATIONS, AND SHALL BE DONE TO THE HIGHEST STANDARDS OF CRAFTSMANSHIP BY JOURNEYMEN OF THE RESPECTIVE TRADES.
- CONTRACTOR SHALL FURNISH ALL NECESSARY LINES, LEVELS, LOCATIONS AND MEASUREMENTS TO
 ALL OF THE WORK, AND HE WILL BE HELD RESPONSIBLE FOR THEIR ACCURACY. NO DEPARTURE FROM
 THE TERMS OF THE CONTRACT WILL BE VALID UNLESS SUCH ORDERS OR DIRECTIONS ARE GIVEN OR
 CONFIRMED IN WRITING BY THE ARCHITECT.
- 3. CONTRACTOR SHALL OBTAIN AND PAY FOR ALL REQUIRED PERMITS, INSPECTIONS, ETC. ALL LANDFILL TAXES, USE TAXES, SALES TAXES AND ANY OTHER CHARGES RELATED TO CONSTRUCTION OF THIS PROJECT AND PAYMENT FOR THE SAME ARE THE RESPONSIBILITY OF THE CONTRACTOR. AT THE COMPLETION OF THE WORK, DELIVER TO OWNER ALL REQUIRED PERMITS, CERTIFICATES OF APPROVAL, ETC. BUILDING DEPT. & HEALTH DEPT. PERMITS SHALL BE PROVIDED AND PAID FOR BY THE OWNER.
- 4. SUPERVISION: THE CONTRACTOR SHALL BE PRESENT AT THE SITE WHENEVER THE WORK IS IN PROGRESS WHETHER BY HIS OWN OR HIS SUBCONTRACTOR'S FORCES.
- 5. OWNER'S RIGHT TO CARRY OUT WORK: IF THE CONTRACTOR NEGLECTS TO CARRY OUT THE WORK IN ACCORDANCE WITH THE CONTRACT DOCUMENTS AND FAILS TO COMMENCE AND CONTINUE CORRECTION OF SUCH NEGLECT WITH DILIGENCE WITHIN A SEVEN DAY PERIFOR ATTER THE RECEIPT OF WRITTEN NOTICE FROM THE OWNER. THE OWNER MAY CORRECT SUCH DEFICIENCIES; IN SUCH CASS THE COST OF CORRECTING SUCH DEFICIENCIES; IN SUCH CASS ADDITIONAL SERVICES MADE NECESSARY BY SUCH DEFAULT, SHALL BE DEDUCTED FROM PAYMENTS OWED TO THE CONTRACTOR; IF PAYMENTS DUE THE CONTRACTOR ARE NOT SUFFICIENT TO COVER SUCH AMOUNTS, THE CONTRACTOR SHALL PAY THE DIFFERENCE TO THE OWNER.
- 6 SUBSTANTIATION OF PAY REQUEST: APPLICATION FOR PAYMENT FOR MATERIALS AND EQUIPMENT NOT YET INCORPORATED INTO THE WORK SHALL BE SUPPORTED BY SUCH DATA AS THE OWNER MAY REQUIRE TO SUBSTANTIATE THE GENERAL CONTRACTOR'S RIGHT PAYMENT.

MISCELLANEOUS CONTRACTOR REQUIREMENTS CONTINUED

- 7. OWNER'S TITLE TO MATERIALS AND EQUIPMENT: BY HIS APPLICATION FOR PAYMENT THE CONTRACTOR WARRANTS THAT TITLE TO ALL MATERIALS AND EQUIPMENT REFLECTED BY THE APPLICATION FOR PAYMENT BUT NOT YET INCORPORATED INTO THE WORK SHALL PASS TO THE OWNER AT THE TIME OF DAMENT.
- WHERE ALLOWANCES ARE SPECIFIED, THE CONTRACTOR SHALL PURCHASE AND PAY FOR THE ITEMS SELECTED BY THE ARCHITECT. THE AMOUNT OF THE CONTRACT SHALL BE INCREASED OR DECREASED BY THE AMOUNT THAT THE TOTAL COST OF SUCH ITEMS EXCEED OR FALL UNDER THE COST ALLOWED.
- 9. CONTRACTOR SHALL MAINTAIN THE JOB CLEAR OF TRASH AND DEBRIS CONTRACTOR SHALL PRESENT THE BUILDING TO THE OWNER FOR ACCEPTANCE CLEAN AND READY FOR OCCUPANCY. ALL GLASS SHALL BE CLEANED AND POLISHED, FLOORS SWEPT BROOM CLEAN, FIXTURES WASHED, WITH ALL LABELS REMOVED, HEAT AND SNOW REMOVAL MILL BE THE CONTRACTOR'S RESPONSIBILITY. ALL SPACE HEATING SHALL BE DONE IN A SAFE MANNER, WITH PERIODIC CHECKS ON THE SYSTEM, AND SHALL COMPLY WITH STATE INDUSTRIAL COMMISSION AND OSH A REGULATIONS. TEMPORARY HEAT AT A TEMPERATURE OF NOT LESS THAN 45 DEGREES F. AS SOON AS CONDITIONS AT THE SITE PERMIT, THE BUILDING SHALL BE CAREFULLY LOCKED UP SO AS TO PREVENT VANDALISM, THEFT AND MALICIOUS MISCHIEF. IF THE GENERAL CONTRACTOR FAILS TO FULFILL HIS CLEANING REQUIREMENTS THE OWNER MAY CAREPY OUT THE WORK IN MORE DIMENSION. MAY CARRY OUT THE WORK IN ACCORDANCE WITH GENERAL REQUIREMENTS.
- 10. GENERAL CONTRACTOR'S FEE: ON APPLICATION FOR PAYMENT THE GENERAL CONTRACTOR'S FEE SHALL BE INDICATED AS A SEPARATE LINE ITEM.
- 11. SAMPLES: FULL-SIZE SAMPLES OF VARIOUS BUILDING COMPONENTS WILL BE REQUIRED FOR THE REVIEW OF KIND, COLOR, PATTERN AND TEXTURE, FOR A FINAL CHECK OF THESE CHARACTERISTICS WITH OTHER ELEMENTS, AND FOR A COMPARISON OF THESE CHARACTERISTICS BETWEEN THE FINAL SUBMITTAL AND THE ACTUAL COMPONENT AS DELIVERED AND INSTALLED REFER TO SPECIFIC SECTIONS OF THE SPECIFICATIONS FOR FURTHER INFORMATION ON SAMPLE SUBMITTAL.

GENERAL NOTES

- 1. ALL CONTRACTORS AND SUBCONTRACTORS SHALL OBTAIN ALL REQUIRED PERMITS AND/OR APPROVALS BEFORE COMMENCING WORK AND SHALL PROVIDE ALL REQUIRED CERTIFICATES OF COMPLIANCE TO THE OWNER UPON COMPLETION OF THE WORK. FEES FOR SECURING PERMITS SHALL BE THE SOLE RESPONSIBILITY OF THE CONTRACTOR AND/OR SUBCONTRACTOR.
- 2. ALL WORK SHALL COMPLY WITH ALL APPLICABLE BUILDING CODES, RULES AND REGULATIONS
- 3. ALL CONTRACTORS AND SUBCONTRACTORS SHALL CARRY WORKMEN'S COMPENSATION, DISABILITY, LIABILITY AND OTHER INSURANCES REQUIRED BY LAW AND THE OWNER. SUBMIT EVIDENCE OF SAID INSURANCES TO THE OWNER.
- 4. ALL CONTRACTORS AND SUBCONTRACTORS SHALL FAMILIARIZE THEMSELVES WITH THE EXISTING PROJECT CONDITIONS AND THE PROPOSED WORK PRIOR TO BIDDING.
- ALL CONTRACTORS AND SUBCONTRACTORS SHALL VERIFY ALL EXISTING CONDITIONS AND DIMENSIONS AT THE JOB SITE AND INFORM THE ARCHITECT OF ANY AND ALL ERRORS, OMISSIONS AND CLARFICATIONS IN WRITING PRIOR TO COMMENCING WORK. WITHIN 24 HOURS, THE CONTRACTOR MUST NOTIFY THE ARCHITECT IN WRITING OF ANY CONDITION DISCOVERED WHICH MAY CAUSE DELAY IN COMPLETION AND STATE THE PROBLEM(S) AND RECOMMENDED SOLUTION FOR RESOLUNDS THE CONDITION(S) DISCOVERED. THE ARCHITECT WILL RESPOND BASED ON THE DATA PROVIDED BY THE
- THE CONTRACTOR SHALL BE RESPONSIBLE FOR ALL CONSTRUCTION SURVEYS INCLUDING BUT NOT LIMITED TO EXISTING HVAC DUCTS, PLUMBING AND ELECTRICAL LINES.
- ANY DEVIATION BETWEEN THE DIMENSIONS OR ALIGNMENT INDICATED ON THE DRAWINGS AND THE ACTUAL FIELD DIMENSIONS OF THE WORK IN PLACE SHALL BE THE CONTRACTOR'S RESPONSIBILITY.
- 8. DO NOT SCALE DRAWINGS, USE DIMENSIONS ONLY.
- 9. CONTRACTOR (G.C.) SHALL SCHEDULE AND COORDINATE WORK OF ALL SUBCONTRACTORS SUBCONTRACTORS SHALL COORDINATE THEIR WORK WITH ALL OTHER SUBCONTRACTORS
- 10. ALL WORK SHALL BE DONE BY SKILLED TRADES PEOPLE AND PERFORMED IN A WORKMAN LIKE MANNER WITH PROFESSIONALLY ACCEPTED INDUSTRY STANDARD
- 11. ALL MATERIAL AND EQUIPMENT PROVIDED BY THE CONTRACTOR AND/OR OWNER SHALL BE INSTALLED PER THE MANUFACTURER'S RECOMMENDATIONS AND SPECIFICATIONS.
- 12 CONTRACTOR SHALL PROVIDE ALL LABOR AND MATERIAL NECESSARY FOR A COMPLETE JOB WHETHER EXPLICITLY INDICATED ON THE DRAWINGS OR NOT.
- 13. ALL WORK SHALL BE FINISHED AND IN PROPER WORKING ORDER AND SHALL BE GUARANTEED FOR A PERIOD OF ONE (1) YEAR FROM THE DATE OF THE OWNER'S ACCEPTANCE, COINCIDENT WITH THE DATE OF SUBSTANTIAL COMPLETION OR AS OTHERWISE INDICATED.
- 14. THE WORK SHALL BE PERFORMED ONLY DURING THE DAYS AND TIMES ESTABLISHED BY THE OWNER AND IN ACCORDANCE WITH THE LOCAL GOVERNING RULES AND REGULATIONS.

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HORIZONTAL

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ABV	ABOVE	IN	INCH
AC	AIR CONDITIONING	INFO	INFORMATION
ACOUST AD	ACOUSTICAL ACCESS DOOR, AREA DRAIN	J-BOX	JUNCTIONBOX
ADA	AMERICANS WITH DISABILITIES ACT	JT	JOINT
ADDL	ADDITIONAL		
AFF	ABOVE FINISHED FLOOR	LAM	LAMINATE
AIA	AMERICAN INSTITUTE OF ARCHITECTS	LOC	LOCATE
AISC AL	AMERICAN INSTITUTE OF STEEL CONSTRUCTION ALUMINUM	LTWI	LIGHTWEIGHT
ALT	ALTERNATE	MAINT	MAINTENANCE
ALUM	ALUMINUM	MAS	MASONRY
ANOD	ANODIZED	MAT	MATERIAL
APPD	APPROVED	MATL	MATERIAL
APPROX ARCH	APPROXIMATE ARCHITECT	MAX MECH	MAXIMUM MECHANICAL
AUTO	AUTOMATIC	MET	METAL
AVG	AVERAGE	MFG	MANUFACTURER
•		MISC	MISCELLANEOUS
BDRM	BEDROOM	MO	MASONRY OPENING
BEL BTWN	BELOW	NAT	NATURAL
BLDG	BETWEEN BUILDING	(N)	NEW
BLK	BLOCK	NOM	NOMINAL
BLKG	BLOCKING		
		ОС	ON CENTER
CB	CATCH BASIN	OD	OUTSIDE DIAMETER
CCW	COUNTER CLOCKWISE	OF OHD	OUTSIDE FACE
CEM CER	CEMENT CERAMIC	OHD	OVER HEAD OPENING
CFT	CUBIC FOOT	OPP	OPPOSITE HAND
CIP	CAST-IN-PLACE	•	
CJ	CONTROL JOINT	PLAM	PLASTICLAMINATE
CL	CENTERLINE	PTTN	PARTITION
CLG CLR	CEILING CLEAR	PERP PLMBG	PERPENDICULAR PLUMBING
CMU	CONCRETE MASONRY UNIT	PLTF	PLATFORM
CONC	CONCRETE	PLWD	PLYWOOD
CONT	CONTINUOUS	PNT	PAINT
CPT	CARPET	PREFAB	PREFABRICATED
DBL	DOUBLE	QTY	QUANTITY
DEG	DEGREE	u	qoa m
DEM	DEMOLISH	RA	RETURN AIR
DEMO	DEMOLITION	RAD	RADIUS
DEPT	DEPARTMENT	REBAR	REINFORCING BAR
DET DIAG	DETAIL DIAGONAL	REF REQD	REFERENCE REQUIRED
DIAG	DIAMETER	REV	REVISION
DIM	DIMENSION	RO	ROUGH OPENING
DN	DOWN	RWD	REDWOOD
DTL	DETAIL		
DWG DS	DRAWING DOWNSPOUT	SCHED	SCHEDULE
05	DOWNSPOUT	SC SECT	SOUD CORE SECTION
EA	EACH	SECT	SQUAREFOOT
EIFS	EXTERIOR INSULATION AND FINISH SYSTEM	SHT	SHEET
EJ	EXPANSION JOINT	SIM	SIMILAR
ELECT	ELECTRICAL	SPECS	SPECIFICATIONS
ENGR EQ	ENGINEER EQUAL	SQ SSTL	SQUARE STAINLESS STEEL
EQUIP	EQUIPMENT	STD	STANDARD
(E)	EXISTING	STL	STEEL
		STRUCT	STRUCTURAL
FDTN	FOUNDATION		TOD AND DOTTOR
FE FEC	FIRE EXTINGUISHER FIRE EXTINGUISHER CABINET	T&B T&G	TOP AND BOTTOM TONGUE & GROOVE
FF	FINISHED FLOOR	TBD	TO BE DETERMINED
FF&E	FIXTURES, FURNISHINGS & EQUIPMENT	TD	TRENCH DRAIN
FHC	FIRE HOSE CABINET	TRD	TREAD
FLR	FLOOR	TSLAB	TOP OF SLAB
FOS FP	FACE OF STUDS FIREPROOF	TS TW	TOP OF STEEL TOP OF WALL
FT FT	FEET	TYP)	TYPICAL
FTG	FOOTING	(117)	, , , IOAL
-		UL	UNDERWRITERS LAB
GA	GAUGE	UNO	UNLESS NOTED OTHERV
GALV	GALVANIZED	UON	UNLESS OTHERWISE NO
GB GC	GYPSUM BOARD	VERT	VERTICAL
GL	GENERAL CONTRACTOR GLASS	VER	VERIFY IN FIELD
GRND	GROUND		
GWB	GYPSUM WALL BOARD	W	WTH
		W/O	WITHOUT
н	HIGH	WC	WATER CLOSET

WATER CLOSET

WELDED WIRE MESH

NO DATE SUBMISSION DRAWING SYMBOLS BREAK LINE 10 ROOM # ROOM IDENTIFICATION 3RD FLOOR +32'-0" ELEVATION MARKER 102 WINDOW NUMBER HIDDEN OR OVERHEAD LINE 2'-0" DIMENSION LINE **01** \dashv DOOR NUMBER ALIGNMENT **ISSUED FOR** PARTITION TYPE PPA DETAIL SYMBOL EDMONDS + LEE ARCHITECTS, INC. SECTION DETAIL REVISION SYMBOL 2601 Mission St., 400A San Francisco, CA 94110 T 415 . 285 . 1300 BUILDING SECTION ELEVATION SYMBOL www.edmondslee.com


OCTAVIA BLVD PARCEL T SAN FRANCISCO, CA 94102

DRAWING

SYMBOLS AND ABBREVIATIONS

SCALE:	NONE
DATE:	SEPTEMBER 12, 2014
JOB NO.	2014.12
DRAWN:	
CAD FILE:	

A0.01

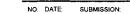

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OCTAVIA BLVD. PARCEL T BLOCK 0853, LOT 022 SAN FRANCISCO, CA 94102

DRAWIN


EXISTING SITE PLAN

SCALE:	1/8" = 1'-0"
DATE	SEPTEMBER 12, 2014
JOB NO.	2014.12
DRAWN:	
CAD FILE:	

(EXISTING) SITE / PLOT PLAN


SCALE: 1/8" = 1'-0"

A0.10

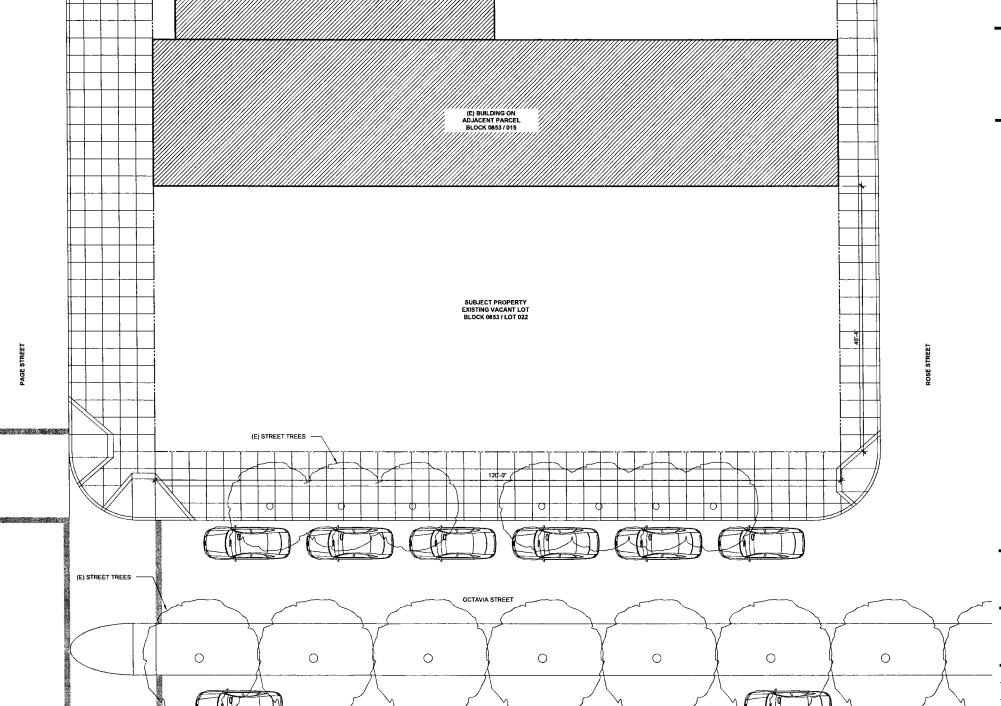

OCTAVIA BOULEVARD

P Co

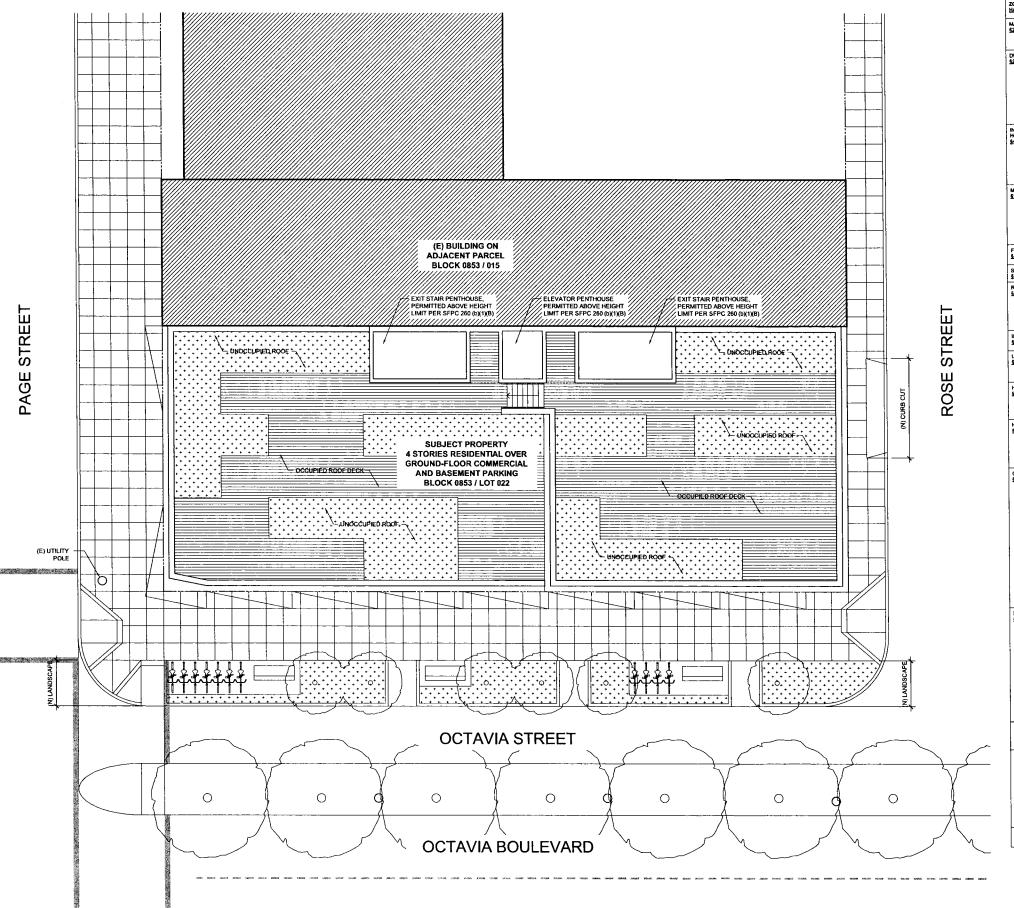

MAX DWELLING UNIT DENSITY MAXIMUM DWELLING UNIT DENSITY		UNLIMITED	0	26 UNITS
\$207.6	CONTROLLED BY HEIGHT, BULK, SETBACKS, OPEN SPACE AND DWELLING UNIT EXPOSURE.			!
DWELLING UNIT BEDROOM MIX \$207.6	NO LESS THAN 40% OF TOTAL PROPOSED DWELLING UNITS SHALL CONTAIN AT LEAST 2 BEDROOMS	STUDIO UNITS UNLIMITED	STUDIO UNITS 0 TOTAL (0%)	STUDIO UNI 10 TOTAL (4
	OR NO LESS THAN 30% OF TOTAL	1-BED UNITS UNLIMITED	1-BED UNITS 0 TOTAL (0%)	1-BED UNITS 8 TOTAL (20
	PROPOSED DWELLING UNITS SHALL CONTAIN AT LEAST 3 BEDROOMS	2-BED UNITS 40% REQUIRED	2-BED UNITS 0 TOTAL (0%)	2-BED UNITS 10 TOTAL (4
		UNLIMITED	0 TOTAL UNITS	26 UNITS
INCLUSIONARY AFFORDABLE HOUSING PROGRAM \$415.3	ANY HOUSING PROJECTS THAT CONSIST OF § 0 OR MORE UNITS IS SUBJECT TO THE INCLUSIONARY HOUSING PROGRAM WHICH REQUIRE ONE OF THE FOLLOWING. 20%, FEE 15% OF UNITS AFFORDABLE ON-SITE 20% OF UNITS AFFORDABLE OF-SITE	4 UNITS (15% OF 26 UNITS)	0	4 UNITS
MINIMUM LOT SIZE §121	LOT SIZE LOT WIDTH	10,000 SF MIN 25-0" MIN.	5,560 SF 120' OCTAVIA BLVD.	5,560 SF 120* OCTAVIA BI
			ROSE / PAGE	ROSE / PAG
	LOT FRONTAGE	16'-0" MIN.	212'-8"	212-8*
FRONT YARD SETBACK \$132	NONE REQUIRED	o-o	0.0	0-0
SIDE YARD SETBACK §133	NONE REQUIRED	NORTH: 0'-0" SOUTH: 0'-0"	NORTH: 0'-0" SOUTH: 0'-0"	NORTH: 0'-0
REAR YARD SETBACK \$139 (BN1)(C)	IN THE HAYES-GOUGH NOT, LOTS FROMING THE EAST SIDE OF COTAVIA BOULEVARD BETWEEN LINDER AND MARKET STREETS (CENTRAL FREEWAY PARCELS L. M. N. R. S. T. U. AND VI ARE NOT RECOURSED TO PROVIDE REAR YARDS AT ANY LEVEL OF THE BUILDING	NONE	NONE	NONE
BASIC FLOOR AREA RATIO \$124	NOT APPLICABLE FOR RESIDENTIAL USE	N/A	N/A	N/A
USABLE OPEN SPACE \$135	60 SF PER UNIT IF ALL PRIVATE. 80 SF PER UNIT IF ALL PUBLIC.	2,080 SF (80 SF * 26 UNITS)	0 SF	2.080 SF
HEIGHT LIMIT \$252	USE DISTRICT HEIGHT LIMIT 50-X. ADDITIONAL 5' HEIGHT ALLOWED FOR GROUND FLOOR ACTIVE USES PER 5263.18	55'-0" MAX	a-a.	56-0°
HEIGHT LIMIT EXEMPTIONS \$260 (b)(1)(B)	ELEVATOR, STAIR AND MECHANICAL PENTHOUSES, FIRE TOWERS, SKYLIGHTS AND DORMER WINDOWS EXEMPT FROM HEIGHT LIMITS FOR THE TOP 10 FEET OF SLOTH FEATURES WHERE THE HEIGHT LIMIT IS 65 FEET OR LESS.	10'-0" MAX ABOVE HEGHT LIMIT	o-o-	SEE DRAWINGS
OFF-STREET PARKING \$151.1	RESIDENTIAL USE: P UP TO ONE CAR FOR EACH TWO DWELLING UNITS: C UP TO 0.75 CARS FOR EACH DWELLING NITT, SUBJECT TO THE CRITERIA AND PROCEDURES OF SECTION \$15.1(16): NP 802VE 0.75 CARS FOR EACH DWELLING UNIT.	13 SPACES (.5 * 26 UNITS)	0 SPACES	0 SPACES
	NON-RESIDENTIAL USE: FOR USES IN TABLE 151 THAT ARE DESCRIBED AS A RAITO OF OCCUPIED FLOOR AREA, PUE TO 1 59ACE PER 1,500 SQUARE FRET OF OCCUPIED FLOOR AREA OR THE CUARMITY SPECIFIED IN TABLE 151, WHICHEVER IS LESS, AND SUBJECT TO THE COMOTIONS AND GOTERIA OF SECTION 131,11G) NP ABOVE.	1 SPACE (1,500 SF / 1,500 SF)	0 SPACES	0 SPACES
	TOTAL OFF-STREET PARKING:	14 SPACES	0 SPACES	0 SPACES
BICYCLE PARKING 5156.2	RESIDENTIAL USE: ONE CLASS 1 SPACE FOR EVERY DWELLING UNIT: FOR BUILDINGS CONTAINING MORE THAN 100 DWELLING UNITS, 50 CLASS 1 SPACES FULLO ONE CLASS 1 SPACE FOR EVERY FOUR TWELLING UNITS EVER FOUR TWELLING UNITS EVERY FOUR TW	26 SPACES	0 SPACES	26 SPACE
	RETAIL SALES, INCLUDING GROCERY STORES: ONE CLASS 1 SPACE FOR EVERY 7,500 SQUARE FEET OF OCCUPIED FLOOR	1 SPACE	0 SPACES	1 SPACE
	AREA. TOTAL BICYCLE PARKING:	27 SPACES	0 SPACES	27 SPACE
STREET TREE STREET TREES SHALL BE REQUIRED UNGER THE FOLLOWING CONDITIONS, CONSTRUCTION OF A NEW BUILDING; RELOCATION OF A BUILDING; THE ADDITION OF GROSS FLOOR AREA EQUIAL TO 20% OR MORE OF THE GROSS FLOOR AREA OF AN EXISTING BUILDING; THE ADDITION OF A NEW WELLING UNIT A CAPACIC OF DEPENDENT OF A SHALL OF A SHALL OF A NEW BUILDING; THE ADDITION OF A NEW REPAYING JUNG CHARGE, ON OR REPAYING JUNG THAN 200 SQUARE FEET OF THE FROM STETRING		m	m	m
PERMITTED OBSTRUCTIONS	SEE DRAWINGS	NA	N/A	SEE

 1		
I		

NO: DATE: SUBMISSION:

ISSUED FOR PPA

EDMONDS + LEE ARCHITECTS, INC. 2601 Missian St., 400A San Francisco. CA 94110 T 415 - 285 - 1300 www.edmondslee.com

PROJECT:

OCTAVIA BLVD. PARCEL T BLOCK 0853, LOT 022 SAN FRANCISCO, CA 94102

SITE PLAN, ZONING AND DATA CALCULATIONS

1/8" = 1'-0"
SEPTEMBER 12, 2014
2014.12






BIRDSEYE VIEW OF SUBJECT PROPERTY
SCALE: N.T.S.





VIEW FROM CORNER OF OCTAVIA AND ROSE SCALE: N.T.S. (03)

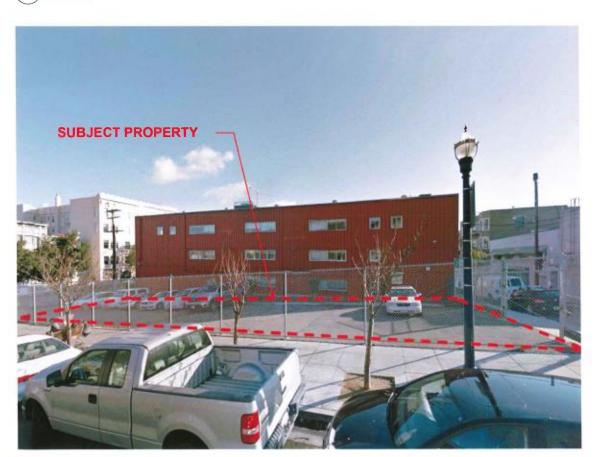

VIEW FROM OCTAVIA BOULEVARD SCALE: N.T.S.

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PROJECT:

OCTAVIA BLVD. PARCEL T BLOCK 0853, LOT 022 SAN FRANCISCO, CA 94102

DRAWING:

SITE PHOTOS

SCALE: AS NOTED DATE: SEPTEMBER 12, 2014 JOB NO. DRAWN: CAD FILE:

A0.20



BIRDSEYE VIEW OF PROPOSED BUILDING SCALE: N.T.S.





BIRDSEYE VIEW OF PROPOSED BUILDING SCALE: N.T.S.



VIEW FROM CORNER OF OCTAVIA AND ROSE SCALE: N.T.S.

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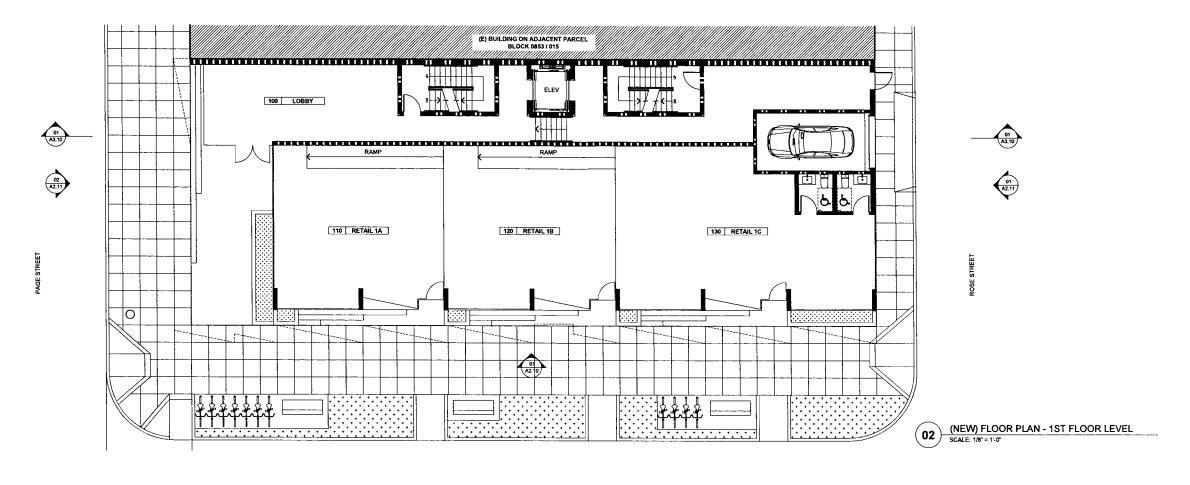
PROJECT:


OCTAVIA BLVD. PARCEL T BLOCK 0853, LOT 022 SAN FRANCISCO, CA 94102

CONCEPT RENDERINGS

SCALE:	AS NOTED
DATE:	SEPTEMBER 12, 2014
JOB NO.	2014.12
DRAWN:	
CAD FILE:	

A0.30



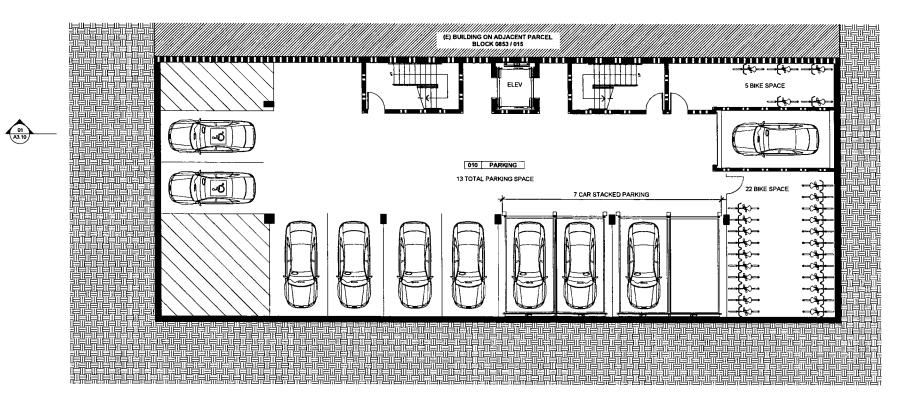

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WALL LEGEND:

WALL TO DEMOLISH

(EXIST.) WALL

(NEW) WALL

1-HR WALL

2-HR WALL


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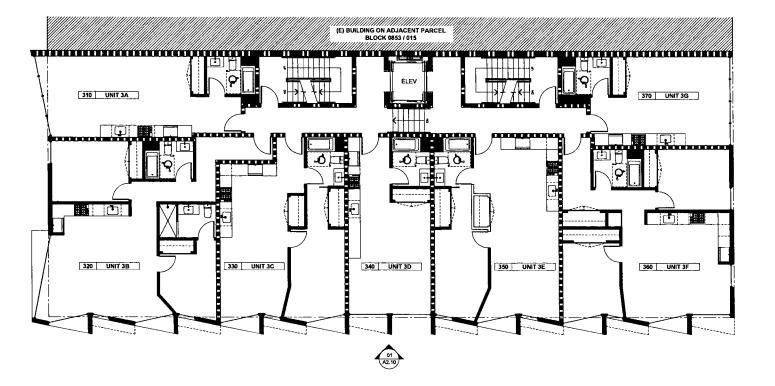
OCTAVIA BLVD. PARCEL T BLOCK 0853, LOT 022 SAN FRANCISCO, CA 94102

DRAWIN

FLOOR PLANS

SCALE:	1/8" = 1'-0"
DATE:	SEPTEMBER 12, 2014
JOB NO.	2014.12
DRAWN:	
CAD FILE:	



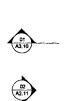






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(NEW) FLOOR PLAN - 3RD FLOOR LEVEL
SCALE: 1/8" = 1'-0"









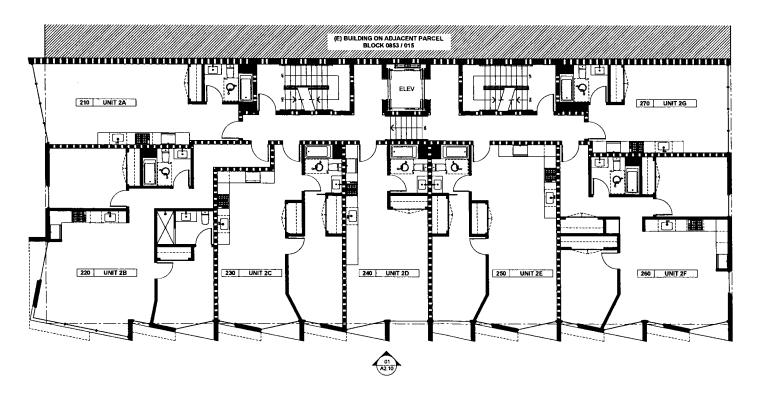

WALL LEGEND:	
	WALL TO DEMOLISH
	(EXIST.) WALL
	(NEW) WALL
	1-HR WALL
	2-HR WALL


OCTAVIA BLVD. PARCEL T BLOCK 0853, LOT 022 SAN FRANCISCO, CA 94102


DRAWING:

FLOOR PLANS

SCALE:	1/8" = 1'-0"
DATE:	SEPTEMBER 12, 2014
JOB NO.	2014.12
DRAWN:	
CAD FILE:	



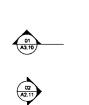

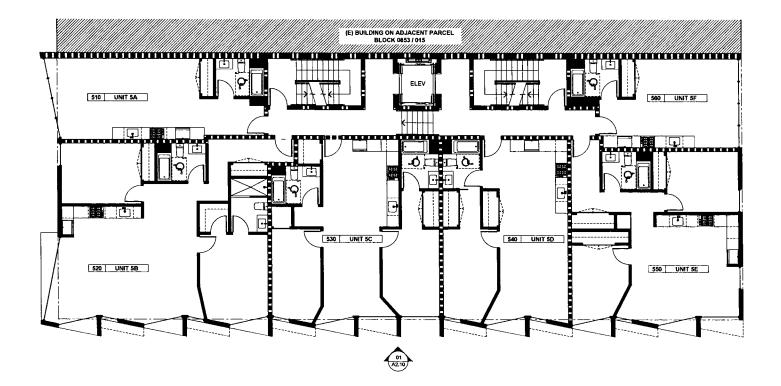





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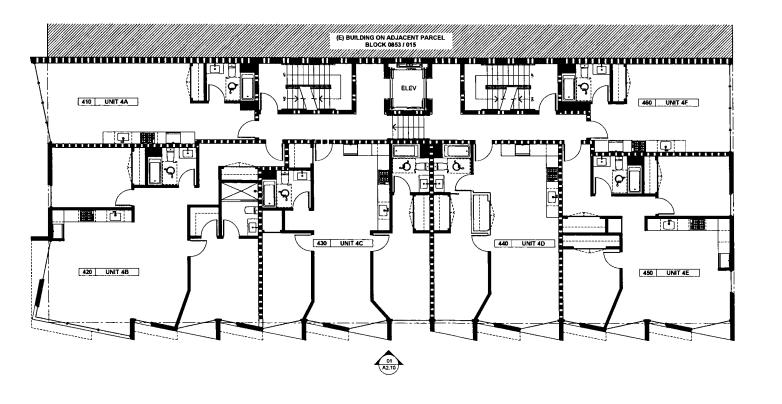
ISSUED FOR PPA

ROSE STRE

(NEW) FLOOR PLAN - 5TH FLOOR LEVEL
SCALE: 1/8" = 1'-0"











OSE STREE

WALL LEGEND:	
	WALL TO DEMOLISH
	(EXIST.) WALL
	(NEW) WALL
	1-HR WALL
11 11	2-HR WALL

OCTAVIA BLVD. PARCEL T BLOCK 0853, LOT 022 SAN FRANCISCO, CA 94102

DRAWIN

FLOOR PLANS

SCALE:	1/8" = 1'-0"
DATE:	SEPTEMBER 12, 2014
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DRAWN:	
CAD FILE:	



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WALL LEGEND.

WALL TO DEMOLISH

(EXIST.) WALL

(NEW) WALL

1-HR WALL

2-HR WALL





DI

FLOOR PLANS

SCALE:	1/8" = 1'-0"
DATE:	SEPTEMBER 12, 2014
JOB NO.	2014.12
DRAWN:	
CAD FILE:	

OCTAVIA BLVD, PARCEL T BLOCK 0853, LOT 022 SAN FRANCISCO, CA 94102

COCUPED ROOF DECK

OSE STREET

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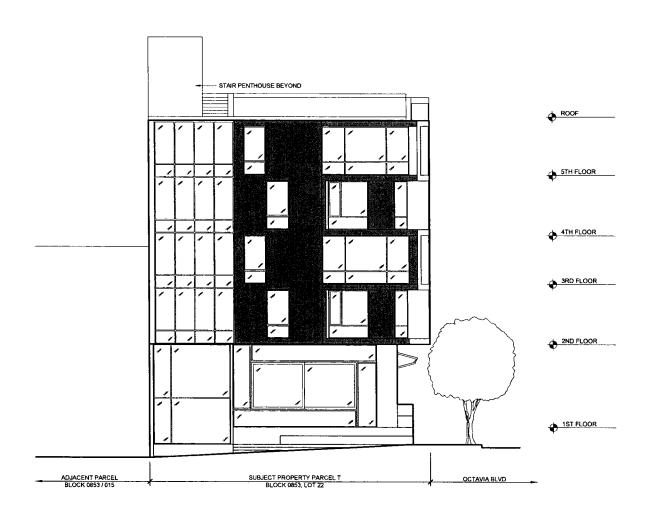
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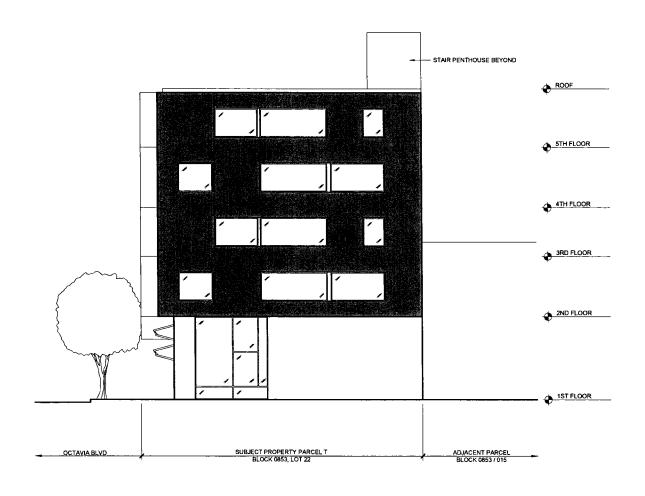
EXTERIOR ELEVATION (NEW)

SCALE:	1/8" = 1'-0"
DATE:	SEPTEMBER 12, 2014
JOB NO.	2014.12
DRAWN:	
CAD FILE:	

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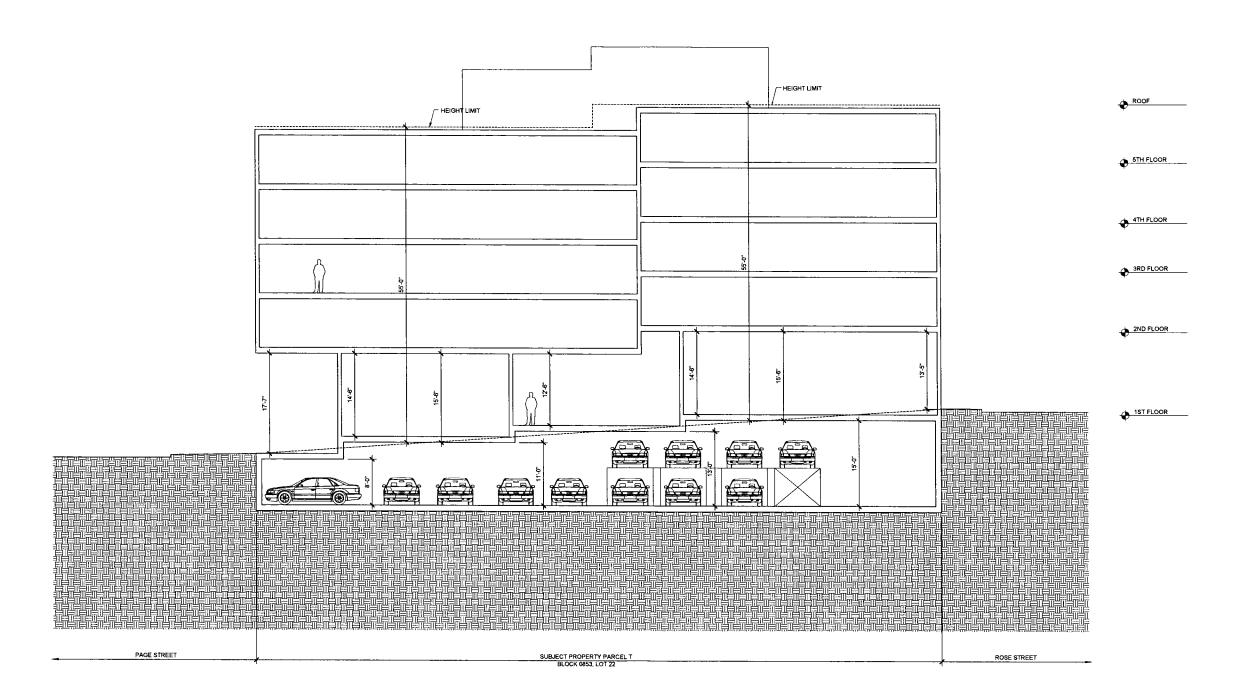
PROJECT:

OCTAVIA BLVD. PARCEL T BLOCK 0853, LOT 022 SAN FRANCISCO, CA 94102

DRAWING

EXTERIOR ELEVATION (NEW)

SCALE:	1/8" = 1'-0"
DATE:	SEPTEMBER 12, 2014
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DRAWN:	
CAD FILE:	



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PROJEC

OCTAVIA BLVD. PARCEL T BLOCK 0853, LOT 022 SAN FRANCISCO, CA 94102

DRAWING

BUILDING SECTION (NEW)

SCALE:	1/8" = 1'-0"
DATE:	SEPTEMBER 12, 2014
JOB NO.	2014.12
DRAWN:	
CAD FILE:	

A3.10